
# CITY OF HOUSTON

# HOUSTON PUBLIC WORKS


# SHARPSTOWN AREA DETENTION

POND A

WBS NO. M-410040-001A-4

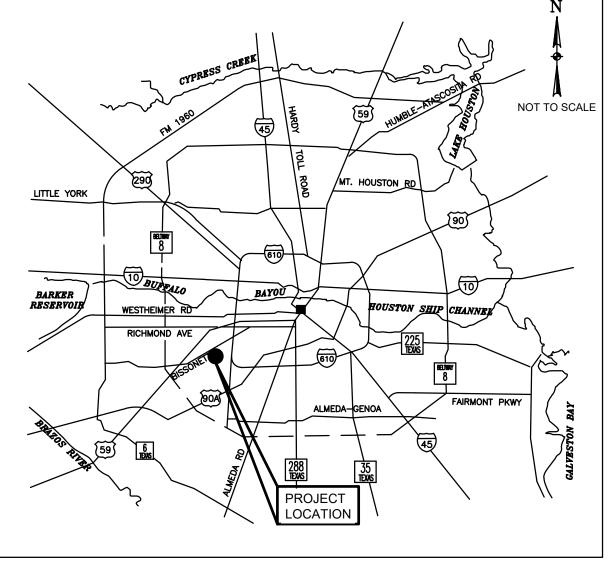

**LOCATION MAP** 

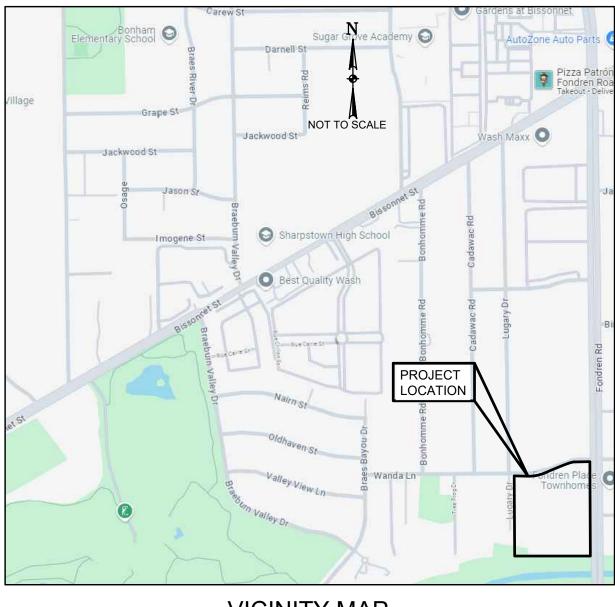

**VICINITY MAP** KEY MAP NO.: 530U CITY COUNCIL DISTRICT J

| TDLR EABPR |  |
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HCFCD PROJECT ID #D100-00-00-Y020



MAYOR JOHN WHITMIRE CONTROLLER CHRIS HOLLINS

## DISTRICT COUNCIL MEMBERS

AMY PECK DISTRICT A FRED FLICKINGER TIFFANY D. THOMAS

DISTRICT E

JOAQUIN MARTINEZ

DISTRICT I

TARSHA JACKSON DISTRICT B

DISTRICT F

EDWARD POLLARD

DISTRICT J

ABBIE KAMIN CAROLYN EVANS-SHABAZZ DISTRICT C DISTRICT D MARY NAN HUFFMAN MARIO CASTILLO

DISTRICT H

DISTRICT G MARTHA CASTEX-TATUM DISTRICT K

## COUNCIL MEMBERS AT-LARGE

JULIAN RAMIREZ POSITION 1

> TWILA CARTER LETITIA PLUMMER POSITION 3 POSITION 4

WILLIE DAVIS

POSITION 2

SALLIE ALCORN POSITION 5

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| VO.                     | DATE   | RE                        | VISION      |   | AP   |
| 15021<br>HOUST<br>281-9 | CIVIL ENGINEERS. INC.  KATY FREEWAY, STE. 500 ON, TX. 77094 945-0069 RM NUMBER: F-6932 |                           |             | THIS DOCUME RELEASED FOR F OF INTERIM REVIE THE AUTHORIT RODRIGO GUADA TEXAS REG. NO. October 17, | PURPOS<br>W UND<br>Y OF<br>ARRAMA<br>11143 |
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| -<br>F                  | PARKS—FORE   | STRY DEPT.                |             |   |  |
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| T                       | RANSPORTA  | TION & DRAIN              | AGE OPERA   | TIONS   |  |
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| CIT                     | Y ENGINEER   | DATE                      | FOR CITY OF | HOUSTON USE   | ONLY                                       |
| НС                      | RECTOR OF<br>OUSTON PUBL   | DATE IC WORKS F 42 SHEETS |             |   |  |

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| 30 SWPPP H.C.F.C.D. DETAILS 31 SWPPP FLOATING TURBIDITY CURTAIN DETAILS 32 TREE PROTECTION PLAN (1 OF 3) 33 TREE PROTECTION PLAN (2 OF 3) 34 TREE PROTECTION PLAN (3 OF 3) 35 TCP FONDREN ROAD OVERALL PLAN 36 TCP FONDREN ROAD DETENTION POND (1 OF 2) 37 TCP FONDREN ROAD DETENTION POND (2 OF 2) 38 TCP STANDARD DETAILS (1 OF 3) 39 TCP STANDARD DETAILS (2 OF 3) 40 TCP STANDARD DETAILS (3 OF 3) 41 SUMMARY OF QUANTITIES  | 28       | SWPPP LAYOUT (2 OF 2)                    |
| 31 SWPPP FLOATING TURBIDITY CURTAIN DETAILS 32 TREE PROTECTION PLAN (1 OF 3) 33 TREE PROTECTION PLAN (2 OF 3) 34 TREE PROTECTION PLAN (3 OF 3) 35 TCP FONDREN ROAD OVERALL PLAN 36 TCP FONDREN ROAD DETENTION POND (1 OF 2) 37 TCP FONDREN ROAD DETENTION POND (2 OF 2) 38 TCP STANDARD DETAILS (1 OF 3) 39 TCP STANDARD DETAILS (2 OF 3) 40 TCP STANDARD DETAILS (3 OF 3) 41 SUMMARY OF QUANTITIES  | 29       | SWPPP C.O.H. DETAILS                     |
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| TREE PROTECTION PLAN (2 OF 3)  TREE PROTECTION PLAN (3 OF 3)  TOP FONDREN ROAD OVERALL PLAN  TOP FONDREN ROAD DETENTION POND (1 OF 2)  TOP FONDREN ROAD DETENTION POND (2 OF 2)  TOP STANDARD DETAILS (1 OF 3)  TOP STANDARD DETAILS (2 OF 3)  TOP STANDARD DETAILS (3 OF 3)  SUMMARY OF QUANTITIES  | 31       | SWPPP FLOATING TURBIDITY CURTAIN DETAILS |
| TREE PROTECTION PLAN (3 OF 3)  TCP FONDREN ROAD OVERALL PLAN  TCP FONDREN ROAD DETENTION POND (1 OF 2)  TCP FONDREN ROAD DETENTION POND (2 OF 2)  TCP STANDARD DETAILS (1 OF 3)  TCP STANDARD DETAILS (2 OF 3)  TCP STANDARD DETAILS (3 OF 3)  SUMMARY OF QUANTITIES   | 32       | TREE PROTECTION PLAN (1 OF 3)            |
| TCP FONDREN ROAD OVERALL PLAN TCP FONDREN ROAD DETENTION POND (1 OF 2) TCP FONDREN ROAD DETENTION POND (2 OF 2) TCP STANDARD DETAILS (1 OF 3) TCP STANDARD DETAILS (2 OF 3) TCP STANDARD DETAILS (3 OF 3) SUMMARY OF QUANTITIES  | 33       | TREE PROTECTION PLAN (2 OF 3)            |
| TCP FONDREN ROAD DETENTION POND (1 OF 2) TCP FONDREN ROAD DETENTION POND (2 OF 2) 38 TCP STANDARD DETAILS (1 OF 3) TCP STANDARD DETAILS (2 OF 3) 40 TCP STANDARD DETAILS (3 OF 3) SUMMARY OF QUANTITIES  | 34       | TREE PROTECTION PLAN (3 OF 3)            |
| TCP FONDREN ROAD DETENTION POND (2 OF 2)  38 TCP STANDARD DETAILS (1 OF 3)  39 TCP STANDARD DETAILS (2 OF 3)  40 TCP STANDARD DETAILS (3 OF 3)  41 SUMMARY OF QUANTITIES   | 35       | TCP FONDREN ROAD OVERALL PLAN            |
| TCP STANDARD DETAILS (1 OF 3)  TCP STANDARD DETAILS (2 OF 3)  40 TCP STANDARD DETAILS (3 OF 3)  41 SUMMARY OF QUANTITIES   | 36       | TCP FONDREN ROAD DETENTION POND (1 OF 2) |
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| 40 TCP STANDARD DETAILS (3 OF 3) 41 SUMMARY OF QUANTITIES  | 38       | TCP STANDARD DETAILS (1 OF 3)            |
| 40 TCP STANDARD DETAILS (3 OF 3) 41 SUMMARY OF QUANTITIES  | 39       | TCP STANDARD DETAILS (2 OF 3)            |
| 41 SUMMARY OF QUANTITIES   |          | · · · · · · · · · · · · · · · · · · ·    |
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THIS DOCUMENT IS
RELEASED FOR PURPOSE
OF INTERIM REVIEW UNDER
THE AUTHORITY OF
RODRIGO GUADARRAMA
TEXAS REG. NO. 111437
OCTOBER 15, 2025

SURVEYED BY: LANDTECH, INC. FB NO. P-6331

IT IS NOT TO BE USED FOR CONSTRUCTION PURPOSES

CITY OF HOUSTON HOUSTON PUBLIC WORKS

SHARPSTOWN AREA DETENTION POND A

SHEET INDEX

|     | WBS NUMBER                | FOR CITY OF HOUSTON USE ONLY |
|-----|---------------------------|------------------------------|
|     | M-410040-001A-4           |                              |
|     | DRAWING SCALE             |                              |
|     | AS NOTED                  |                              |
|     | CITY OF HOUSTON PM        |                              |
|     | SUPUN ILANGAMUDALIGE P.E. |                              |
| 020 | SHEET NO. 2 OF 42         |                              |

| I. LOCATION INFORMATION   | I. PROPOSED DRAINAGE AREA   | I. SWPPP: CONSTRUCTION MEASURES. (Must complete)   | I. GENERAL INFORMATION   |
|---|---|--|--|
| A. HARRIS COUNTY COMMISSIONER'S PRECINCT:   | ▼ NEW DEVELOPMENT AREA: REGIONAL DETENTION POND  □ RE-DEVELOPMENT AREA (AMOUNT INCREASED IMPERVIOUS AREA): N/A  □ NEW DEVELOPMENT AREA (AMOUNT INCREASED IMPERVIOUS AREA): N/A  □ NEW DEVELOPMENT AREA: REGIONAL DETENTION POND  □ N | ☐ DISTURBS >1AC. SITE PLAN & DETAILS ON SHEET(S)   | FIRM PANEL(S) FOR PROPERTY: <u>48201C0845M</u> FIRM PANEL(S) DATE: <u>MAY 2, 2019</u>  |
| B. KEY MAP: 530 U   | LOW IMPACT DEVELOPMENT (LID)  | ☐ DISTURBS <1AC. N/A   | STATUS OF PROPERTY ON MAP  |
| C. ADDRESS: FAIRMONT PARKWAY @ ARMAND BAYOU   | METHOD/DESCRIPTION N/A  |  | □ ENTIRELY LOCATED IN UNSHADED ZONE "X" □ LOCATED PARTIALLY OR ENTIRELY IN ANY "A" ZONE OR SHADED ZONE "X", □ DELINEATE FLOODPLAIN BOUNDARY ON CONSTRUCTION DRAWINGS   |
| 6950 SOUTHEAST FAIRMONT PARKWAY, PASADENA, TXAS 77505   |   | *II. APPLICABILITY FOR PERMANENT FEATURES. (Must complete)   | (DRAINAGE LAYOUT PG. NO) (1% BASE FLOOD LEVEL65.30)  |
| II. LEGAL DESCRIPTION   |   | EXEMPT NEW DEVELOPMENT:  | (0.2% BASE FLOOD LEVEL)  |
| A. ACREAGE: 7.71 AC   | II. METHODOLOGY   | □ PROJECT IS ON A PARCEL (A COMMON PLAN OF DEVELOPMENT)<br>LESS THAN 5 ACRES. (Must be verified with plat)   | ☐ SITE REMOVED FROM FLOODPLAIN BY LOMR, LOMR—F, LOMA CASE NO REVISED FLOODPLAIN IS SHOWN ON SHEET  |
| B.   SUBDIVISION: FONDREN VILLAGE PHASE D   | HCFCD PCPM DETENTION METHOD USED:   | EXEMPT REDEVELOPMENT:  | ELEVATION INFORMATION  |
| CUDVEY 0. ADSTRACT.   | METHOD 1 (LESS THAN 20 ACRES)   | PROJECT DOES NOT MEET THE DEFINITION OF SIGNIFICANT  | BENCHMARK USED  Mark USED  HARRIS COUNTY FLOODPLAIN REFERENCE MARK   |
| SURVEY & ABSTRACT:  | ☐ METHOD 2 (20 ACRES TO 640 ACRES)  | REDEVELOPMENT (Part A,Sec. 2.39 of Regulations of Harris County,<br>Texas for Stormwater Quality Management) | HARRIS-GALVESTON COASTAL SUBSIDENCE DISTRICT BENCHMARK (FOR COASTAL AREAS) DESCRIPTION OF BENCHMARK INCLUDING ELEVATION, DATUM AND YEAR OF ADJUSTMENT (2024 ADJ.) CITY OF HOUSTON CITY SURVEY 50538115 SITE CONTROL  |
|   | ☐ METHOD 3 (GREATER THAN 640 ACRES)   | EXEMPT GRANDFATHERED:  | DESCRIPTION OF BENCHMARK INCLUDING ELEVATION, DATUM AND YEAR OF ADJUSTMENT (2024 ADJ.) CITY OF HOUSTON CITY SURVEY 50538115 SITE CONTROL   |
| C. ADJACENT ROADS: FONDREN RD & WANDA LANE  | □ OTHER   | ☐ PROJECT'S DRAINAGE TIES <u>DIRECTLY</u> INTO AN EXISTING DRAINAGE  | MONUMENT MONUMENT  |
| III DI ATTINIC  | III. DETENTION VOLUME & OUTFALL   | SYSTEM PRIOR TO OCTOBER 1, 2001.   | II. FLOOD PLAIN DETERMINATION BASED ON GROUND ELEVATION  |
| III. PLATTING  A. SUBDIVISION PLAT  B. STREETS PROPOSED   | OUTFALL TO:   | (FOR VERIFICATION: PROVIDE ORIGINAL DRAINAGE AREA MAP INCLUDING CALCULATIONS)                                | □ PROPERTY LIES ENTIRELY ABOVE THE BASE FLOOD LEVEL AND IN SHADED ZONE "X" □ PROPERTY LIES PARTIALLY OR ENTIRELY BELOW THE BASE FLOOD  |
| ☐ PROPOSED PLAT / REPLAT ☐ PUBLIC   | .65, H.C.F.C.D. CHANNEL, (H.C.F.C.D. UNIT NO.)  | GENERAL:   | ☐ PROPERTY LIES PARTIALLY OR ENTIRELY BELOW THE BASE FLOOD   |
| ☐ RECORDED PLAT / REPLAT ☐ PRIVATE ☐ PUBLIC & PRIVATE   |   | ☑ PROJECT'S SWQ REQUIREMENTS FALL WITHIN THE JURISDICTION OF:  |  |
| PLAT NAME:  |   | HCFCD  | III. FLOODPLAIN STORAGE SUMMARY  |
| FONDREN VILLAGE PHASE D   | 1.00, ROADSIDE DITCH, (OWNER & ROAD NAME)   | ☐ STORMWATER QUALITY PERMIT REQUIREMENT IS COVERED BY AN<br>EXISTING SWQMP WITHIN PROJECT TITLE:             | (APPLIES ONLY TO PORTION OF LAND LOCATED WITHIN FEMA REGULATORY FLOODPLAIN).  A. TOTAL VOLUME OF MATERIAL PROPOSED TO BE MOVED OR PLACED WITHIN  |
|   | <u> </u>  |  | THE FIRM DELINEATED FLOODPLAIN (FILL, BASE, CONCRETE, ASPHALT, ETC.):  |
| <u>IV. JURISDICTIONS</u>  | OTHER (OWNER & OPERATOR)INTERLOCAL AGREEMENT BETWEEN COH AND HCFCD  | HARRIS COUNTY PROJECT No & SWQ PERMIT No.  | BELOW 0.2% BASE FLOOD ELEVATION (2001 ADJ.) CUBIC YARDS  |
| ☐ CITY OF HOUSTON ☐ ETJ, CITY OF HOUSTON  |   | STORMWATER QUALITY MANAGEMENT PLAN:  | B. TOTAL VOLUME OF MATERIAL PROPOSED TO BE REMOVED FROM THE FIRM DELINEATED FLOODPLAIN:  |
| ☐ ETJ, CITY OF  | IV. STORMWATER DETENTION BASIN INFORMATION  | ☐ SITE PLAN ON SHEET(S)  | BELOW 0.2% BASE FLOOD ELEVATION (2001 ADJ.)61.25_AC-FOUBIC YARDS 61.25 AC-FT   |
| ☐ NO ETJ ☐ UTILITY DISTRICT (NAME)  | A. HCFCD PCPM SUMMARY TABLE SEE SHEET OF THESE PLANS.   |  | INCLUDING CALCULATIONS)  C. FILL AREA & VOLUME CALCULATIONS ARE SHOWN ON SHEET 13  |
|   | DETENTION BASIN SERVICE AREA acres  | III. PERMANENT SWQ FEATURES. (COMPLETE IF NOT EXEMPT)  | O. THE AREA & VOLUME CALCULATIONS ARE SHOWN ON SHEET 13  |
| V. HCAD ACCOUNT NOS. (ALL)  | 50% EXCEEDANCE 10% EXCEEDANCE 1% EXCEEDANCE STORM EVENT (2-YEAR) (10-YEAR)  | ☐ VEGETATIVE CONTROLS USED: (FILTER STRIP, GRASSY SWALE,   |  |
|   | MAXIMUM ALLOWABLE OUTFLOW (PRE— DEVELOPMENT PEAK FLOW)  | URBAN FORESTRY DETAILS AND CALCULATIONS APPEAR ON  |  |
| <del></del>   | MAXIMUM OUTFLOW PROVIDED (PEAK FLOW FROM BASIN)   | SHEET(S)  Dond Structure used (wet, dry, wetlands) details and   |  |
|   | LOWEST NATURAL/FINISHED GROUND OR FINISHED FLOOR ELEVATION ESTIMATE   | CALCULATIONSAPPEAR ON SHEET(S)   |  |
|   | DESIGN WATER SURFACE ELEVATION  | ☐ HYDRODYNAMIC TYPE SEPARATOR MODEL:   |  |
|   | MINIMUM STORAGE REQUIRED (ac-ft)  | ☐ OTHER(S):  |  |
|   | DETENTION STORAGE PROVIDED (go-ft)  |  | HCFCD SIGNATURE BLOCK  |
| 5. WORK IN HCFCD RIGHT-OF-WAY   | STORAGE RATE PROVIDED (ac-ft/ac)  |  | PROJECT NAME: SHARPSTOWN AREA DETENTION POND A   |
| 3. WORK IN HEFED KIGHT-OF-WAT   | OUTFLOW VELOCITY INTO CHANNEL   |  |  |
| I. TYPE OF WORK TO BE PERFORMED IN HCFCD ROW  | DRAIN JIME - 1% ONLY (hours)  |  | ADDRESS:9100 FONDREN RD  WAS ACCEPTED BY HARRIS COUNTY FLOOD CONTROL DISTRICT FOR THE PURPOSES LISTED BELOW:   |
| A. BOND/NOTIFICATION INFORMATION  | EMERGENCY OVERFLOW (TYPE, SIZE, ELEVATION, ETC.)  | ( DEDODEC/ACDEEMENTS   |  |
| ☐ HCFCD WATERSHED X ☐ HCFCD UNIT No. D100-00  | B. DETENTION BASIN TO BE MAINTAINED BY _HCFCD   | 6. REPORTS/AGREEMENTS  | HARRIS COUNTY FLOOD CONTROL DISTRICT   |
| □ NUMBER OF OUTFALLS <u>1</u>   | 6. DETENTION SERVICE AREA MAP ON SHEET  | I. HCFCD ACCEPTED REPORTS (ALL)  | INTERPOSE NO OBJECTION   |
| ☐ UTILITY CROSSING ☐ ROADWAY BRIDGE/CULVERT CROSSING  | D. ADDITIONAL CRITERIA FOR PUMPED DETENTION BASINS  | STORMWATER DRAINAGE DESIGN REPORT  | FOR ITEMS LOCATED OUTSIDE OF HCFCD RIGHT-OF-WAY  |
| ☐ FILL ACTIVITY   | VOLUME OF PUMPED 1% EXCEEDANCE STORAGE VOLUME = ACFT% OF TOTAL VOLUME   | REPORT TITLE BRAEBURN GLEN DRAINAGE IMPROVEMENTS   | APPROVED:  |
| ☐ REHABILITATION OF CHANNEL ☐ MAINTENANCE   | MAXIMUM DESIGN OUTFLOW VELOCITY INTO HCFCD CHANNEL =FT/SEC  DRAIN TIME FOR BASIN = HOURS BASED ONHEAD CONDITIONS  | HCFCD PROJECT #M-410040-001A-4_  | BY FOR ITEMS LOCATED WITHIN EXISTING HCFCD RIGHT-OF-WAY  |
| TEMPORARY CROSSING  |   | ENGINEERING FIRM ENTECH CIVIL ENGINEERS, INC   | APPROVED:  |
| □ TRAIL (LENGTH)<br>□ OTHER   | V. DETENTION PROVIDED IN OTHER PLANS:  HCFCD PROJECT No DATE SIGNED BY HCFCD:   | REPORT ACCEPTANCE DATE MARCH 11, 2025  | BY FOR ITEMS LOCATED WITHIN PROPOSED HCFCD RIGHT-OF-WAY  |
| COST OF WORK IN HCFCD ROW   | PLAN TITLE DATE SIGNED BY HEFED:  | GEOTECHNICAL INVESTIGATION REPORT REPORT TITLE GEOTECHNICAL INVESTIGATION—SHARPSTOWN AREA DETENTION BASIN    | NO REVIEW REQUIRED:  |
|   | DETENTION POND SERVICE AREA MAP IS PROVIDED ON SHEET  |  | BY   |
| II. USACE ENVIRONMENTAL PERMIT  US ARMY CORPS OF ENGINEERS NATIONWIDE   | ENGINEERING FIRM  | HCFCD PROJECT #M-410040-001A-4_<br>ENGINEERING FIRM AVILES ENGINEERING CORPORATION                           | FINAL PERMITTING BY OTHERS   |
| PERMIT NUMBER(S)  |   | REPORT ACCEPTANCE DATE JANUARY 2025  | ADDITIONAL COMMENTS:   |
| ☐ US ARMY CORPS OF ENGINEERS INDIVIDUAL PERMITS ☐ OTHER   | VI. FLOW RESTRICTOR SIZE  OUTFALL PIPE SIZE: 24" RCP  | HCFCD APPROVED VARIANCE  |  |
|   | RESTRICTOR PIPE SIZE: 24" RCP   | DESCRIPTION OF VARIANCE  |  |
| EXPLAIN:  NO JURISDICTIONAL WETLANDS VERIFIED BY THE USACE WILL BE IMPACTED   | RESTRICTOR PLATE DIMENSION:   | DOCUMENT ID #  |  |
|   | VII. DETENTION PROVIDED BY  | VARIANCE ACCEPTANCE DATE   |  |
| ·   | REGIONAL DETENTION BASIN SYSTEM (APPROVED H.C. PRJ NO.):  | U AODEEMENT TYPE A N   | THE PROJECT WAS REVIEWED, HOWEVER, THIS DOES NOT MEAN THE ENTIRE PROJECT, INCLUDING ALL SUPPORTING DATA AND CALCULATIONS HAVE BEEN COMPLETELY CHECKED AND VERIFIED. THESE DRAWINGS ARE SIGNED, DATED AND SEALED  |
| III. REFERENCE / BASIS OF DETERMINATION   |   | II. AGREEMENT TYPE & No.;  | BY A PROFESSIONAL ENGINEER LICENSED TO PRACTICE IN THE STATE OF TEXAS, WHICH THEREFORE CONVEYS THE ENGINEER'S RESPONSIBILITY AND ACCOUNTABILITY. THIS DOES NOT RELIEVE ANY PARTY FROM COMPLYING WITH APPROPRIATE FEDERAL, STATE AND LOCAL ENVIRONMENTAL RULES, LAWS, AND REGULATIONS AND ANY OTHER LEGALLY ADOPTED REGULATION OR ORDINANCE |
| □ ENVIRONMENTAL CONSULTANT REPORT   | FOR PROJECTS LOCATED IN ANY FLOODPLAIN  |  | RELATED TO LAND DEVELOPMENT. IF THE CITY SIGNATURES ARE REQUIRED BY ORDINANCE, COUNTY PERMITS WILL NOT BE ISSUED  UNTIL SUCH SIGNATURES ARE OBTAINED. PLAN APPROVAL EXPIRATION TO BE IN ACCORDANCE WITH LOCAL GOVERNEMENT CODE CH. 2   |
| BY<br>REPORT_TITLE  | Development constructed or placed in accordance with these plans will comply with all   | ☐ TURF ESTABLISHMENT   | ENGINEER'S CERTIFICATION   |
| REPORT DATE   | provisions of the designated Floodplain Administrator.  No net fill is allowed in the flood plain and no fill is allowed in the floodway.   |  | I, RODRIGO GUADARRAMA, A LICENSED PROFESSIONAL ENGINEER IN THE STATE OF TEXAS, DO HEREBY CERTIF  |
| ☑ OTHER FOLLOWED OHWM DELINEATION FOR SECTION 404 WATERS  |   |  | THAT THE INFORMATION PRESENTED ON THIS SHEET IS TRUE AND CORRECT TO THE BEST OF MY KNOWLEDGE   |
| NOTES:  |   |  | AND THAT I AM NOT VIOLATING ANY PROVISION OF THE CURRENT TEXAS ENGINEERING PRACTICE ACT AND RUL CONCERNING THE PRACTICE OF ENGINEERING AND PROFESSIONAL ENGINEERING LICENSURE.   |
| I. — III. REQUIRED ON PROJECTS WITH WORK IN A HCFCD CHANNEL.  PLEASE REFERENCE SECTION 17 OF THE FLOOD CONTROL DISTRICT  POLICY, CRITERIA, AND PROCEDURE MANUAL FOR MORE INFORMATION. | OFFSITE SHEET FLOW: (100 YEAR)  |  | ANY VIOLATIONS WILL BE FORWARDED TO THE HARRIS COUNTY DISTRICT ATTORNEY'S OFFICE FOR PROSECUTION   |
| POLICY, CRITERIA, AND PROCEDURE MANUAL FOR MORE INFORMATION.  | OFFSITE SHEET FLOW MAPPING, TOTAL DISCHARGE CALCULATIONS, AND DESIGN ACCOMODATIONS ARE SHOWN ON SHEET OR, AS PRESENTED  |  | THE COMPLETED PROJECT CONSISTS OF DRAWING SHEETS 1 THRU 42. SEAL   |
| IV. HCFCD STANDARD NOTES: SEE SHEET $-4-5$ OF THESE PLANS.  | IN THE APPROVED DRAINAGE STUDY ENTITLED   |  | Rodrigo Goodassama 10/17/2025  |
| V. HCFCD STANDARD DETAILS: SEE SHEET 21-23 OF THESE PLANS.  | TOTAL ACREAGE =   |  | SIGNATURE DATE   |
|   | TOTAL DISCHARGE =   |  |  |
| VI. HCFCD ACCESS PLAN: SEE SHEET OF THESE PLANS.  | NOTE: ALL OFFSITE SHEET FLOW FROM ADJACENT PROPERTIES MUST BE IDENTIFIED AND PROPERLY ACCOUNTED FOR IN THE PROJECT. THE SIGNING   |  | REVISIONS  |
| VII. REFER TO THE FOLLOWING PLAN SHEETS: 12  FOR EXISTING AND PROPOSED RIGHT(S) OF WAY INCLUDING DELINEATION AND  | ENGINEER HEREBY CERTIFIES THAT THESE AREAS HAVE BEEN ADDRESSED.   |  | NOTE: REVISION BLOCK IS TO BE USED ONLY FOR CHANGES MADE <u>AFTER</u> PLANS HAVE BEEN APPROVED BY HARRIS COUNTY FLOOD CONTROL.   |
| RECORDING INFORMATION PER HCFCD POLICY, CRITERIA, & PROCEDURE MANUAL (i.e., DRAINAGE EASEMENT, FEE STRIP, ETC.) AND GRANTEE (e.g. COH, HCFCD, PUBLIC, TXDOT, ETC.)                    |   | DATE   | SHEET NO. DESCRIPTION P.E. INITIAL H.C.F.C.D APPROVED DATE   |
| ,   |   |  |  |
|   | HARRIS COUNTY   |  |  |
|   | IIMMO COUNT   |  |  |

2. SITE DETENTION DRAINAGE

FLOOD CONTROL DISTRICT

REVIEW SHEET

3. SWQ DISCHARGE INTO FCD FACILITY

∵ VERSION 1.0 OCTOBER 2019

1. PROPERTY DESCRIPTION

SHEET NUMBER 3\_ OF 42\_

4. FLOOD PLAIN STATUS

HARRIS COUNTY FLOOD CONTROL PROJECT NO. #D100-00-00-Y020

#### HCFCD GENERAL NOTES:

- 1. FENCES AND/OR OTHER ENCROACHMENTS IN THE HCFCD RIGHT-OF-WAY ARE NOT TO BE REMOVED UNLESS OTHERWISE STATED ON THE PLANS. IN CASES WHERE FENCE REMOVAL IS INDICATED ON THE PLANS, THE FENCE SHALL BE REMOVED AND PLACED NEATLY ON THE ADJACENT PROPERTY AT THE START OF CONSTRUCTION. WHERE THERE IS NOT A SEPARATE ITEM LISTED ON THE UNIT PRICE SCHEDULE, THE ENCROACHMENT REMOVAL IS INCIDENTAL TO SITE PREPARATION AND RESTORATION.
- 2. DO NOT ENTER PRIVATE PROPERTY WITHOUT PROPER WRITTEN AUTHORIZATION FROM THE OWNER. PROVIDE COPY OF WRITTEN PERMISSION TO HCFCD.
- 3. STRIP VEGETATION AND TOPSOIL AND STOCKPILE FOR REUSE ONSITE. MATERIAL FOUND UNACCEPTABLE BY THE ENGINEER WILL BE REMOVED AND PAID AS EXCAVATION AND OFFSITE DISPOSAL. NO SEPARATE MEASUREMENT AND PAYMENT WILL BE MADE FOR STRIPPING, STOCKPILING AND PLACING ON-SITE TOPSOIL THE COST FOR THIS WORK WILL BE INCIDENTAL TO RELATED PAY ITEMS UNDER SPECIFICATION SECTION NUMBER 02315 LISTED ON THE UNIT PRICE SCHEDULE.
- 4. RIPRAP AND GRANULAR FILL MATERIAL REMOVED DURING EXCAVATION, MEETING SPECIFICATION SECTION NUMBER 02378, SHALL BE REUSED AS DIRECTED BY THE ENGINEER. REUSED MATERIAL WILL BE MEASURED AND PAID FOR AS EXCAVATION AND ON-SITE FILL UNDER SPECIFICATION NUMBER 02315. NO SEPARATE MEASUREMENT OR PAYMENT WILL BE MADE FOR PROCESSING, HANDLING, STOCKPILING, AND PLACING MATERIAL FOUND TO BE ACCEPTABLE FOR REUSE. UPON APPROVAL OF THE ENGINEER, DISPOSAL OF NONCONFORMING RIPRAP AND GRANULAR FILL MATERIAL WILL BE MEASURED AND PAID FOR AS REMOVE AND DISPOSE OF CONCRETE RUBBLE UNDER SPECIFICATION SECTION NUMBER 02120, MATERIAL DISPOSAL.
- 5. THE LOCATION AND GRADE OF THE BACKSLOPE INTERCEPTOR STRUCTURES AND SWALES MAY BE ADJUSTED IN THE FIELD BY THE ENGINEER AT THE TIME OF CONSTRUCTION. UNLESS OTHERWISE INSTRUCTED BY THE ENGINEER, THE BACKSLOPE INTERCEPTOR STRUCTURE SHALL BE SET AT A MAXIMUM DEPTH OF 2.5 FEET AND THE MINIMUM GRADE FOR BACKSLOPE SWALES SHALL BE 0.2%.
- 6. ADJUST YARD DRAINS AS DIRECTED IN THE FIELD AT THE TIME OF CONSTRUCTION. PAYMENT WILL BE INCIDENTAL TO SITE PREPARATION AND RESTORATION.
- 7. COMPLETED SECTIONS OF THE CHANNEL WILL BE TURNED OVER FOR VEGETATION ESTABLISHMENT IN MAXIMUM 1500 LINEAR FOOT SEGMENTS. CONTRACTOR MAY NOT DISTURB GREATER THAN 1500 LF OF CHANNEL AT A TIME.
- 8. CLEAR AND REMOVE ALL SILT FROM CULVERTS, PIPES AND UNDER BRIDGES TO THE PROPOSED DESIGN GRADES TO PROVIDE POSITIVE FLOW.
- 9. LENGTHS AND DIAMETERS REPRESENTED ON PLANS ARE APPROXIMATE. CONTRACTOR WILL BE RESPONSIBLE FOR FIELD VERIFICATION PRIOR TO ORDERING MATERIALS.
- 10. ACTIVITIES THAT DISTURB BIRD HABITAT, INCLUDING BUT NOT LIMITED TO CLEARING, GRUBBING, AND IMPACTS TO STRUCTURES WHERE MIGRATORY BIRDS AND BALD EAGLES MIGHT NEST, REQUIRE A NEST HABITAT SURVEY. DO NOT PROCEED UNTIL HARRIS COUNTY FLOOD CONTROL DISTRICT HAS CONDUCTED A NEST HABITAT SURVEY TO VERIFY ACTIVE MIGRATORY BIRD NESTS AND BALD EAGLE NESTS ARE NOT PRESENT. THE HARRIS COUNTY FLOOD CONTROL DISTRICT MUST PROVIDE WRITTEN AUTHORIZATION TO PROCEED.
- 11. WHEN BANK EROSION REPAIRS CALL FOR THE PLACEMENT OF 3"x5" GRANULAR FILL IN THE CHANNEL BOTTOM TO ESTABLISH A BASE FOR REBUILDING THE SLOPE. THE 3"x5" GRANULAR FILL SHALL BE LIMITED TO AN ELEVATION 6-INCHES ABOVE THE NORMAL WATER SURFACE ELEVATION LEVEL.
- 12. THE CONTRACT CONTAINS UNIT ITEMS FOR THE ESTABLISHMENT OF BEST MANAGEMENT PRACTICES FOR STORM WATER QUALITY PURPOSES. WHEN NOT CALLED FOR IN THE PROJECT PLANS, COORDINATE THE NEED AND LOCATION OF THESE UNIT ITEMS WITH THE DISTRICT REPRESENTATIVE ON SITE PRIOR TO PLACEMENT. THESE UNIT ITEMS INCLUDE, BUT ARE NOT LIMITED TO, REINFORCED SILT FENCE FOR MATERIAL STOCKPILES, ANCHORED SODDING FOR DISTURBED EARTHEN AREAS OR AROUND CONCRETE AND CONCRETE INTERCEPTOR, AND STABILIZED CONSTRUCTION ACCESS FOR PROJECT SITE INGRESS/EGRESS.
- 13. WHEN INCLUDED IN THE SCOPE OF WORK, THE PURPOSE OF DEEP PLOWING THE SLOPE OR BERM OF A CHANNEL IS TO BREAK UP THE DESICCATED SOILS AND TO ELIMINATE ANY VOIDS, OR RILLING CLOSE TO THE SURFACE OF THE SLOPE OR BERM. THE CONTRACTOR WILL DEEP PLOW THE SLOPE OR BERM TO A MINIMUM DEPTH OF 2 FEET IN AREAS CONTAINING VOIDS AND/OR RILLING. IN AREAS OF VOIDS ONLY, THE SURFACE FROM WHICH THE 2 FEET DEPTH IS MEASURED WILL BE THE LEVEL OF THE SURROUNDING UNDISTURBED SOIL. IN AREAS OF RILLING. THE RILLS WILL FIRST BE KNOCKED DOWN AND LEVELED OFF. THE 2 FEET DEPTH WILL THEN BE MEASURED FROM THIS NEW SURFACE. THE CONTRACTOR WILL DETERMINE THE MEANS AND METHODS FOR DEEP PLOWING.)
- 14. TREES AND PLANTS LOCATED WITHIN A DESIGNATED TREE PROTECTION ZONE (TPZ) SHALL BE PRESERVED. REFER TO SPECIFICATION SECTION 01566 - TREE AND PLANT PROTECTION, FOR DETAILED INFORMATION ON TREE AND PLANT PRESERVATION PRACTICES AND PROCEDURES INCLUDING, BUT NOT LIMITED TO, ROOT PRUNING, VEGETATION TRIMMING, FENCING AND OTHER PRESERVATION OPERATIONS.
- 15. IF APPLICABLE, CONTRACTOR SHALL AVOID ANY WETLAND AREAS BEYOND THE LIMITS OF EXCAVATION AND CLEARING. AS THE FIRST WORK ITEM CONTRACTOR WILL BE RESPONSIBLE FOR INSTALLING FENCING OR OTHER MATERIAL TO IDENTIFY AND PROTECT THE IDENTIFIED WETLAND AREAS, UNLESS WETLANDS HAVE BEEN IDENTIFIED AND FENCED BY HCFCD PRIOR TO CONSTRUCTION AND CONTRACTOR HAS WRITTEN EVIDENCE OF SUCH.

#### UTILITY NOTES

#### CENTERPOINT ENERGY ID: 1406247323 CAUTION: UNDERGROUND GAS FACILITIES

THE CONTRACTOR SHALL CONTACT THE UTILITY COORDINATING COMMITTEE AT 1-800-545-6005 OR 811 A MINIMUM OF 48 HOURS PRIOR TO CONSTRUCTION TO HAVE MAIN AND SERVICE LINES FIELD LOCATED.

- WHEN CENTERPOINT ENERGY PIPE LINE MARKINGS ARE NOT VISIBLE, CALL (713) 207-5463 OR (713-945-8037 (7:00 A.M. TO 4:30 P.M.) FOR STATUS OF LINE LOCATION REQUEST BEFORE EXCAVATION
- WHEN EXCAVATING WITHIN EIGHTEEN INCHES (18") OF THE INDICATED LOCATION OF CENTERPOINT ENERGY FACILITIES, ALL EXCAVATION MUST BE ACCOMPLISHED USING NON-MECHANIZED EXCAVATION
- WHEN CENTERPOINT ENERGY FACILITIES ARE EXPOSED. SUFFICIENT SUPPORT MUST BE PROVIDED TO THE FACILITIES TO PREVENT EXCESSIVE STRESS ON THE PIPING.
- FOR EMERGENCIES REGARDING GAS LINES CALL (713) 659-2111 OR (713) 207-4200.

THE CONTRACTOR IS FULLY RESPONSIBLE FOR ANY DAMAGES CAUSED BY HIS FAILURE TO EXACTLY LOCATE AND PRESERVE THESE UNDERGROUND FACILITIES.

#### CENTERPOINT ENERGY

#### WARNING: OVERHEAD ELECTRICAL FACILITIES

OVERHEAD LINES MAY EXIST ON THE PROPERTY. THE LOCATION OF OVERHEAD LINES HAS NOT BEEN SHOWN ON THESE DRAWINGS AS THE LINES ARE CLEARLY VISIBLE, BUT YOU SHOULD LOCATE THEM PRIOR TO BEGINNING ANY CONSTRUCTION. TEXAS LAW, SECTION 752, HEALTH & SAFETY CODE FORBIDS ACTIVITIES THAT OCCUR IN CLOSE PROXIMITY TO HIGH VOLTAGE LINES, SPECIFICALLY:

■ ANY ACTIVITY WHERE PERSON OR THINGS MAY COME WITHIN SIX(6) FEET OF LIVE OVERHEAD HIGH VOLTAGE LINES; AND OPERATING A CRANE, DERRICK, POWER SHOVEL, DRILLING RIG, PILE DRIVER, HOISTING EQUIPMENT, OR SIMILAR APPARATUS WITHIN 10 FEET OF LIVE OVERHEAD HIGH VOLTAGE LINES.

PARTIES RESPONSIBLE FOR THE WORK, INCLUDING CONTRACTORS ARE LEGALLY RESPONSIBLE FOR THE SAFETY OF CONSTRUCTION WORKERS UNDER THIS LAW. THIS LAW CARRIES BOTH CRIMINAL AND CIVIL LIABILITY. TO ARRANGE FOR LINES TO BE TURNED OFF OR REMOVED CALL CENTERPOINT ENERGY AT (713) 207-2222.

#### ACTIVITIES ON/OR ACROSS CENTERPOINT ENERGY FEE OR EASEMENT PROPERTY

NO APPROVAL TO USE, CROSS OR OCCUPY CENTERPOINT FEE OR EASEMENT PROPERTY IS GIVEN. IF YOU NEED TO USE CENTERPOINT PROPERTY, PLEASE CONTACT OUR SURVEYING & RIGHT OF WAY DIVISION AT (713) 207-6348 OR (713) 207-5769.

WARNING: UNDERGROUND ELECTRICAL UTILITIES

THE CONTRACTOR SHALL CONTACT THE UTILITY COORDINATING COMMITTEE AT 1-800-545-6005 OR 811 A MINIMUM OF 48 HOURS PRIOR TO CONSTRUCTION TO HAVE MAIN AND SERVICE LINES FIELD LOCATED.

- ALL INFORMATION CONCERNING TYPE AND LOCATION OF UNDERGROUND UTILITIES IS NOT GUARANTEED TO BE ACCURATE OR ALL INCLUSIVE. THE CONTRACTORS ARE RESPONSIBLE MAKING THEIR OWN DETERMINATIONS AS TO TYPE AND LOCATION OF UNDERGROUND UTILITIES AS MAY BE NECESSARY TO AVOID DAMAGE THERETO. THE CONTRACTOR SHALL VERIFY LOCATION OF UNDERGROUND PIPELINES, CONDUITS, AND STRUCTURES BY CONTACTING OWNERS OF UNDERGROUND UTILITIES OR BY EXCAVATING IN ADVANCE OF CONSTRUCTION.
- THE CONTRACTOR IS RESPONSIBLE FOR DETERMINING THE EXACT LOCATION OF ALL UTILITIES WHEN AND WHERE THEY FALL IN THE PATH OF CONSTRUCTION.
- THE CONTRACTOR IS ALSO RESPONSIBLE FOR CONTACTING THE UTILITY COORDINATING COMMITTEE AT (713) 223-4567 AND TEXAS ONE CALL AT 1-800-245-4545, FORTY-EIGHT (48) HOURS PRIOR TO ANY
- THE LOCATION OF ANY CENTERPOINT ENERGY UTILITIES ARE SHOWN IN APPROXIMATE WAY ONLY. THE CONTRACTOR SHALL DETERMINE THE EXACT LOCATION BEFORE COMMENCING WORK. THEY AGREE TO BE FULLY RESPONSIBLE FOR ANY AND ALL DAMAGES WHICH MIGHT BE OCCASIONED BY THIS FAILURE TO
- EXACTLY LOCATE AND PRESERVE THESE UNDERGROUND UTILITIES. ALL PROPOSED FACILITIES SHALL MAINTAIN 12"CLEAR FROM ALL EXISTING UTILITIES.

#### AT&T TEXAS/SWBT FACILITIES LOG NO: 010824KTCF02

- 1. THE LOCATIONS OF AT&T TEXAS/SWBT FACILITIES ARE SHOWN IN AN APPROXIMATE WAY ONLY. THE CONTRACTOR SHALL DETERMINE THE EXACT LOCATION BEFORE COMMENCING WORK. HE AGREES TO BE FULLY RESPONSIBLE FOR ANY AND ALL DAMAGES WHICH MIGHT BE OCCASIONED BY THIS FAILURE TO EXACTLY LOCATE AND PRESERVE THESE UNDERGROUND UTILITIES.
- 2. THE CONTRACTOR SHALL CALL 1-800-344-8377 (TEXAS 811) A MINIMUM OF 48 HOURS PRIOR TO CONSTRUCTION TO HAVE UNDERGROUND LINES FIELD LOCATED.
- 3. WHEN EXCAVATING WITHIN EIGHTEEN INCHES (18") OF THE INDICATED LOCATION OF AT&T TEXAS/SWBT FACILITIES, ALL EXCAVATIONS MUST BE ACCOMPLISHED USING NON-MECHANIZED EXCAVATION PROCEDURES. WHEN BORING, THE CONTRACTOR SHALL EXPOSE THE AT&T TEXAS/SWBT FACILITIES.
- 4. WHEN AT&T TEXAS/SWBT FACILITIES ARE EXPOSED, THE CONTRACTOR WILL PROVIDE SUPPORT TO PREVENT DAMAGE TO THE CONDUIT DUCTS OR CABLES. WHEN EXCAVATING NEAR TELEPHONE POLES THE CONTRACTOR SHALL BRACE THE POLE FOR SUPPORT.
- 5. THE PRESENCE OR ABSENCE OF AT&T TEXAS/SWBT UNDERGROUND CONDUIT FACILITIES OR BURIED CABLE FACILITIES SHOWN ON THESE PLANS DOES NOT MEAN THAT THERE ARE NO DIRECT BURIED CABLES OR OTHER CABLES IN CONDUIT IN THE AREA.
- 6. PLEASE CONTACT THE AT&T TEXAS DAMAGE PREVENTION MANAGER ROOSEVELT LEE JR. AT (713)614-1983 OR E-MAIL HIM AT KR7896@ATT.COM, IF CABLE LOCATE REQUEST(S) ARE NOT COMPLETED FOR OUR AT&T TEXAS/SWBT FACILITIES.

15021 KATY FREEWAY, STE. 500 HOUSTON, TX. 77094 281-945-0069 TX FIRM NUMBER: F-6932

FB NO. P-6331

THIS DOCUMENT IS RELEASED FOR PURPOSE OF INTERIM REVIEW UNDER THE AUTHORITY OF RODRIGO GUADARRAMA TEXAS REG. NO. 111437 OCTOBER 15, 2025

IT IS NOT TO BE USED SURVEYED BY: LANDTECH, INC. FOR CONSTRUCTION PURPOSES

#### OF HOUSTON HOUSTON PUBLIC WORKS

SHARPSTOWN AREA DETENTION POND A

GENERAL NOTES (1 OF 2)

|   | WBS NUMBER                | FOR CITY OF | HOUSTON | USE | ON |
|---|---------------------------|-------------|---------|-----|----|
|   | M-410040-001A-4           |             |         |     |    |
|   | DRAWING SCALE             |             |         |     |    |
|   | AS NOTED                  |             |         |     |    |
|   | CITY OF HOUSTON PM        |             |         |     |    |
|   | SUPUN ILANGAMUDALIGE P.E. |             |         |     |    |
| 0 | SHEET NO. 4 OF 42         |             |         |     |    |

## MAINTENANCE ENGINEERING CONSTRUCTION NOTES: (USE IF APPLICABLE)

- 1. THE PROJECT PLANS ARE INTENDED AS A GUIDE. THE REPAIR AREA LIMITS WILL BE DETERMINED IN THE FIELD BY THE HCFCD REPRESENTATIVE. DUE TO THE DYNAMIC CONDITIONS IN THE FIELD, PROJECT SCOPE AND QUANTITIES MAY VARY FROM THE PLANS AND/OR CROSS SECTIONS. HCFCD RESERVES THE RIGHT TO ADJUST PLANS AND QUANTITIES AS NECESSARY. PROJECT SCOPE MAY BE ADJUSTED AS PRIORITIES CHANGE.
- 2. THE PURPOSE OF THE CHANNEL DESILT IS TO RESTORE POSITIVE DRAINAGE DURING LOW FLOW CONDITIONS. UNLESS SPECIFICALLY STATED OTHERWISE, IT IS NOT THE INTENT OF THE PROJECT TO DEEPEN THE CHANNEL BEYOND ITS ORIGINAL DESIGN CONFIGURATION. EXCAVATION OF SILT SHOULD NOT UNDERMINE THE TOE OF THE SLOPE.

#### MAINTENANCE ENGINEERING ON-CALL CONSTRUCTION CONTRACT NOTES: (USE IF APPLICABLE)

- 1. THE INITIAL ISSUED FOR CONSTRUCTION PROJECT PLAN DETAILS AND SUBSEQUENT PROJECT PLANS ISSUED TO THE CONTRACT ARE INTENDED AS A GUIDE. THE EXACT PROJECT LIMITS WILL BE DETERMINED IN THE FIELD BY THE ENGINEER PRIOR TO AND/OR AFTER THE START OF CONSTRUCTION ACTIVITIES. DUE TO THE DYNAMIC CONDITIONS ON SITE, PROJECT SCOPE AND QUANTITIES MAY VARY FROM THE PROJECT PLANS AND/OR CROSS SECTIONS. HCFCD RESERVES THE RIGHT TO ADJUST PROJECT PLANS AND CONTRACT QUANTITIES AS NECESSARY IN ACCORDANCE WITH THE CONTRACT. PROJECT PLANS MAY BE ADDED OR DELETED FROM THE CONTRACT AS PRIORITIES CHANGE. PROJECT ASSIGNMENTS TO CONSTRUCTION WILL BE PRIORITIZED/DETERMINED BY THE ENGINEER.
- 2. ALL RIPRAP CALLED FOR ON THE PROJECT PLANS SHALL BE PAID FOR UNDER THE APPROPRIATE CORRESPONDING UNIT ITEM BASED ON THE SPECIFIED GRADATION AND SHALL BE PAID FOR BY THE TON. WHERE THE PROJECT PLANS CALL FOR THE USE OF A WELL GRADED MIXTURE OF GRANULAR FILL, PAYMENT WILL BE MADE UNDER UNIT ITEM 2378-05, GRANULAR FILL, GRAVEL TO RIPRAP GRADATION NO. 2, AS DIRECTED BY THE ENGINEER.
- 3. THE UNIT ITEM ASSOCIATED WITH SPECIFICATION SECTION 02200, SITE PREPARATION AND RESTORATION WILL BE UTILIZED ON ALL PROJECTS ISSUED TO THE CONTRACT. THE SITE PREPARATION AND RESTORATION UNIT ITEM WILL BE PAID OUT THROUGH THE LIFE OF THE CONTRACT IN INCREMENTS BASED ON 5 PERCENT OF THE ENGINEERS ESTIMATE OF EACH PROJECT SITE ISSUED TO THE CONTRACT. PROJECTS ISSUED TO THE CONTRACT WHICH HAVE AN ENGINEER'S ESTIMATE OF LESS THAN \$100,000.00 WILL BE PAID A FLAT FEE OF \$5,000.00 FOR THE COST ASSOCIATED WITH UNIT ITEM 02200, SITE PREPARATION AND RESTORATION. FINAL PAYMENT WILL BE BASED ON ALL ACTUAL WORK INSTALLED. FOR ADDITIONAL INFORMATION SEE THE SPECIAL PROVISION TO SPECIFICATION 02200, SITE PREP AND RESTORATION.
- 4. THE TERM "LANDFILL" AS INCLUDED IN THE CONTRACT DOCUMENTS REFERS TO A DISPOSAL FACILITY THAT IS LICENSED/PERMITTED BY THE TEXAS COMMISSION ON ENVIRONMENTAL QUALITY (TCEQ).
- 5. IN AREAS WHERE THE PROJECT PLANS CALL FOR THE PLACEMENT OF CONCRETE TO TRANSITION FROM ONE CALLED THICKNESS TO ANOTHER CALLED THICKNESS, PAYMENT FOR THE CONCRETE SHALL BE EVENLY SPLIT BETWEEN THE APPROPRIATELY ASSOCIATED TWO UNIT ITEMS.
- 6. ALL SPECIFICATION SECTION NUMBER 02462, STEEL SHEET PILING UNIT ITEMS SHALL BE BASED ON PZ 27 STEEL SHEET PILING.



FB NO. P-6331

TX FIRM NUMBER: F-6932 SURVEYED BY: LANDTECH, INC.

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IT IS NOT TO BE USED FOR CONSTRUCTION PURPOSES

## CITY OF HOUSTON HOUSTON PUBLIC WORKS

SHARPSTOWN AREA DETENTION POND A

GENERAL NOTES (2 OF 2)

|    | WBS NUMBER                | FOR | CITY | OF | HOUSTON | USE | ONLY |
|----|---------------------------|-----|------|----|---------|-----|------|
|    | M-410040-001A-4           |     |      |    |         |     |      |
|    | DRAWING SCALE             |     |      |    |         |     |      |
|    | AS NOTED                  |     |      |    |         |     |      |
|    | CITY OF HOUSTON PM        |     |      |    |         |     |      |
|    | SUPUN ILANGAMUDALIGE P.E. |     |      |    |         |     |      |
| 20 | SHEET NO. 5 OF 42         |     |      |    |         |     |      |

#### SANITARY SEWERS CONSTRUCTION NOTES

- 1. ALL SEWERS SHALL BE SUBJECT TO A STANDARD EXFILTRATION TEST. TESTS ARE TO BE PERFORMED ON THE TOTAL FOOTAGE OF SEWER LINE INCLUDED IN THE PROJECT. REQUIREMENTS OF TEXAS ADMINISTRATIVE CODE, TITLE 30 CHAPTER 217, "DESIGN CRITERIA FOR DOMESTIC WASTEWATER SYSTEMS" SHALL GOVERN WHERE CONFLICTS EXIST EXCEPT WHERE CITY REQUIREMENTS ARE MORE STRINGENT.
- 2. ALL MANHOLES ARE TO BE PER CITY OF HOUSTON STANDARD DETAILS DRAWING NUMBERS 02082-01, 02082-02, 02082N-02, 02082-03, AND 02082N-03 UNLESS OTHERWISE NOTED. USE THE LATEST VERSION AS APPLICABLE.
- 3. SANITARY SEWER MANHOLES WILL HAVE BEDDING AND BACKFILL PER CITY OF HOUSTON STANDARD DETAILS DRAWING NO. 02317-08 UNLESS OTHERWISE NOTED.
- 4. THE SANITARY SEWER PVC PIPE SHALL BE ASTM D 3034 TYPE PSM SDR 26 GRAVITY SEWER PIPE, ASTM D2241 SDR 26 PRESSURE RATED SEWER PIPE OR AWWA C-900 DR-18 GREEN PVC PRESSURE RATED SEWER PIPE BASED ON CONSTRUCTION CONDITION REQUIREMENT AND CONFORMING TO ASTM D1784 AND CITY OF HOUSTON STANDARD SPECIFICATION SECTION 02506 POLYVINYL CHLORIDE PIPE.
- 5. WHEN SS PRESSURE RATED PVC PIPE IS USED ON WATERLINE (WL) CROSSING UNDER CONDITION 1 OF COH IDM TABLE 7.3, THE SAME TYPE OF D2241 SDR 26 PVC PIPE OR C-900 GREEN DR-18 PVC GREEN PRESSURED TO BE UTILIZING IN-BETWEEN TWO SS MH'S. OR TO UTILIZE A DI TRANSITION ADAPTER FOR THE CONNECTING OF ASTM D-3034 PVC GRAVITY PIPE TO DI-OD AWWA C-900 PVC PIPE CENTERED AT WL WHEN CONNECTING TWO DIFFERENT TYPES OF PVC PIPES FOR SEWER CONSTRUCTION.
- 6. AWWA C-900 DR-18 PVC PIPE USES EITHER AWWA C900 DR-18 PVC FITTINGS OR DIP FITTINGS.
- 7. ALL SANITARY SEWER LINES UNDER PROPOSED OR FUTURE PAVEMENT AND TO A POINT ONE (1) FOOT BACK OF ALL PROPOSED OR FUTURE CURBS SHALL HAVE BEDDING PER CITY OF HOUSTON STANDARD DETAILS DRAWING NUMBERS 02317-01, 02317-02, OR 02317-03 AS APPLICABLE, WITH 1 ½ SACK CEMENT/CY STABILIZED SAND BACKFILL UP TO THE BOTTOM OF THE PAVEMENT SUBGRADE. 100 PSI PERFORMANCE RESULTS ARE STILL REQUIRED.
- 8. ALL NEW SANITARY SEWERS CROSSING WATER LINES WITH A CLEARANCE BETWEEN 12 INCHES AND 9 FEET SHALL HAVE A MINIMUM OF ONE 18' JOINT OF DUCTILE IRON OR (GREEN) C900 PVC PIPE MEETING ASTM SPECIFICATION D2241 CENTERED ON WATER LINE. WHEN WATER LINE IS BELOW SANITARY SEWER, PROVIDE MINIMUM 2 FOOT SEPARATION.
- 9. CONTRACTOR SHALL PROVIDE A MINIMUM HORIZONTAL CLEARANCE OF 9' FEET BETWEEN WATER LINES AND SANITARY SEWER MANHOLES AND LINES.
- 10. SANITARY SEWER MANHOLE RIMS OUTSIDE OF PROPOSED PAVING WILL BE SET 3" 6" ABOVE THE SURROUNDING LEVEL FINISHED GRADE AFTER PAVING WITH SLOPED BACKFILL ADDED FOR STORM WATER TO DRAIN AWAY FROM MANHOLE RIM.
- 11. IN WET STABLE TRENCH AREAS USE BEDDING PER CITY OF HOUSTON STANDARD DETAILS DRAWING NUMBER 02317-02.
- 12. DEFLECTION TEST: DEFLECTION TESTS SHALL BE PERFORMED ON ALL FLEXIBLE AND SEMI-RIGID SEWER PIPE. THE TEST SHALL BE CONDUCTED AFTER THE FINAL BACKFILL HAS BEEN IN PLACE AT LEAST 30 DAYS. NO PIPE SHALL EXCEED A DEFLECTION OF 5% IF THE DEFLECTION TEST IS TO BE RUN USING A RIGID MANDREL, IT SHALL HAVE A DIAMETER EQUAL TO 95% OF THE INSIDE DIAMETER OF THE PIPE. THE TEST SHALL BE PERFORMED AS PER 30 TAC 217.57 LATEST AMENDMENT AND WITHOUT MECHANICAL PULLING DEVICES. NO BALL-TYPE MANDREL IS ALLOWED.
- 13. INFILTRATION, EXFILTRATION OR LOW-PRESSURE AIR TEST: EITHER OF THE FOLLOWING TESTS SHALL BE PERFORMED AS PER TAC, TITLE 30 217.57 WITHIN THE SPECIFIED TOLERANCES ON ALL GRAVITY SEWERS.
- A. INFILTRATION OR EXFILTRATION TEST: TOTAL LEAKAGE AS DETERMINED BY A HYDROSTATIC HEAD TEST SHALL NOT EXCEED 50 GALLONS PER INCH DIAMETER PER MILE OF PIPE PER 24 HOURS AT A MINIMUM TEST HEAD OF TWO (2) FEET.
- B. LOW-PRESSURE AIR TEST: PERFORM TEST ACCORDING TO UNI-B-6-90 OR OTHER APPROPRIATE PROCEDURES. FOR SECTIONS OF PIPE LESS THAN 36" (INCH) AVERAGE INSIDE DIAMETER, THE MINIMUM ALLOWABLE TIME FOR PRESSURE DROP FROM 3.5 P.S.I.G. TO 2.5 P.S.I.G. SHALL BE AS FOLLOWS:
  - 6" 340 SECONDS OR 0.855(L) FOR TEST LENGTHS GREATER THAN 398'
  - 8" 454 SECONDS OR 1.520(L) FOR TEST LENGTHS GREATER THAN 298'
  - 10" 567 SECONDS OR 2.374(L) FOR TEST LENGTHS GREATER THAN 239'
  - 12" 680 SECONDS OR 3.419(L) FOR TEST LENGTHS GREATER THAN 199'
  - 15" 850 SECONDS OR 5.342(L) FOR TEST LENGTHS GREATER THAN 159'
  - 18" 1020 SECONDS OR 7.693(L) FOR TEST LENGTHS GREATER THAN 133'

WHERE L = LENGTH OF LINE OF SAME PIPE SIZE IN FEET.

14. "SAN. S. E." INDICATES "SANITARY SEWER EASEMENT"

15. FOR SANITARY MANHOLE (MH) RIMS SET INSIDE OF OR @ CURB & GUTTER PAVEMENT AND/OR BELOW T.C., MH RIMS WILL BE SET FLUSHED WITH AN ABUTTING PAVED SURFACE. THE (VALCUN, NEENAH OR EQUAL) HEAVY DUTY BOLTED SOLID MH COVER SHALL BE PROPERLY (AND SECURELY) ATTACHED AND SEALED TO ITS COMPATIBLE GASKETED FRAME BY USING BOTH A NEOPRENE GASKET AND (AT LEAST) 4 COUNTER-SUNK HEX-HEAD COARSE THREADED 1/2"-13 UNC STAINLESS STEEL BOLTS. THE HEAVY DUTY FRAME MH COVER SHALL BE SOLID (NO AIR HOLES). SAID FRAME SHALL BE BOTH EMBEDDED INTO THE MH'S TOP ALSO SECURELY ANCHORED TO THE UNDERLYING MH STRUCTURE WITH EITHER SECURELY ATTACHED EMBEDDED ANCHOR BOLTS OR THE CONCRETE MH'S EXPOSED REBARS WELDED TO THE FRAME OR OTHER EQUALLY SECURED METHODS TO PREVENT MH COVER/FRAME BLOW-OFFS/EJECTIONS.

> 15021 KATY FREEWAY, STE. 500 HOUSTON, TX. 77094 281-945-0069 TX FIRM NUMBER: F-6932

RODRIGO GUADARRAMA TEXAS REG. NO. 111437 OCTOBER 15, 2025 IT IS NOT TO BE USED SURVEYED BY: LANDTECH, INC. FB NO. P-6331

FOR CONSTRUCTION PURPOSES

THIS DOCUMENT IS RELEASED FOR PURPOSE OF INTERIM REVIEW UNDER

THE AUTHORITY OF

CITY OF HOUSTON HOUSTON PUBLIC WORKS

SHARPSTOWN AREA DETENTION POND A

> SANITARY SEWER CONSTRUCTION NOTES

FOR CITY OF HOUSTON USE ONLY WBS NUMBER M-410040-001A-4 DRAWING SCALE AS NOTED CITY OF HOUSTON PM SUPUN ILANGAMUDALIGE P.E.

HCFCD PROJECT ID #D100-00-00-Y020

SHEET NO. 6 OF 42

#### WATER CONSTRUCTION NOTES

- 1. ALL 4" THROUGH 12" WATER LINE TO BE AWWA C-900 PVC DR-18 BLUE PRESSURE RATED WATER MAIN WITH 2" AND SMALLER WATER SERVICE LINE TO BE CONTINUOUS TYPE K COPPER TUBING PER COH STANDARD SPECIFICATION SECTION 02503. ALL 4" THRU 54" DI PIPE WATER LINES SHALL BE AWWA C151 WITH INSIDE LINING WITH AWWA C104 AND DOUBLE WRAPPED WITH 8-MIL POLYETHYLENE SHEETS.
- 2. CONCRETE THRUST BLOCKS SHALL BE PROVIDED AS NECESSARY TO PREVENT PIPE MOVEMENT. USE RESTRAINED JOINTS WHERE PREVENTING PIPE MOVEMENT IS NECESSARY DUE TO THRUST.
- 3. ALL WATER LINES UNDER PROPOSED OR FUTURE PAVING AND TO A POINT OF ONE (1) FOOT BACK OF ALL PROPOSED OR FUTURE CURBS SHALL BE ENCASED IN BANK SAND TO 12" OVER PIPE AND BACKFILLED WITH CEMENT STABILIZED SAND TO WITHIN ONE (1) FOOT OF SUBGRADE.
- 4. ALL WATER LINE AND SEWER LINE CROSSINGS SHALL BE CONSTRUCTED PER CITY OF HOUSTON AND TCEQ REGULATIONS.
- 5. ALL WATER VALVES SHALL BE SUPPLIED AND INS TALLED IN ACCORDANCE WITH THE LATEST EDITION OF AWWA C-500 AND SHALL BE OF THE RESILIENT SEAT TYPE.
- 6. ALL WATER LINES TO BE DISINFECTED IN CONFORMANCE WITH AWWA C-651 AND THE TEXAS STATE DEPARTMENT OF HEALTH. AT LEAST ONE BACTERIOLOGICAL SAMPLE SHALL BE COLLECTED FOR EVERY 1,000 LINEAR FEET OF WATER LINE AND SHALL BE REPEATED IF CONTMINATION PERSISTS.
- 7. ALL BELOW GRADE VALVES SHALL BE GASKETED, HUB-END GATE VALVES WITH A CAST IRON BOX, EXCEPT WHERE FLANGES ARE CALLED OUT ON THE PLANS.
- 8. 4" THRU 12" FITTINGS SHALL BE CEMENT MORTAR LINED COMPACT DUCTILE IRON PRESSURE FITTINGS PER ANSI A21.53, OR PUSH ON FITTINGS PER ANSI A21.10 PRESSURE RATED AT 250 PSIG.
- 9. HYDROSTATIC TESTING: ALL WATER PIPE SHALL BE TESTED FOR LEAKAGE IN ACCORDANCE WITH THE LATEST CITY OF HOUSTON STANDARD CONSTRUCTION SPECIFICATIONS. TESTS ARE TO BE PERFORMED ON THE ENTIRE FOOTAGE OF WATER PIPE INCLUDED IN THE PROJECT.
- 10. ALL WATER LINES TO HAVE 4' MINIMUM COVER TO FINISHED GRADE AND MINIMUM 12" CLEARANCE TO OTHER UTILITIES AT CROSSING UNLESS OTHERWISE NOTED ON PLANS. ALL WATER LINE INSTALLED OVER 8' DEEP SHALL UTILIZE RESTRAINED JOINT FITTINGS.
- 11. CONTRACTOR SHALL KEEP WATER PIPE CLEAN AND CAPPED (OR OTHERWISE EFFECTIVELY COVERED) OPEN PIPE ENDS TO EXCLUDE INSECTS, ANIMALS OR OTHER SOURCES OF CONTAMINATION FROM UNFINISHED LINES AT TIMES WHEN CONSTRUCTION IS NOT IN PROGRESS.

#### GRADING NOTES

- 1. GENERAL CONTRACTOR AND ALL SUBCONTRACTORS SHALL VERIFY THE SUITABILITY OF ALL EXISTING AND PROPOSED SITE CONDITIONS INCLUDING GRADES AND DIMENSIONS BEFORE STARTING CONSTRUCTION. THE ENGINEER SHALL BE NOTIFIED IMMEDIATELY OF ANY DISCREPANCIES.
- 2. BEFORE STARTING CONSTRUCTION, CONTRACTOR SHALL VERIFY BENCHMARK ELEVATION AND NOTIFY ENGINEER IF ANY DISCREPANCY AND OR CONFLICT IS FOUND.
- 3. CONTRACTOR SHALL ENSURE THERE IS POSITIVE DRAINAGE FROM THE PROPOSED BUILDINGS AND NO PONDING IN PAVED AREAS, AND SHALL NOTIFY ENGINEER IF ANY GRADING DISCREPANCIES ARE FOUND IN THE EXISTING AND PROPOSED GRADES PRIOR TO PLACEMENT OF PAVEMENT OR UTILITIES.
- 4. CONTRACTOR SHALL PROTECT ALL MANHOLE COVERS, VALVE COVERS, VAULT LIDS, FIRE HYDRANTS, POWER POLES, GUY WIRES, AND TELEPHONE BOXES THAT ARE TO REMAIN IN PLACE AND UNDISTURBED DURING CONSTRUCTION.
- 5. ALL EXISTING CONCRETE PAVING, SIDEWALK, AND CURB DEMOLITION SHALL BE REMOVED AND DISPOSED OF BY CONTRACTOR. DISPOSAL SHALL BE AT AN APPROVED OFF-SITE, LAWFUL LOCATION, UNLESS DIRECTED OTHERWISE BY THE OWNER.

#### STORM CONSTRUCTION NOTES

- 1. STORM SEWER SHALL BE REINFORCED CONCRETE PIPE (C-76, CLASS III), AND SHALL BE INSTALLED, BEDDED, AND BACK FILLED IN ACCORDANCE WITH THE CITY OF HOUSTON DRAWING NOS. 2317-02, 02317-3, 02317-05, 02317-06, AND 02317-07 (JULY 2019) AS APPLICABLE UNLESS OTHERWISW SHOWN ON THE DRAWINGS.
- 2. ALL STORM SEWER CONSTRUCTED IN SIDELOT EASMENT SHALL BE R.C.P (C-76, CLASSIII) AND SHALL BE EMBEDDED IN ACCORDANCE WITH THE CITY OF HOUSTON DRAWING NOS. 02317-02, 02317-03, 02317-05, 02317-06, AND 02317-07 AS APPLICABLE.
- 3. ALL SEWER UNDER PROPOSED OR FUTURE PAVEMENT AND TO A POINT ONE (1) FOOT BACK OF ALL PROPOSED OR FUTURE CURBS SHALL BE BACKFILLED WITH 1-1/2 SACK CEMENT/C.Y. STABLIZED SAND TO WITHIN ONE (1) FOOT OF SUBGRADE. THE REMAINING DEPTH OF TRENCH SHALL BE BACKFILLED WITH SUITABLE EARTH MATERIAL.
- 4. ALL TRENCH BACKFILL SHALL BE IN 8" LIFTS, WITH TESTS TAKEN AT 100 FOOT INTERVALS IN EACH LIFT, AND MECHNICALLY COMPACTED TO A DENSITY OF NOT LESS THAN 95% OF THE MAXIMUM DRY DENSITY AS DETERMINED BY THE STANDARD PROCTOR COMACTION TEST (ASTM D-698/AASHTO T99).
- 5. CIRCULAR AND ELLIPTICAL REINFORCED CONCRETE PIPE SHALL BE INSTALLED USING RUBBER GASKET JOINT CONFORMING TO ASTM C443 AND ASTM C877 RESPECTIVELY.
- 6. ALL STORM SEWER PIPES AND INLET LEADS SHALL BE 24" AND LARGER R.C.P. (C-76, CLASSIII).
- 7. ALL PROPOSED PIPE STUB-OUTS FROM MANHOLES AND INLET LEADS ARE TO BE PLUGGED WITH 8" BRICK WALLS UNLESS OTHERWISE NOTED.
- 8. MINIMUM HORIZONTAL CLEARANCE BETWEEN ANY STORM PIPE AND BOX SHALL BE AT LEAST 48-INCHES FROM EXTERIOR OF THE STORM PIPE OR BOX TO THE EXTERIOR OF THE EXISTING OR PROPOSED PUBLIC OR PRIVATE UTILITY AND OTHER APPURTENANCES. MINIMUM VERTICAL CLEARANCE BETWEEN ANY STORM PIPE AND BOX SHALL BE AT LEAST 24-INCHES FROM EXTERIOR OF THE STORM PIPE OR BOX TO THE EXTERIOR OF THE EXISTING OR PROPOSED PUBLIC OR PRIVATE UTILITY AND OTHER APPURTENANCES.
- 9. ADJUST MANHOLE COVERS TO GRADE CONFORMING TO REQUIREMENTS OF SECTION 02086-ADJUSTING MANHOLES, INLETS, AND VALAVE BOXES TO GRADE.
- 10. THE CONTRACTOR SHALL BE RESPONSIBLE FOR PROTECTING, MAINTAINING, AND RESTORING ANY BACK SLOPE DRAINAGE SYSTEM DISTURBED AS A RESULT OF THIS WORK.
- 11. ALL DITCHES SHALL BE GRADED TO PROPOSED ELEVATIONS TO INSURE PROPER DRAINAGE. ALL OUTFALLS SHALL BE PROPERLY BACKFILLED AND COMPACTED. ALL DISTURBED AREA SHALL BE REGRADED, SEEDED, AND FERTILIZED.
- 12. ALL DRIVEWAYS WILL BE LOCATED TO AVOID EXISTING CURB INLET STRUCTURES.

15021 KATY FREEWAY, STE. 500 HOUSTON, TX. 77094 281-945-0069 TX FIRM NUMBER: F-6932

FB NO. P-6331

THIS DOCUMENT IS RELEASED FOR PURPOSE OF INTERIM REVIEW UNDER THE AUTHORITY OF RODRIGO GUADARRAMA TEXAS REG. NO. 111437 OCTOBER 15, 2025

IT IS NOT TO BE USED SURVEYED BY: LANDTECH, INC. FOR CONSTRUCTION PURPOSES

CITY OF HOUSTON

HOUSTON PUBLIC WORKS

SHARPSTOWN AREA DETENTION

WATER AND STORM GENERAL NOTES


POND A


FOR CITY OF HOUSTON USE ONLY WBS NUMBER M-410040-001A-4 DRAWING SCALE AS NOTED CITY OF HOUSTON PM SUPUN ILANGAMUDALIGE P.E.

HCFCD PROJECT ID #D100-00-00-Y020


SHEET NO. 7 OF 42

| Curve | Radius  | Length  | Delta     | Chord Bear.   | Chord   |
|-------|---------|---------|-----------|---------------|---------|
| C1    | 500.00' | 222.05  | 25°26′41″ | N 74°27'47" E | 220.23' |
| C2    | 500.00  | 222 05' | 25*26'41" | N 74°27'46" F | 220 23' |

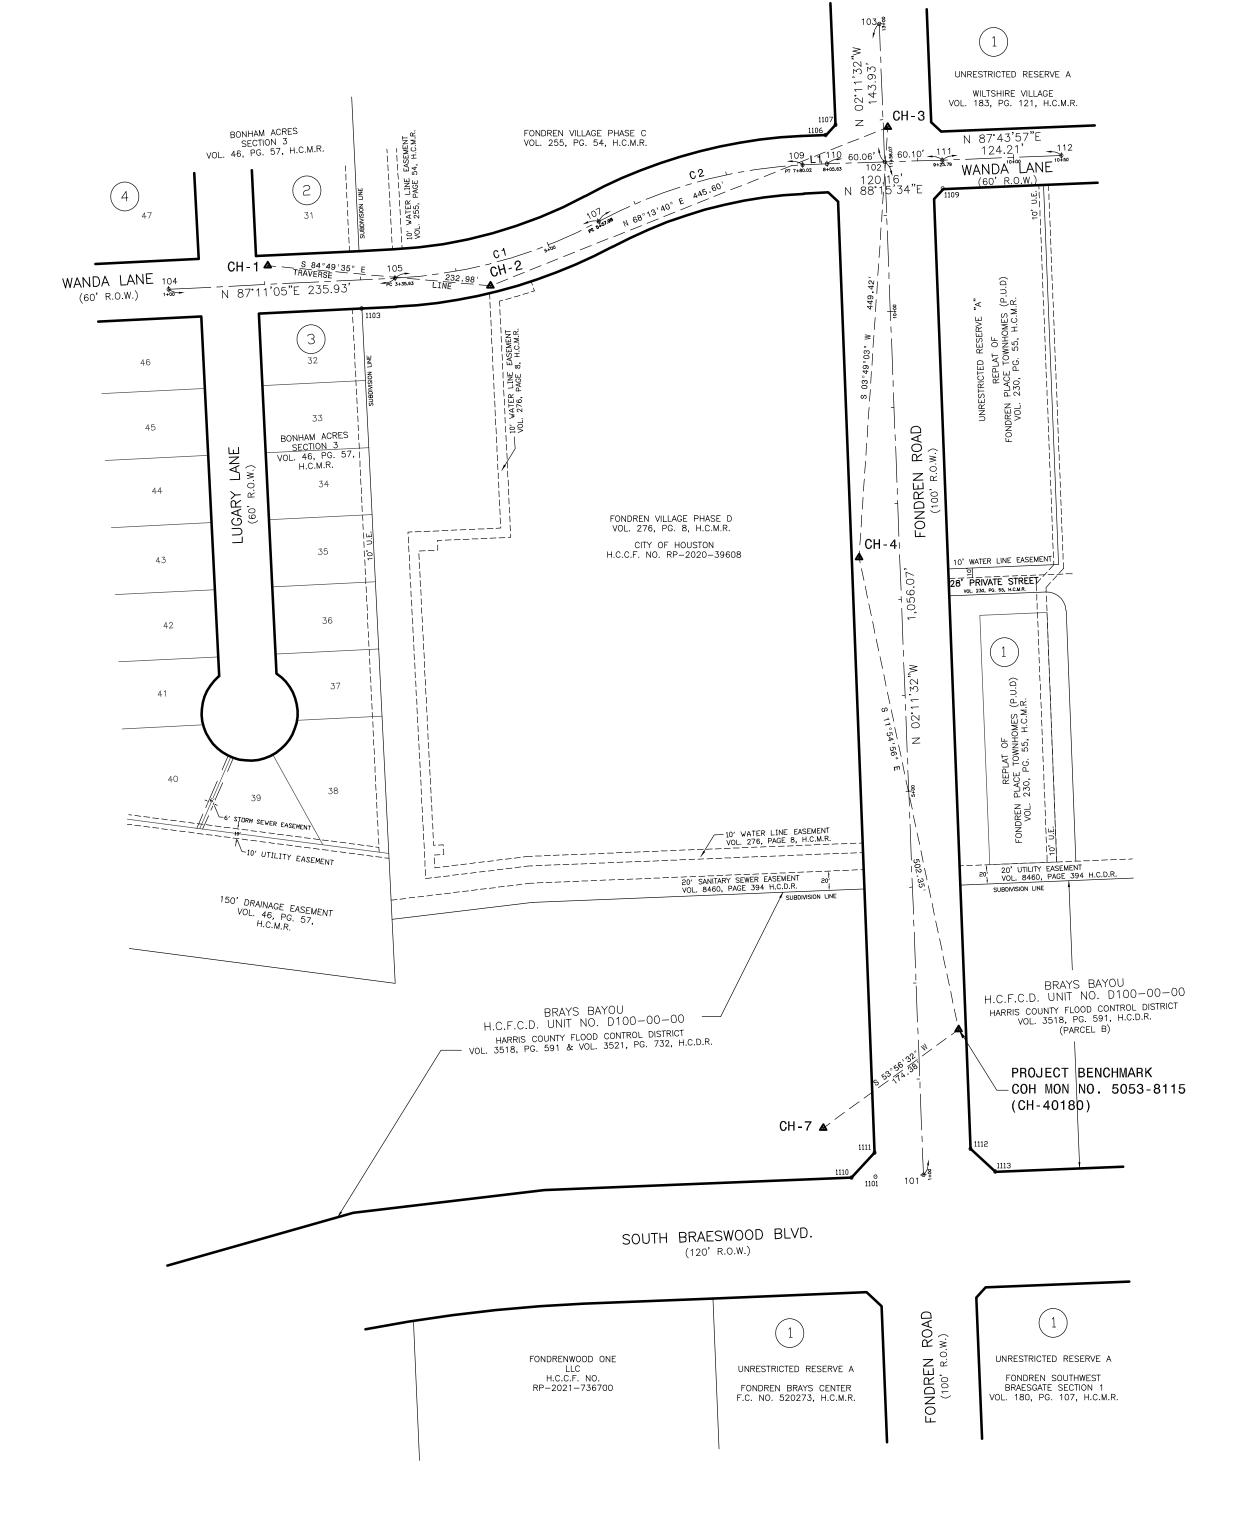

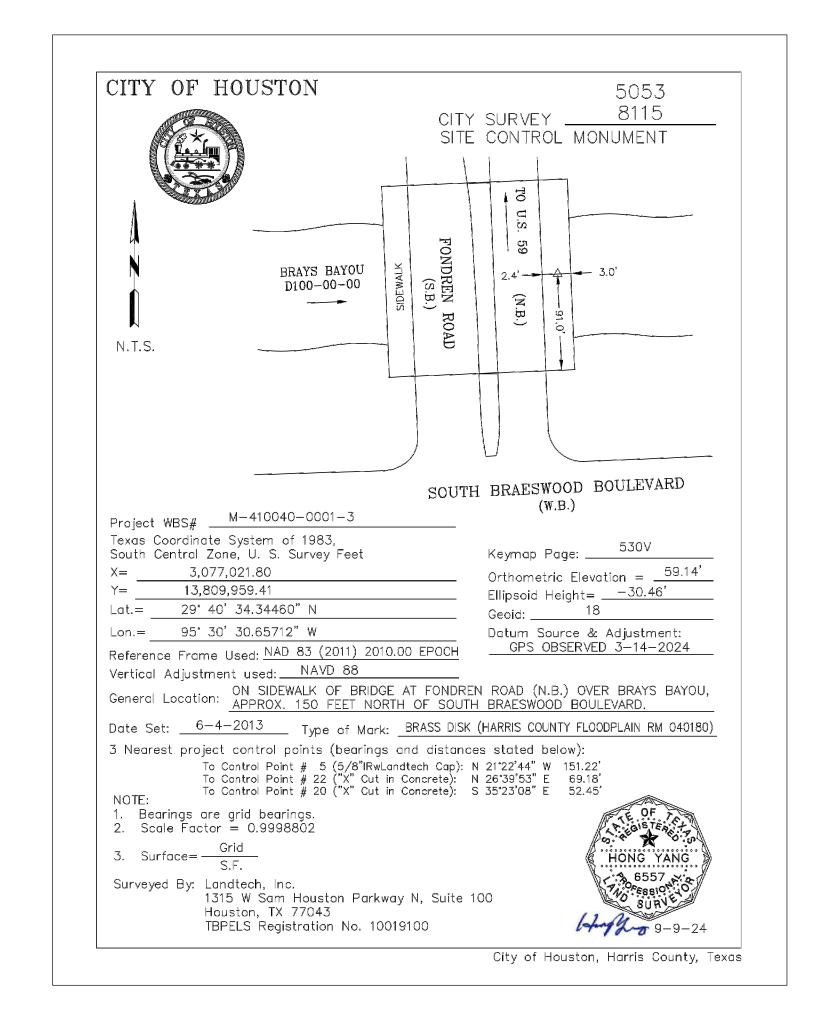

| Point ID | Station  | Offset  | Grid Northing | <b>Grid Easting</b> | Elevation | Description                        |
|----------|----------|---------|---------------|---------------------|-----------|------------------------------------|
|          |          |         |               | FONDREN ROAD        | )         |                                    |
| 101      | 1+00.00  | 0.00    | 13,809,807.87 | 3,076,985.13        |           | SET X IN CONC.                     |
| 1110     | 1+00.08  | -74.93  | 13,809,805.08 | 3,076,910.27        | ,         | FND. 1/2"I.R.                      |
| 1113     | 1+00.49  | 74.99   | 13,809,811.23 | 3,077,060.04        |           | FND. 1/2"I.R.                      |
| 1111     | 1+25.11  | -49.95  | 13,809,831.04 | 3,076,934.27        | ,         | FND. 1/2"I.R.                      |
| 1112     | 1+25.43  | 49.98   | 13,809,835.18 | 3,077,034.11        |           | FND. 1/2"I.R.                      |
| 7        | 1+52.87  | -102.36 | 13,809,856.78 | 3,076,880.85        | 58.39     | CH-7 SET 5/8"I.R.wLANDTECH CAP     |
| 40180    | 2+50.05  | 42.44   | 13,809,959.41 | 3,077,021.80        | 59.14     | COH MON NO. 5053-8115              |
| 4        | 7+45.18  | -42.40  | 13,810,450.87 | 3,076,918.09        | 56.00     | CH-4 SET 5/8"I.R.wLANDTECH CAP     |
| 1109     | 11+26.17 | 59.32   | 13,810,835.42 | 3,077,005.15        |           | FND. 5/8"I.R.                      |
| 111      | 11+55.59 | 60.10   | 13,810,864.86 | 3,077,004.81        |           | SET X IN CONC.                     |
| 102      | 11+56.07 | 0.00    | 13,810,863.03 | 3,076,944.75        |           | SET X IN CONC.                     |
| 109      | 11+56.26 | -85.66  | 13,810,859.95 | 3,076,859.15        | 1         | SET X IN CONC.                     |
| 110      | 11+56.54 | -60.06  | 13,810,861.21 | 3,076,884.72        |           | SET X IN CONC.                     |
| 1106     | 11+86.44 | -60.32  | 13,810,891.08 | 3,076,883.32        |           | FND. 5/8"I.R.wMILLER SURVEY CO CAP |
| 3        | 11+92.13 | 4.65    | 13,810,899.24 | 3,076,948.01        | 57.88     | CH-3 SET 5/8"I.R.wLANDTECH CAP     |
| 1107     | 11+96.79 | -49.71  | 13,810,901.82 | 3,076,893.52        |           | FND. 5/8"I.R.                      |
| 103      | 13+00.00 | 0.00    | 13,811,006.84 | 3,076,939.24        |           | SET 5/8"I.R.wLANDTECH CAP          |
|          |          |         |               | WANDA LANE          |           |                                    |
| 104      | 1+00.00  | 0       | 13,810,730.40 | 3,076,199.22        |           | SET CONC. NAIL                     |
| 1        | 2+04.12  | -19.5   | 13,810,754.98 | 3,076,302.24        | 58.08     | CH-1 SET 5/8"I.R.wLANDTECH CAP     |
| 1103     | 2+99.72  | 29.92   | 13,810,710.32 | 3,076,400.14        |           | FND. 5/8"I.R.                      |
| 105      | 3+35.93  | 0       | 13,810,741.98 | 3,076,434.84        |           | SET X IN CONC.                     |
| 2        | 4+31.18  | 22.33   | 13,810,733.98 | 3,076,534.25        | 58.27     | CH-2 SET 5/8"I.R.wLANDTECH CAP     |
| 107      | 5+57.98  | 0       | 13,810,800.97 | 3,076,646.99        |           | SET X IN CONC.                     |
| 109      | 7+80.02  | 0       | 13,810,859.95 | 3,076,859.15        |           | SET X IN CONC.                     |
| 110      | 8+05.63  | 0       | 13,810,861.21 | 3,076,884.72        |           | SET X IN CONC.                     |
| 1107     | 8+15.66  | -40.33  | 13,810,901.82 | 3,076,893.52        |           | FND. 5/8"I.R.                      |
| 102      | 8+65.69  | 0       | 13,810,863.03 | 3,076,944.75        | ,         | SET X IN CONC.                     |
| 3        | 8+70.06  | -36.09  | 13,810,899.24 | 3,076,948.01        | 57.88     | CH-3 SET 5/8"I.R.wLANDTECH CAP     |
| 1109     | 9+25.24  | 29.43   | 13,810,835.42 | 3,077,005.15        |           | FND. 5/8"I.R.                      |
| 111      | 9+25.79  | 0       | 13,810,864.86 | 3,077,004.81        |           | SET X IN CONC.                     |
| 112      | 10+50.00 | l ol    | 13,810,869.77 | 3,077,128.91        |           | SET X IN CONC.                     |

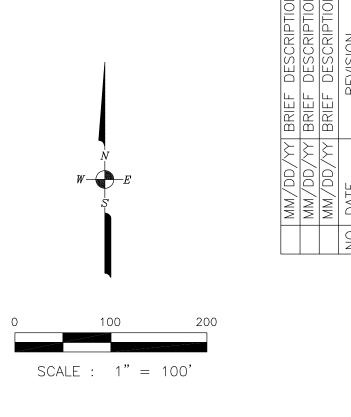

1. ALL COORDINATES AND BEARINGS SHOWN HEREON ARE REFRENCED TO THE TEXAS COORDINATE SYSTEM, SOUTH CENTRAL ZONE (4204), NORTH AMERICAN DATUM OF 1983/CORS (2011 ADJ.), EPOCH 2010.00. ALL COORDINATES ARE GRID VALUES AND CAN BE CONVERTED TO SURFACE BY DIVIDING BY THE COMBINED SCALE FACTOR OF 0.9998802.

2. ALL ELEVATIONS SHOWN HEREON ARE REFERENCED TO THE NORTH AMERICAN VERTICAL DATUM OF 1988 (NAVD 88/GEOID18).

3. THE ELEVATION DIFFERENCE BETWEEN THE FLOODPLAIN REFERENCE MARK NO. 040200 PUBLISHED DATUM (NAVD88, 2001 ADJ.) AND THE PROJECT VERTICAL DATUM (NAVD88/GEOID18) IS 0.14 FEET. PROJECT DATUM + 0.14 FÉET = FLOODPLAIN DATUM

4. THIS IS NOT A BOUNDARY SURVEY.

#### PROJECT BENCHMARK:

CITY OF HOUSTON MONUMENT NO. 5053-8115, A BRASS DISK ON SIDEWALK OF BRIDGE AT FONDREN RD. (NORTH BOUND) OVER BRAYS BAYOU, APPROXIMATELY 150 FEET NORTH OF SOUTH BRAESWOOD BLVD.

ELEVATION = 59.14 FEET (NAVD88/GEOID18)

LANDTECH 1315 W Sam Houston Parkway N, Suite 100 Houston, Texas 77043 T: 713-861-7068 F: 713-861-4131

FOR REVIEW ONLY
SEPTEMBER, 2024 HONG YANG R.P.L.S. No. 6557 NOT FOR BIDDING OR CONSTRUCTION

TBPELS No. 10019100

HOUSTON, TX. 77094 281-945-0069

TX FIRM NUMBER: F-6932 SURVEYED BY: LANDTECH, INC.

FB NO. P-6331

OF INTERIM REVIEW UNDER 15021 KATY FREEWAY, STE. 500 THE AUTHORITY OF JUAN OLIVAREZ TEXAS REG. NO. 55474 June 12, 2025

THIS DOCUMENT IS

RELEASED FOR PURPOSE


IT IS NOT TO BE USED FOR CONSTRUCTION PURPOSES


HOUSTON PUBLIC WORKS


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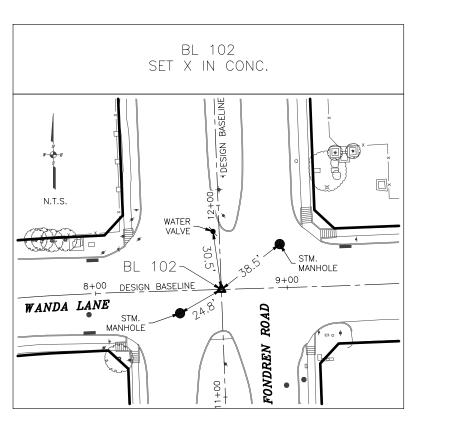
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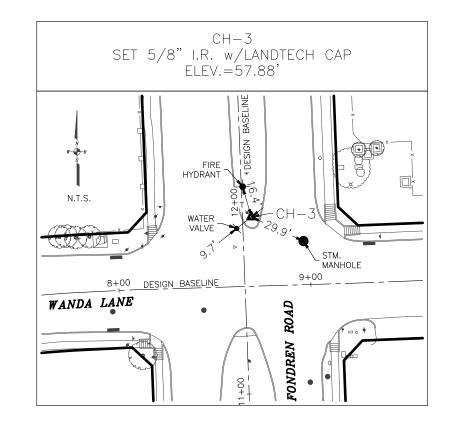
| WBS NUMBER         | FOR CITY OF HOUSTON USE ONLY |
|--------------------|------------------------------|
| M-410040-001A-3    |                              |
| DRAWING SCALE      |                              |
| AS NOTED           |                              |
| CITY OF HOUSTON PM |                              |
| RICHARD SMITH      |                              |
| SHEET NO. OF       |                              |







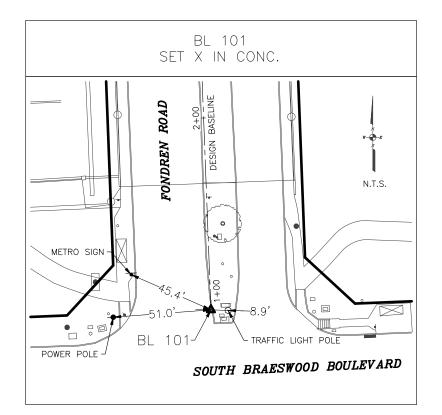


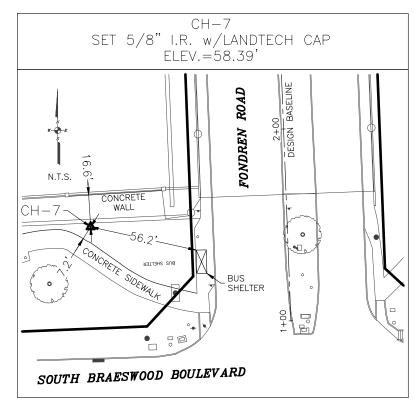


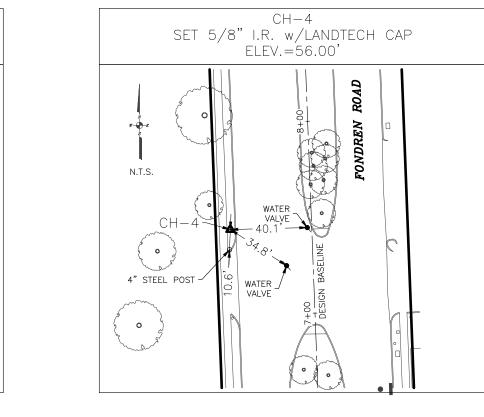


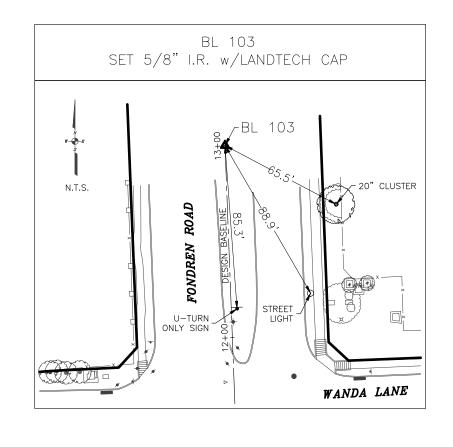


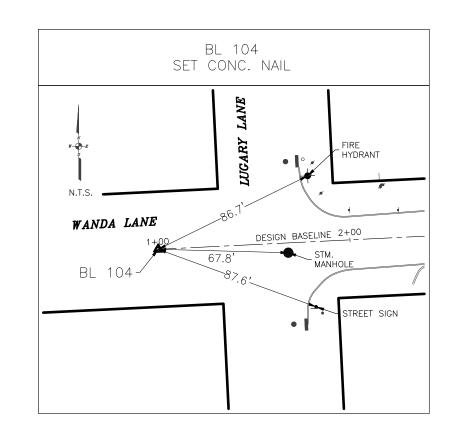


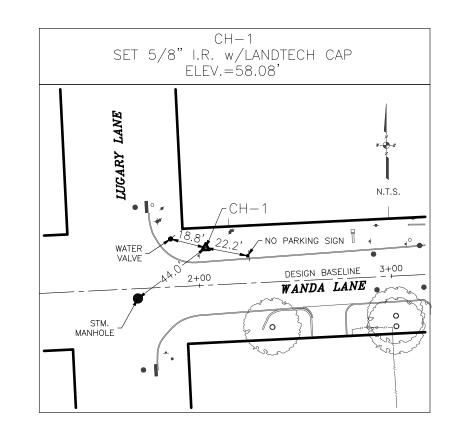


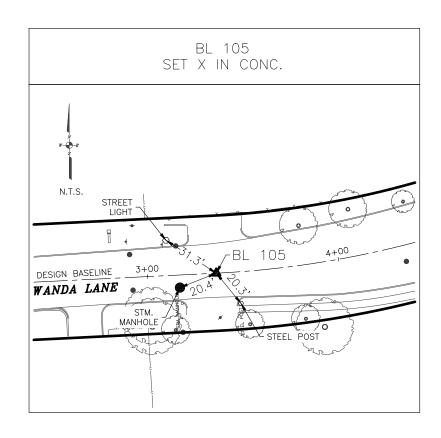


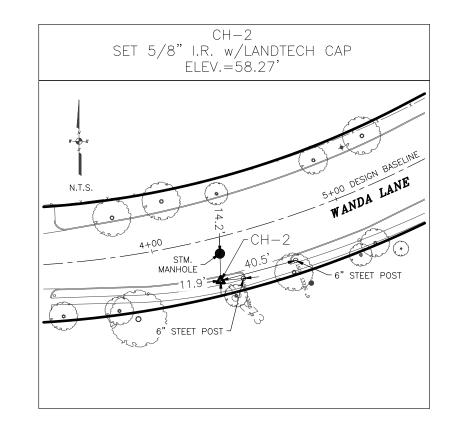


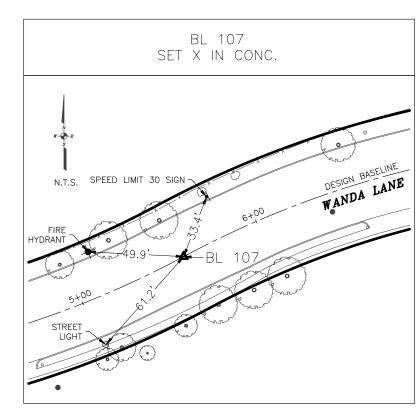

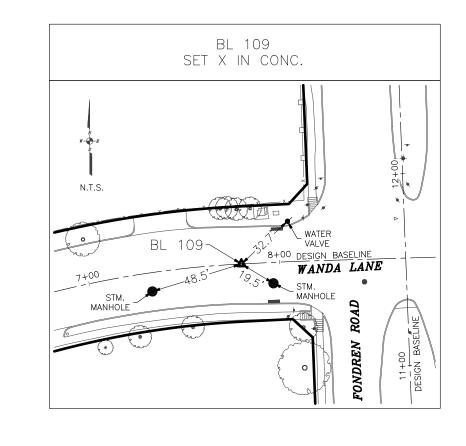

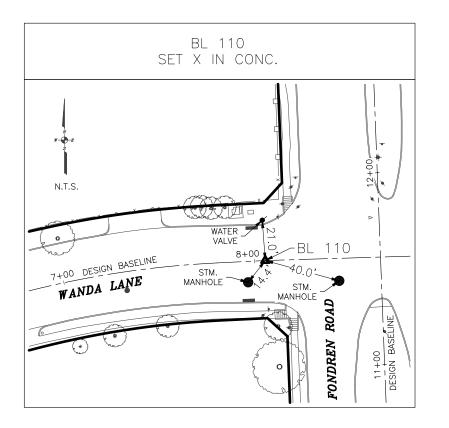

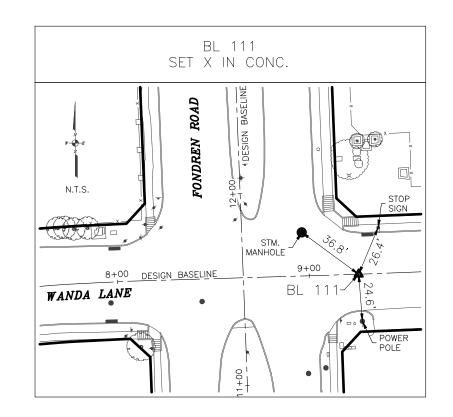

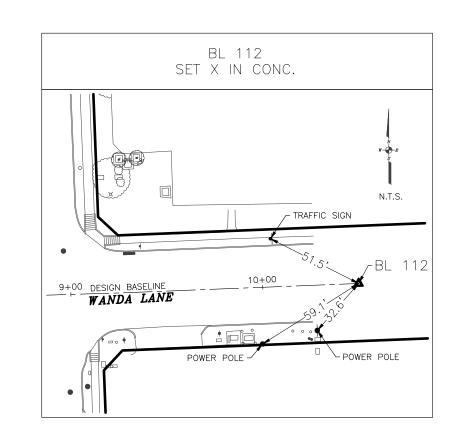

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2. ALL ELEVATIONS SHOWN HEREON ARE REFERENCED TO THE NORTH AMERICAN VERTICAL DATUM OF 1988 (NAVD 88/GEOID18).

3. THE ELEVATION DIFFERENCE BETWEEN THE FLOODPLAIN REFERENCE MARK NO. 040200 PUBLISHED DATUM (NAVD88, 2001 ADJ.) AND THE PROJECT VERTICAL DATUM (NAVD88/GEOID18) IS 0.14 FEET. PROJECT DATUM + 0.14 FEET = FLOODPLAIN DATUM

4. THIS IS NOT A BOUNDARY SURVEY.

#### PROJECT BENCHMARK:


CITY OF HOUSTON MONUMENT NO. 5053-8115, A BRASS DISK ON SIDEWALK OF BRIDGE AT FONDREN RD. (NORTH BOUND) OVER BRAYS BAYOU, APPROXIMATELY 150 FEET NORTH OF SOUTH BRAESWOOD BLVD.

ELEVATION = 59.14 FEET (NAVD88/GEOID18)

#### CONSULTANT:

LANDTECH

1315 W Sam Houston Parkway N, Suite 100 Houston, Texas 77043 T: 713-861-7068 F: 713-861-4131 TBPELS No. 10019100

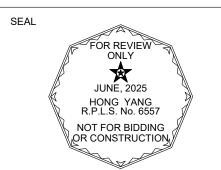

15021 KATY FREEWAY, STE. 500 HOUSTON, TX. 77094 281-945-0069

TX FIRM NUMBER: F-6932 SURVEYED BY: LANDTECH, INC. FB NO. P-6331

THIS DOCUMENT IS RELEASED FOR PURPOSE OF INTERIM REVIEW UNDER THE AUTHORITY OF JUAN OLIVAREZ TEXAS REG. NO. 55474 June 12, 2025

IT IS NOT TO BE USED FOR CONSTRUCTION PURPOSES

HOUSTON PUBLIC WORKS

SHARPSTOWN AREA DETENTION POND "A"


> SWING TIES SHEET 1 OF 1

WBS NUMBER FOR CITY OF HOUSTON USE ONLY M-410040-001A-3DRAWING SCALE

AS NOTED CITY OF HOUSTON PM RICHARD SMITH

OF SHEET NO.



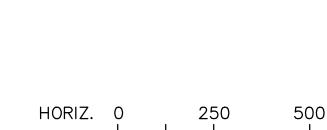

HOUSTON, TX. 77094 281-945-0069

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THE AUTHORITY OF
RODRIGO GUADARRAMA
TEXAS REG. NO. 111437
OCTOBER 15, 2025 TX FIRM NUMBER: F-6932 IT IS NOT TO BE USED FOR CONSTRUCTION PURPOSES SURVEYED BY: LANDTECH, INC.

SCALE: 1"=250'


HOUSTON PUBLIC WORKS

SHARPSTOWN AREA DETENTION POND A

OVERALL LAYOUT

| WBS NUMBER                | FOR CITY OF HOUSTON USE ONLY |
|---------------------------|------------------------------|
| M-410040-001A-4           |                              |
| DRAWING SCALE             |                              |
| AS NOTED                  |                              |
| CITY OF HOUSTON PM        |                              |
| SUPUN ILANGAMUDALIGE P.E. |                              |
| SHEET NO. 10 OF 42        |                              |



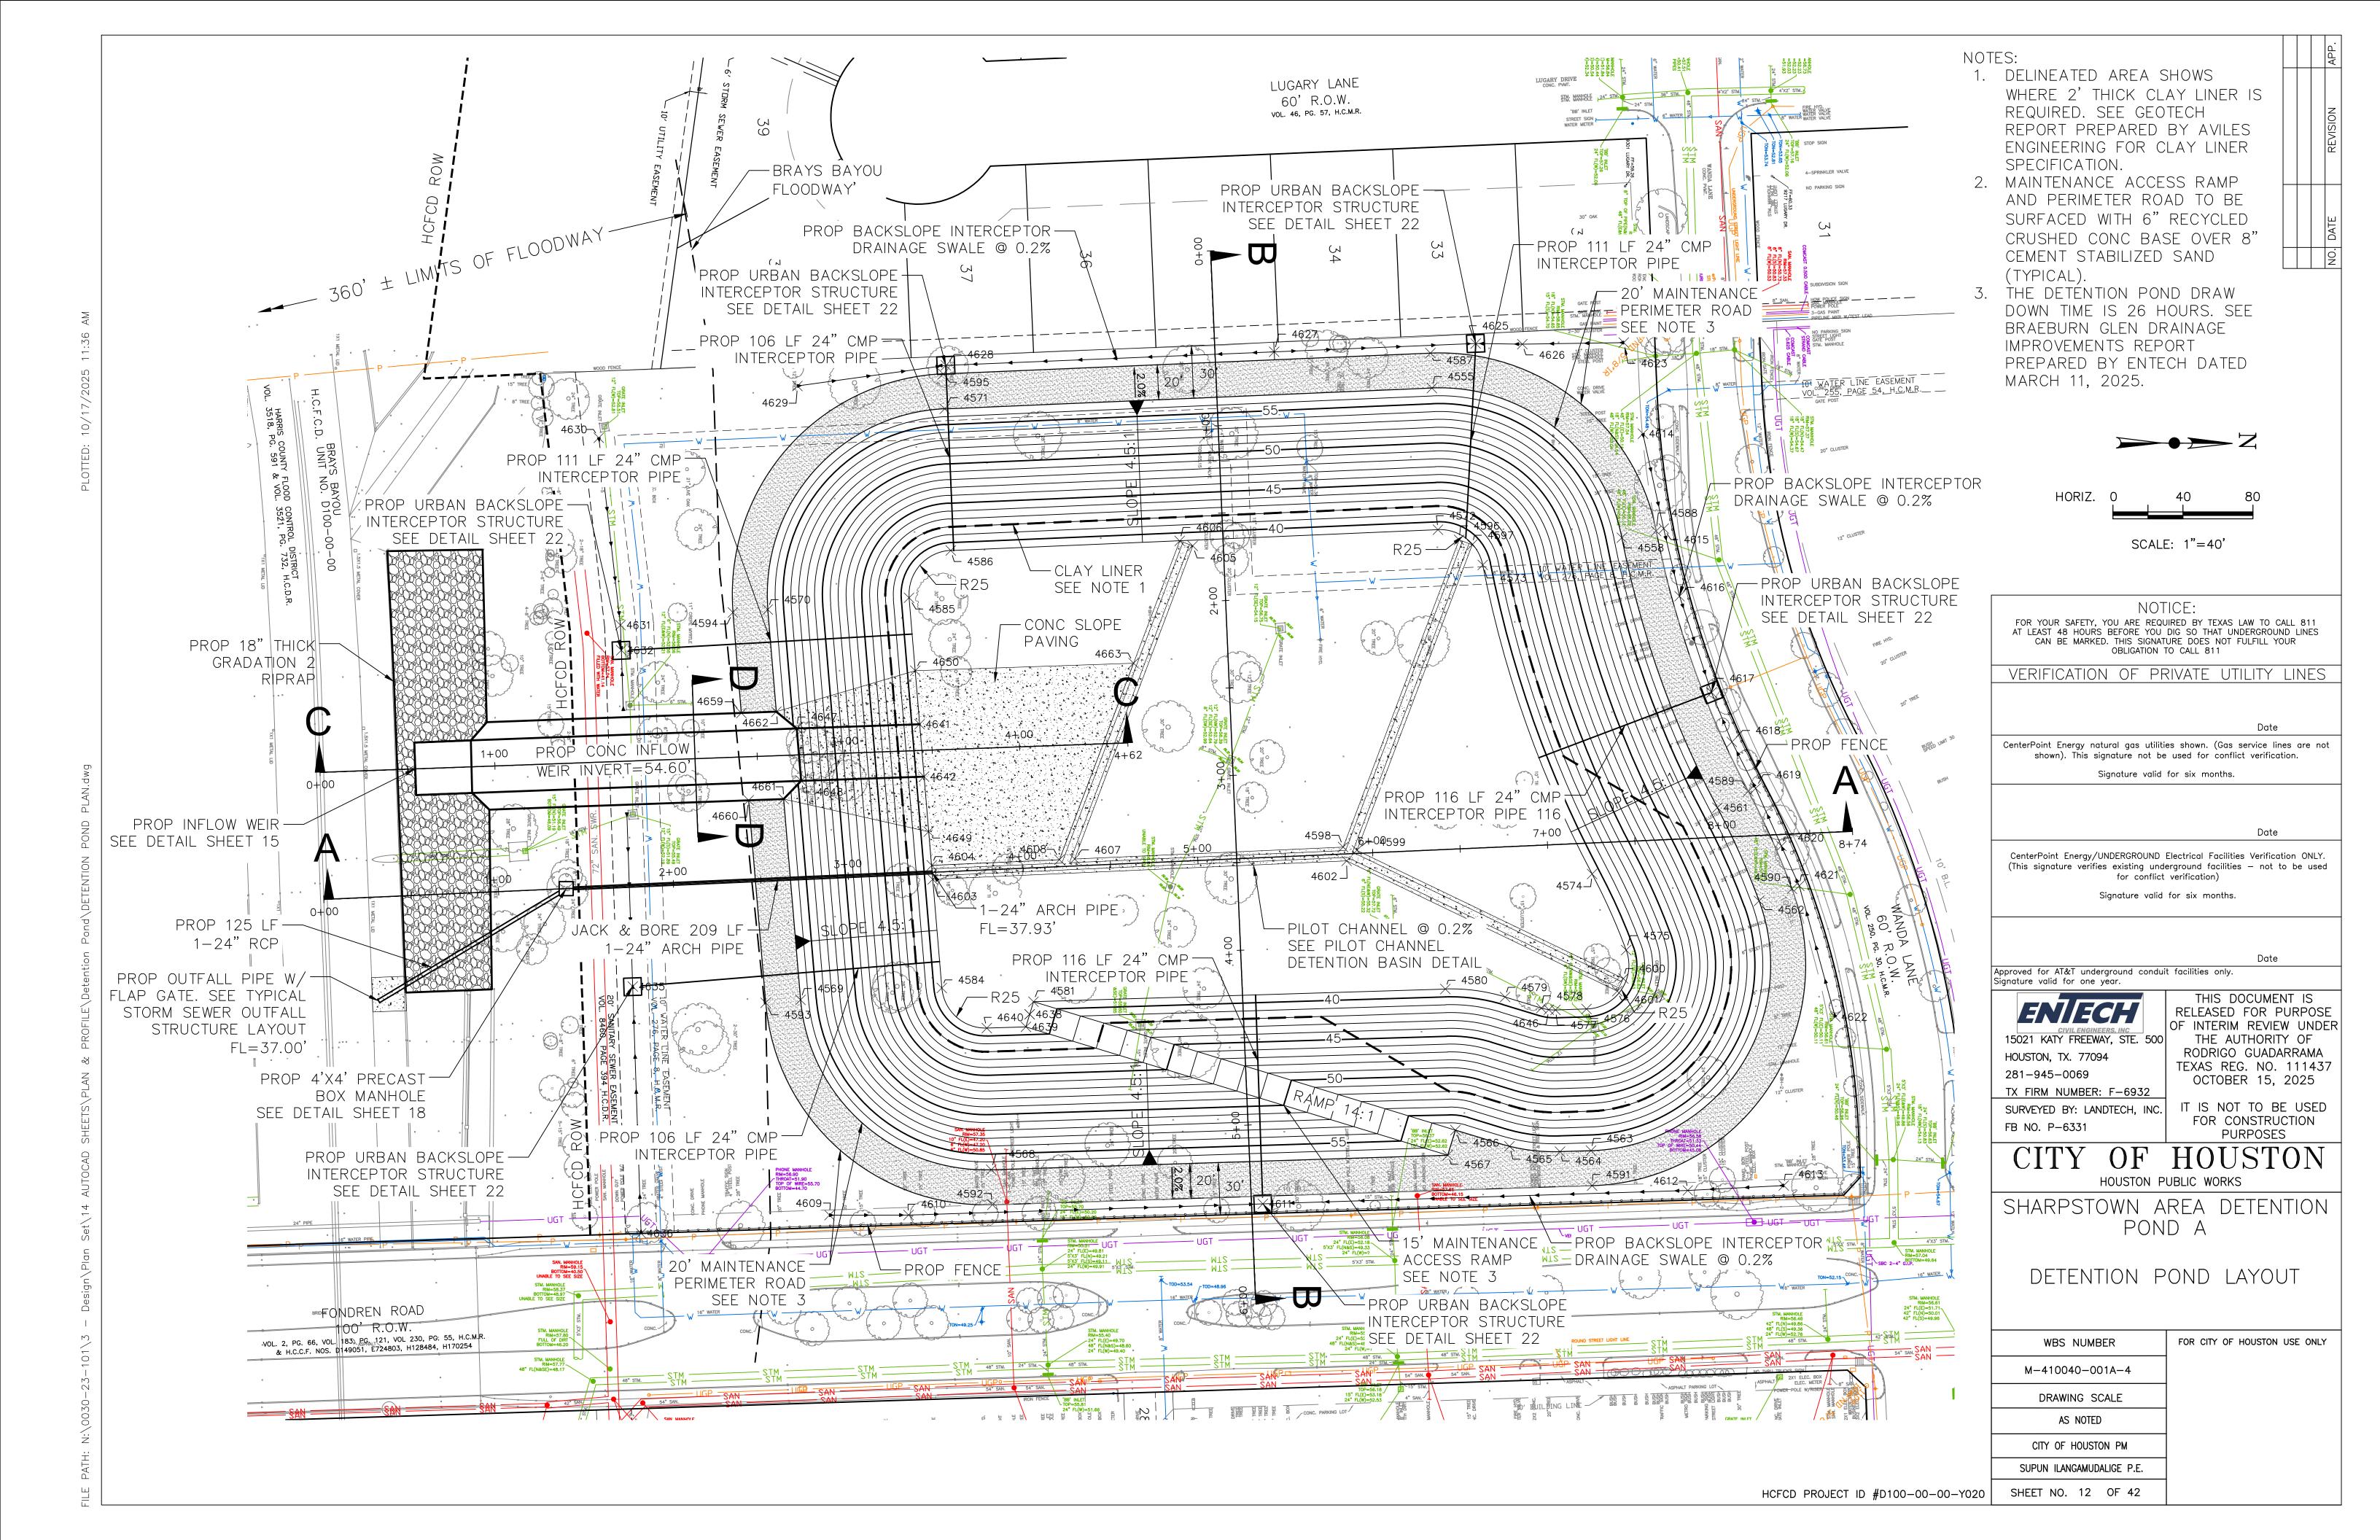

SECTION A-A POND OUTFALL SCALE H: 1"=40', V: 1"=4'

|                                    | DETENTION POND STORAGE VOLUME TABLE |                               |                                  |  |   |  |  |  |
|------------------------------------|-------------------------------------|-------------------------------|----------------------------------|--|---|--|--|--|
| WATER SURFACE<br>ELEVATION<br>(FT) | WATER DEPTH<br>(FT)                 | TOTAL WATER SUFRACE AREA (SF) | WATER VOLUME<br>@1' DEEP<br>(CF) | ACCUMULATIVE<br>STORAGE VOLUME<br>(CF) | ACCUMULATIVE<br>STORAGE VOLUME<br>(AC-FT) |  |  |  |
| 54.6*                              | 15.6                                | 199,701                       | 118,412                          | 2,249,850                              | 51.65                                     |  |  |  |
| 54                                 | 15                                  | 195,007                       | 191,192                          | 2,131,438                              | 48.93                                     |  |  |  |
| 53                                 | 14                                  | 187,378                       | 183,627                          | 1,940,246                              | 44.54                                     |  |  |  |
| 52                                 | 13                                  | 179,876                       | 176,189                          | 1,756,618                              | 40.33                                     |  |  |  |
| 51                                 | 12                                  | 172,502                       | 168,879                          | 1,580,429                              | 36.28                                     |  |  |  |
| 50                                 | 11                                  | 165,255                       | 161,695                          | 1,411,551                              | 32.40                                     |  |  |  |
| 49                                 | 10                                  | 158,135                       | 154,639                          | 1,249,856                              | 28.69                                     |  |  |  |
| 48                                 | 9                                   | 151,143                       | 147,710                          | 1,095,217                              | 25.14                                     |  |  |  |
| 47                                 | 8                                   | 144,277                       | 140,908                          | 947,507                                | 21.75                                     |  |  |  |
| 46                                 | 7                                   | 137,539                       | 134,234                          | 806,598                                | 18.52                                     |  |  |  |
| 45                                 | 6                                   | 130,928                       | 127,687                          | 672,364                                | 15.44                                     |  |  |  |
| 44                                 | 5                                   | 124,445                       | 121,267                          | 544,678                                | 12.50                                     |  |  |  |
| 43                                 | 4                                   | 118,088                       | 114,974                          | 423,411                                | 9.72                                      |  |  |  |
| 42                                 | 3                                   | 111,859                       | 108,808                          | 308,437                                | 7.08                                      |  |  |  |
| 41                                 | 2                                   | 105,757                       | 102,770                          | 199,629                                | 4.58                                      |  |  |  |
| 40                                 | 1                                   | 99,783                        | 96,859                           | 96,859                                 | 2.22                                      |  |  |  |
| 39                                 | 0                                   | 93,935                        | 0                                | 0                                      | 0.00                                      |  |  |  |

\* TOTAL POND VOLUME IS CALCULATED UP TO ELEVATION 54.6', CORRESPONDING TO THE WEIR INLET ELEVATION, WHICH IS CONSIDERED THE TOTAL STORAGE ELEVATION. THE TOP OF POND IS AT ELEVATION 57.0'.

FOR YOUR SAFETY, YOU ARE REQUIRED BY TEXAS LAW TO CALL 811
AT LEAST 48 HOURS BEFORE YOU DIG SO THAT UNDERGROUND LINES
CAN BE MARKED. THIS SIGNATURE DOES NOT FULFILL YOUR
OBLIGATION TO CALL 811

VERIFICATION OF PRIVATE UTILITY LINES

CenterPoint Energy natural gas utilities shown. (Gas service lines are not shown). This signature not be used for conflict verification.

Signature valid for six months.

CenterPoint Energy/UNDERGROUND Electrical Facilities Verification ONLY. (This signature verifies existing underground facilities — not to be used for conflict verification)

Signature valid for six months.

Approved for AT&T underground conduit facilities only. Signature valid for one year.

15021 KATY FREEWAY, STE. 500

HOUSTON, TX. 77094

281-945-0069 TX FIRM NUMBER: F-6932 SURVEYED BY: LANDTECH, INC. FB NO. P-6331

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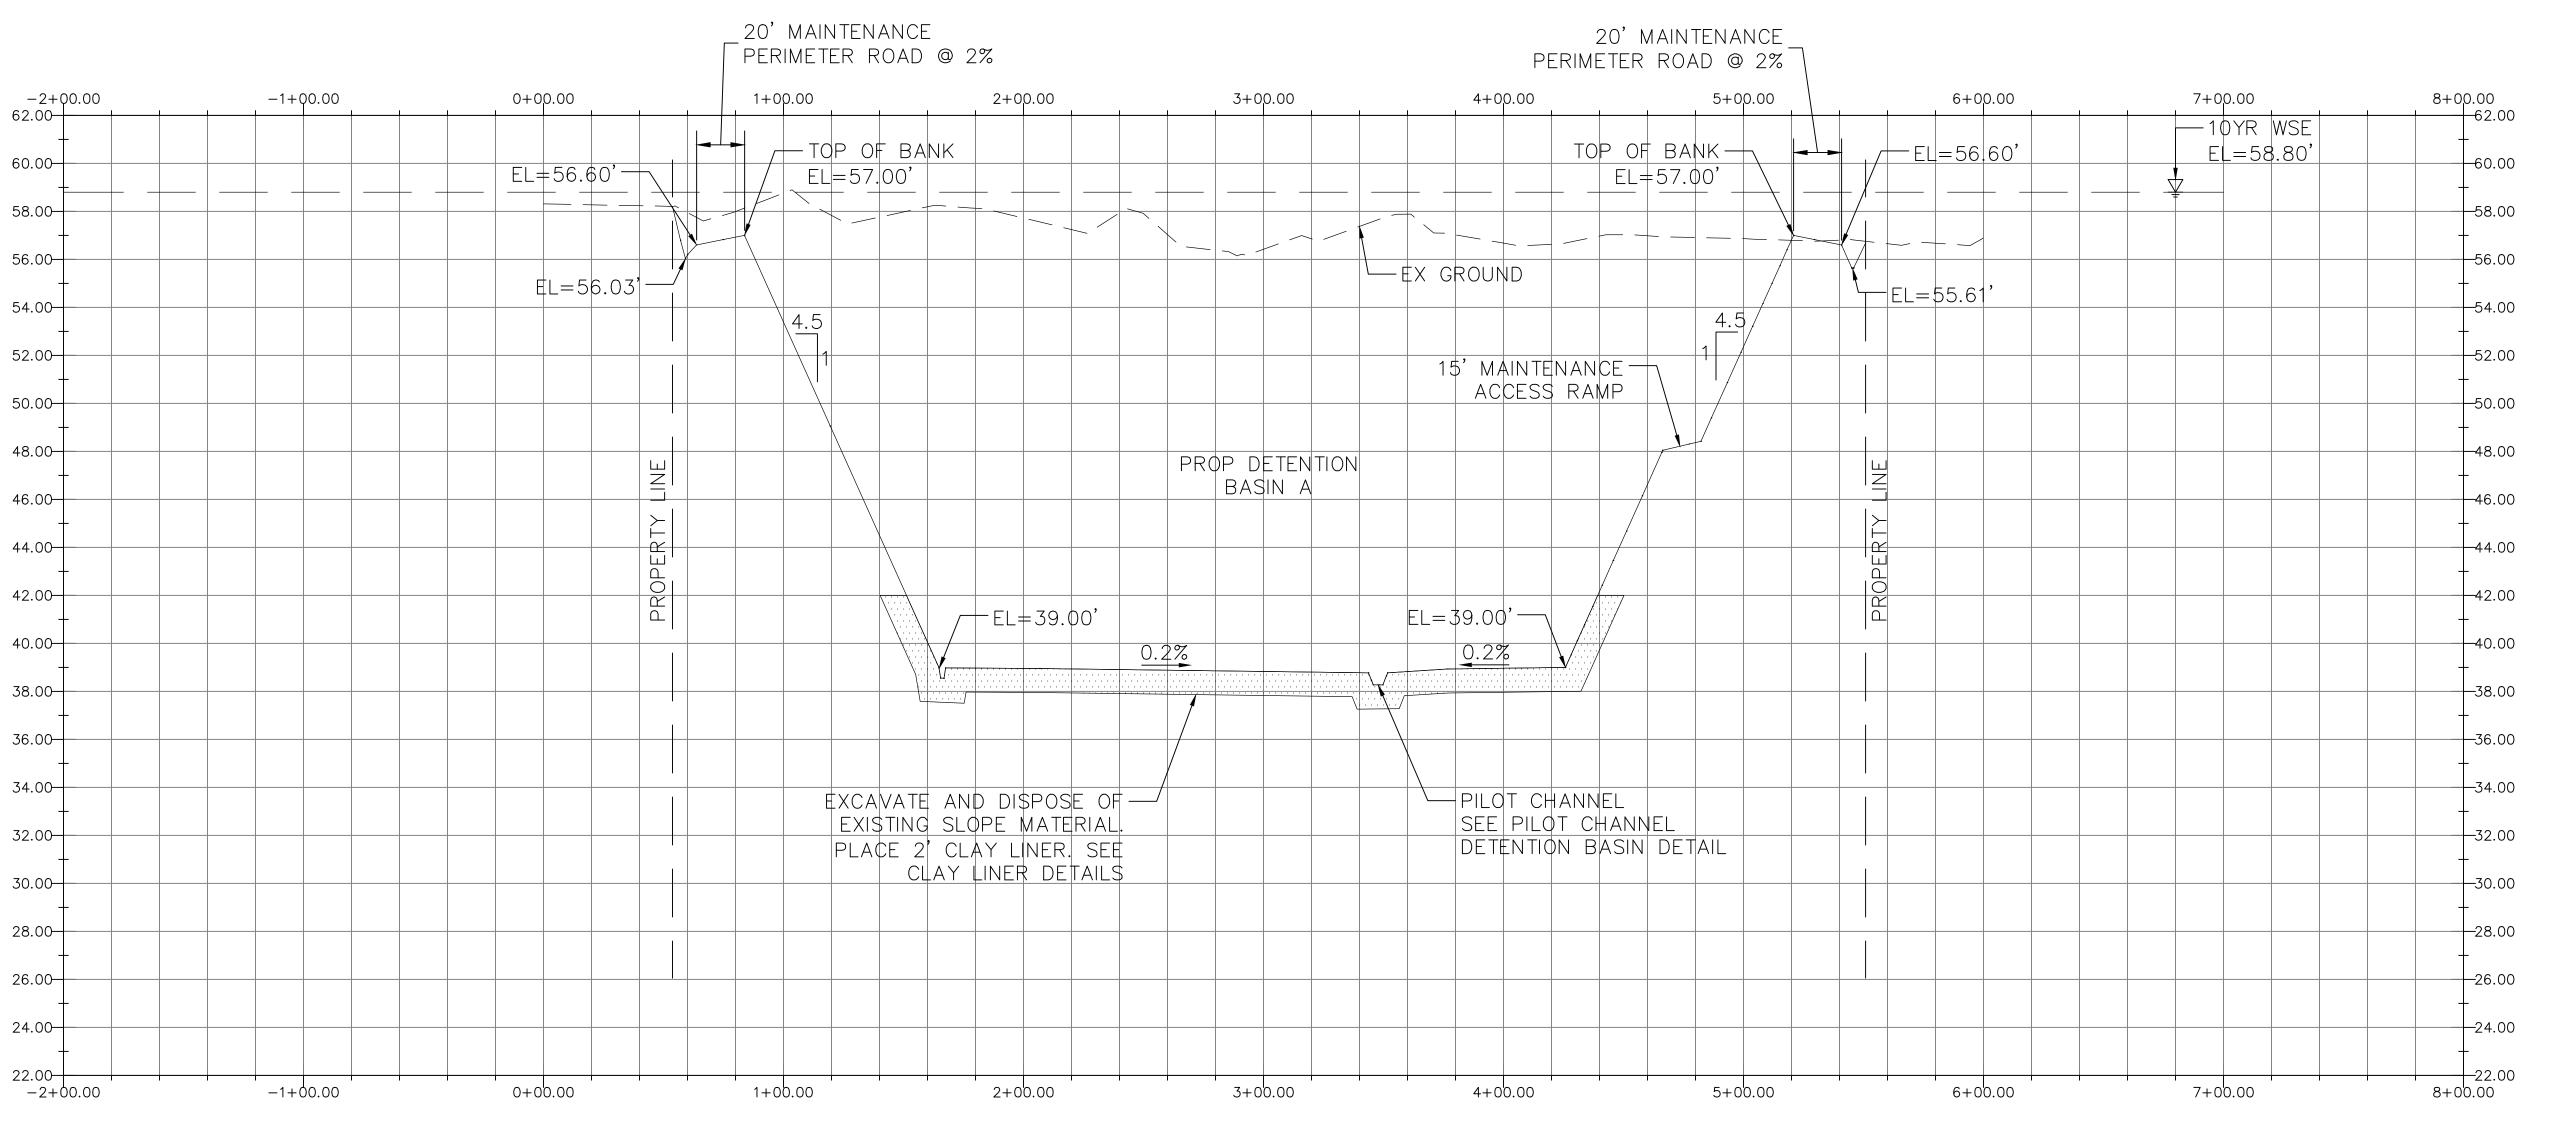
CITY OF HOUSTON

HOUSTON PUBLIC WORKS

SHARPSTOWN AREA DETENTION POND A

> POND OUTFALL SECTION A-A

|     | WBS NUMBER                | FOR CITY OF HOUSTON USE ONLY |
|-----|---------------------------|------------------------------|
|     | M-410040-001A-4           |                              |
|     | DRAWING SCALE             |                              |
|     | AS NOTED                  |                              |
|     | CITY OF HOUSTON PM        |                              |
|     | SUPUN ILANGAMUDALIGE P.E. |                              |
| 020 | SHEET NO. 13 OF 42        |                              |



SECTION B-B POND W-E SCALE H: 1"=40', V: 1"=4'

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15021 KATY FREEWAY, STE. 500 HOUSTON, TX. 77094 281-945-0069 OCTOBER 15, 2025

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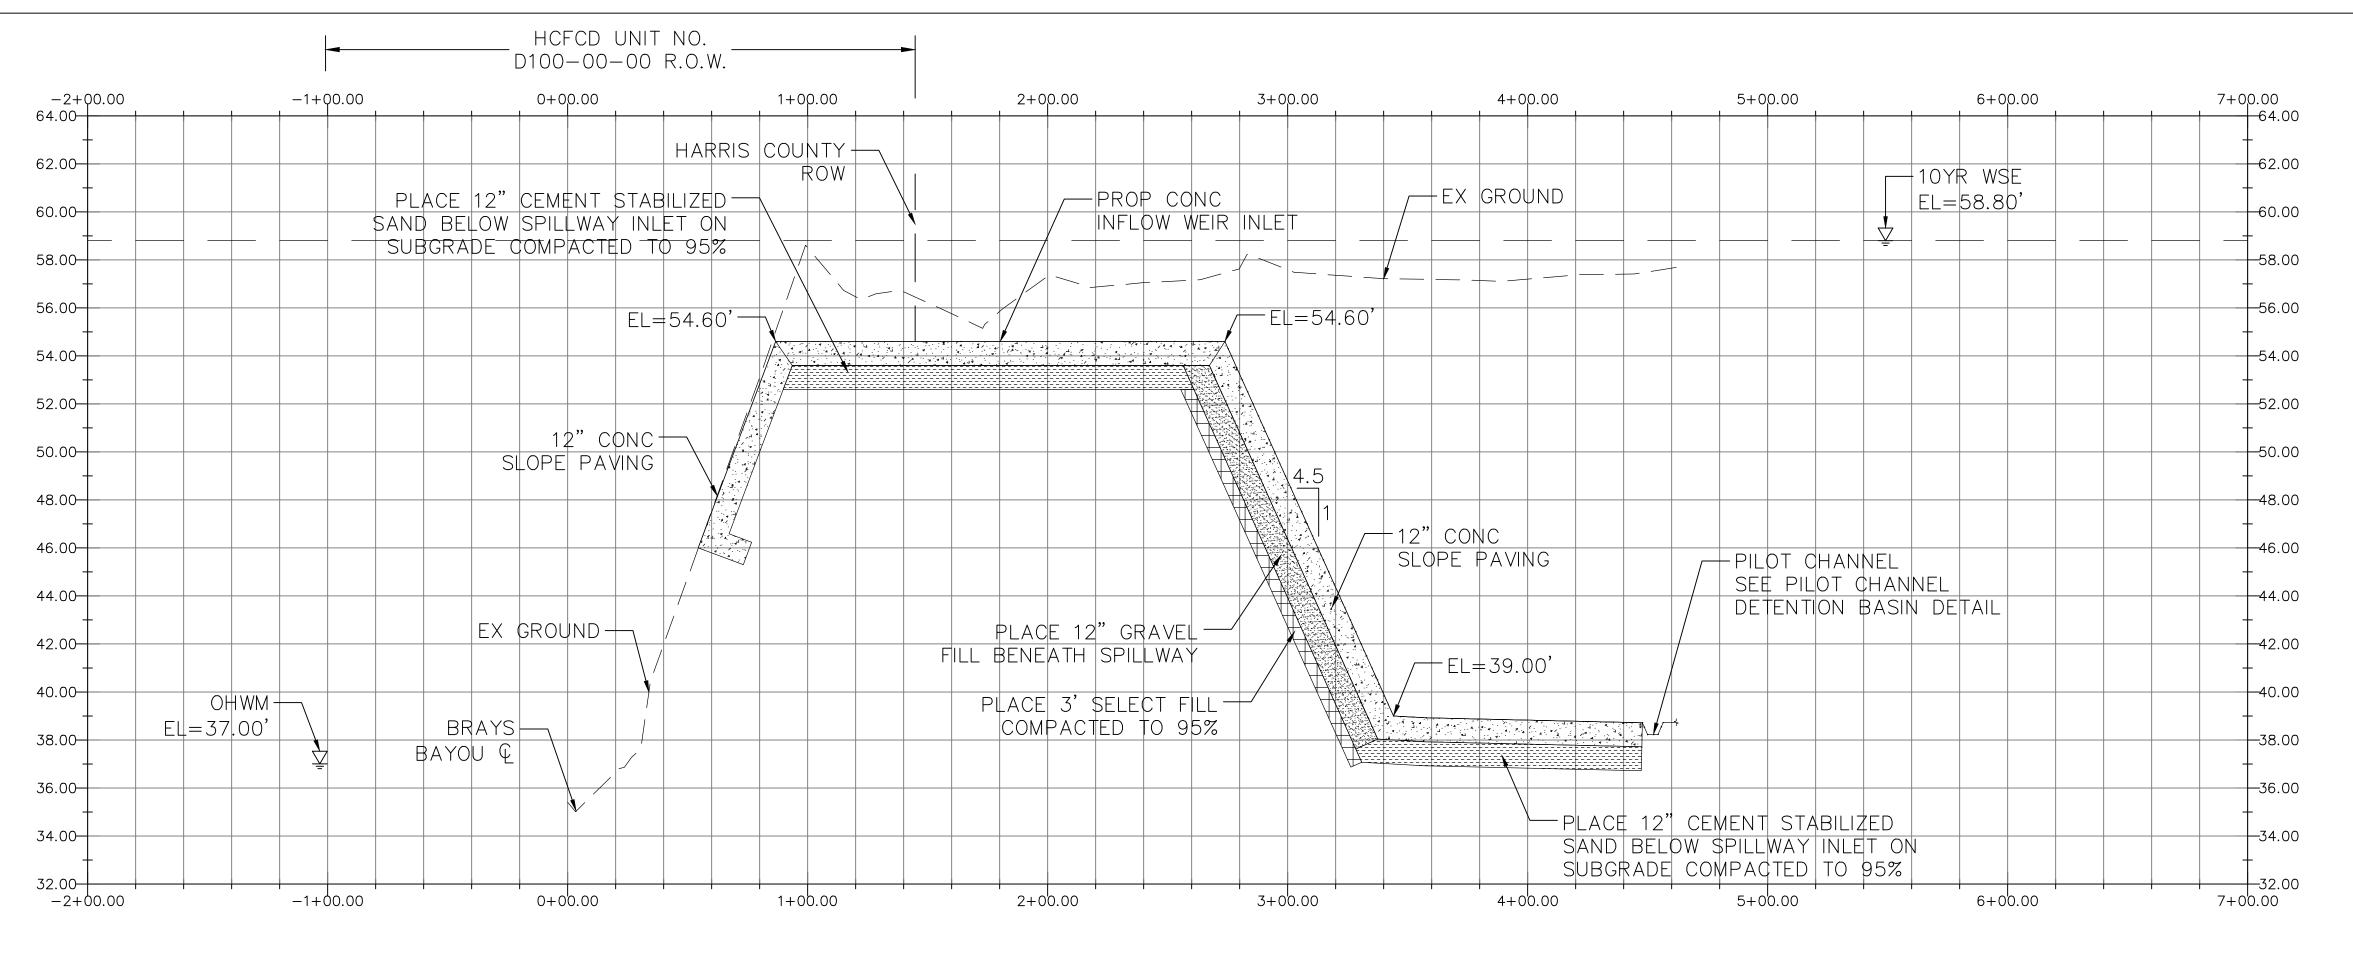
IT IS NOT TO BE USED FOR CONSTRUCTION **PURPOSES** 

OF HOUSTON HOUSTON PUBLIC WORKS


SHARPSTOWN AREA DETENTION POND A

POND SECTION B-B

FOR CITY OF HOUSTON USE ONLY WBS NUMBER M-410040-001A-4 DRAWING SCALE AS NOTED CITY OF HOUSTON PM SUPUN ILANGAMUDALIGE P.E. SHEET NO. 14 OF 42



SECTION C-C POND INFLOW WEIR SCALE H: 1"=40', V: 1"=4'

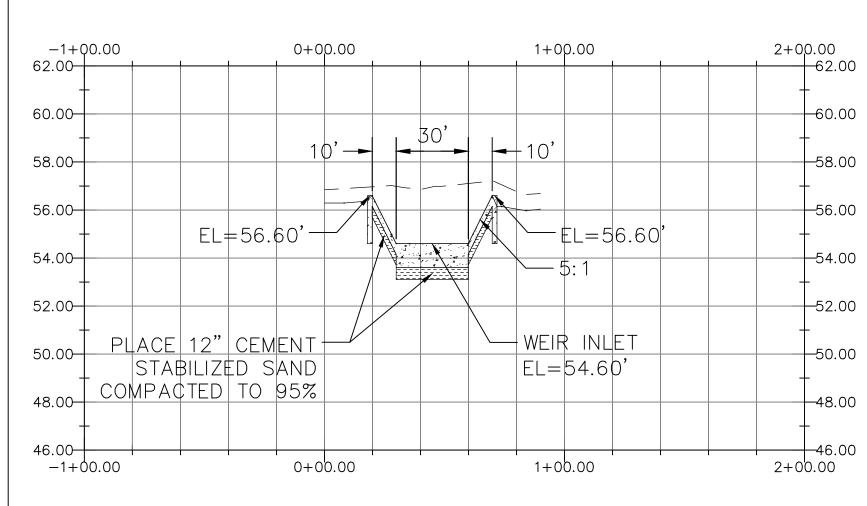

SECTION D-D POND INFLOW WEIR CONCRETE APRON SCALE H: 1"=40', V: 1"=4'

CenterPoint Energy natural gas utilities shown. (Gas service lines are not shown). This signature not be used for conflict verification. Signature valid for six months. CenterPoint Energy/UNDERGROUND Electrical Facilities Verification ONLY. (This signature verifies existing underground facilities — not to be used for conflict verification) Signature valid for six months. Date Approved for AT&T underground conduit facilities only. Signature valid for one year. THIS DOCUMENT IS RELEASED FOR PURPOSE OF INTERIM REVIEW UNDER THE AUTHORITY OF 15021 KATY FREEWAY, STE. 500 RODRIGO GUADARRAMA HOUSTON, TX. 77094 TEXAS REG. NO. 111437 281-945-0069 OCTOBER 15, 2025 TX FIRM NUMBER: F-6932 IT IS NOT TO BE USED SURVEYED BY: LANDTECH, INC. FOR CONSTRUCTION FB NO. P-6331 PURPOSES

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VERIFICATION OF PRIVATE UTILITY LINES

OF HOUSTON HOUSTON PUBLIC WORKS

SHARPSTOWN AREA DETENTION POND A

POND INFLOW WEIR SECTIONS C-C & D-D

FOR CITY OF HOUSTON USE ONLY WBS NUMBER M-410040-001A-4 DRAWING SCALE AS NOTED CITY OF HOUSTON PM SUPUN ILANGAMUDALIGE P.E. SHEET NO. 15 OF 42

| Point Table |           |             |            |             |
|-------------|-----------|-------------|------------|-------------|
| Point #     | Elevation | Northing    | Easting    | Description |
|             |           |             |            |             |
|             |           |             |            |             |
| 4555        | 57.00     | 13812238.17 | 3076805.30 | PR          |
| 4558        | 57.00     | 13812347.26 | 3076890.11 | PR          |
| 4561        | 57.00     | 13812402.85 | 3077044.03 | PR          |
| 4562        | 57.00     | 13812427.01 | 3077097.15 | PR          |
| 4563        | 57.00     | 13812331.88 | 3077240.46 | PR          |
| 4564        | 57.00     | 13812314.18 | 3077241.14 | PR          |
| 4565        | 57.00     | 13812285.27 | 3077238.26 | PR          |
| 4566        | 57.00     | 13812254.32 | 3077229.21 | PR          |
| 4567        | 57.00     | 13812250.05 | 3077243.59 | PR          |
| 4568        | 57.00     | 13811989.26 | 3077253.58 | PR          |
| 4569        | 57.00     | 13811879.64 | 3077157.20 | PR          |
| 4570        | 57.00     | 13811859.49 | 3076934.27 | PR          |
| 4571        | 57.00     | 13811959.87 | 3076818.98 | PR          |
| 4572        | 39.00     | 13812242.15 | 3076886.20 | PR          |
| 4573        | 39.00     | 13812267.88 | 3076906.20 | PR          |
| 4574        | 39.00     | 13812331.51 | 3077082.38 | PR          |
| 4575        | 39.00     | 13812351.22 | 3077125.72 | PR          |
| 4576        | 39.00     | 13812328.78 | 3077159.52 | PR          |

| Point Table |           |              |            |             |
|-------------|-----------|--------------|------------|-------------|
| Point #     |           |              |            |             |
| 1 01110 #   | Elevation | 1101 tilling | Lasting    | Description |
| 4577        | 39.00     | 13812311.08  | 3077160.20 | PR          |
| 4578        | 39.00     | 13812303.00  | 3077159.18 | PR          |
| 4579        | 39.00     | 13812282.19  | 3077153.00 | PR          |
| 4580        | 39.00     | 13812248.06  | 3077148.67 | PR          |
| 4581        | 39.00     | 13812012.77  | 3077157.41 | PR          |
| 4584        | 39.00     | 13811960.31  | 3077149.91 | PR          |
| 4585        | 39.00     | 13811940.17  | 3076927.04 | PR          |
| 4586        | 39.00     | 13811963.85  | 3076899.88 | PR          |
| 4587        | 56.60     | 13812237.19  | 3076785.32 | PR          |
| 4588        | 56.60     | 13812366.86  | 3076886.14 | PR          |
| 4589        | 56.60     | 13812420.47  | 3077034.56 | PR          |
| 4590        | 56.60     | 13812445.73  | 3077090.10 | PR          |
| 4591        | 56.60     | 13812332.65  | 3077260.45 | PR          |
| 4592        | 56.60     | 13811990.03  | 3077273.56 | PR          |
| 4593        | 56.60     | 13811859.72  | 3077159.00 | PR          |
| 4594        | 56.60     | 13811839.57  | 3076936.06 | PR          |
| 4595        | 56.60     | 13811958.89  | 3076799.00 | PR          |
| 4596        | 39.00     | 13812254.27  | 3076891.92 | PR          |
| 4597        | 39.00     | 13812261.78  | 3076894.70 | PR          |
| 4598        | 38.90     | 13812189.15  | 3077067.90 | PR          |

| Point Table |           |             |            |             |
|-------------|-----------|-------------|------------|-------------|
| Point #     | Elevation | Northing    | Easting    | Description |
| 4619        | 55.67     | 13812424.62 | 3077032.84 | PR          |
| 4620        | 55.60     | 13812439.57 | 3077065.69 | PR          |
| 4621        | 55.55     | 13812449.91 | 3077088.39 | PR          |
| 4622        | 55.71     | 13812470.94 | 3077163.11 | PR          |
| 4623        | 56.04     | 13812347.63 | 3076778.62 | PR          |
| 4625        | 55.87     | 13812263.03 | 3076779.67 | PR          |
| 4626        | 55.92     | 13812289.69 | 3076779.88 | PR          |
| 4627        | 56.10     | 13812147.95 | 3076785.16 | PR          |
| 4628        | 55.72     | 13811960.34 | 3076794.10 | PR          |
| 4629        | 55.90     | 13811875.65 | 3076806.41 | PR          |
| 4630        | 55.66     | 13811762.32 | 3076836.77 | PR          |
| 4631        | 0.00      | 13811775.37 | 3076943.73 | PR          |
| 4632        | 55.86     | 13811775.95 | 3076958.08 | PR          |
| 4635        | 55.36     | 13811783.70 | 3077150.16 | PR          |
| 4636        | 0.00      | 13811789.38 | 3077291.20 | PR          |
| 4638        | 39.00     | 13812010.63 | 3077164.59 | PR          |
| 4639        | 39.00     | 13812008.49 | 3077171.78 | PR          |
| 4640        | 39.00     | 13811986.16 | 3077172.64 | PR          |
| 4641        | 39.00     | 13811946.69 | 3076999.24 | PR          |
| 4642        | 39.00     | 13811949.40 | 3077029.16 | PR          |

|         | Point Table |             |            |             |
|---------|-------------|-------------|------------|-------------|
| Point # | Elevation   | Northing    | Easting    | Description |
| 4646    | 39.00       | 13812307.26 | 3077160.05 | PR          |
| 4647    | 54.60       | 13811876.47 | 3077002.10 | PR          |
| 4648    | 54.60       | 13811879.17 | 3077032.02 | PR          |
| 4649    | 39.00       | 13811952.24 | 3077060.62 | PR          |
| 4650    | 39.00       | 13811943.93 | 3076968.68 | PR          |
| 4659    | 56.60       | 13811844.76 | 3076993.47 | PR          |
| 4660    | 56.60       | 13811849.27 | 3077043.33 | PR          |
| 4661    | 57.00       | 13811869.27 | 3077042.47 | PR          |
| 4662    | 57.00       | 13811864.77 | 3076992.62 | PR          |
| 4663    | 38.82       | 13812068.70 | 3076963.60 | PR          |

| Point Table |           |             |            |             |
|-------------|-----------|-------------|------------|-------------|
| Point #     | Elevation | Northing    | Easting    | Description |
| 4599        | 38.90     | 13812197.01 | 3077069.71 | PR          |
| 4600        | 39.00     | 13812349.73 | 3077141.97 | PR          |
| 4601        | 39.00     | 13812346.31 | 3077149.21 | PR          |
| 4602        | 38.90     | 13812191.18 | 3077075.81 | PR          |
| 4603        | 38.43     | 13811954.72 | 3077087.84 | PR          |
| 4604        | 38.43     | 13811954.16 | 3077079.86 | PR          |
| 4605        | 38.97     | 13812102.12 | 3076896.33 | PR          |
| 4606        | 38.97     | 13812094.62 | 3076893.55 | PR          |
| 4607        | 38.58     | 13812035.74 | 3077075.71 | PR          |
| 4608        | 38.58     | 13812027.04 | 3077076.15 | PR          |
| 4609        | 56.10     | 13811896.97 | 3077280.11 | PR          |
| 4610        | 56.01     | 13811942.13 | 3077279.75 | PR          |
| 4611        | 55.60     | 13812144.55 | 3077272.07 | PR          |
| 4612        | 56.09     | 13812387.35 | 3077262.86 | PR          |
| 4613        | 56.20     | 13812442.19 | 3077259.69 | PR          |
| 4614        | 56.10     | 13812358.94 | 3076830.62 | PR          |
| 4615        | 55.99     | 13812371.14 | 3076884.75 | PR          |
| 4616        | 55.91     | 13812380.44 | 3076923.32 | PR          |
| 4617        | 55.79     | 13812399.09 | 3076978.23 | PR          |
| 4618        | 55.73     | 13812410.90 | 3077006.43 | PR          |

NOTIC

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15021 KATY FREEWAY, STE. 500
HOUSTON, TX. 77094

281-945-0069

TX FIRM NUMBER: F-6932

SURVEYED BY: LANDTECH, INC.
FB NO. P-6331

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TEXAS REG. NO. 111437
OCTOBER 15, 2025

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## CITY OF HOUSTON


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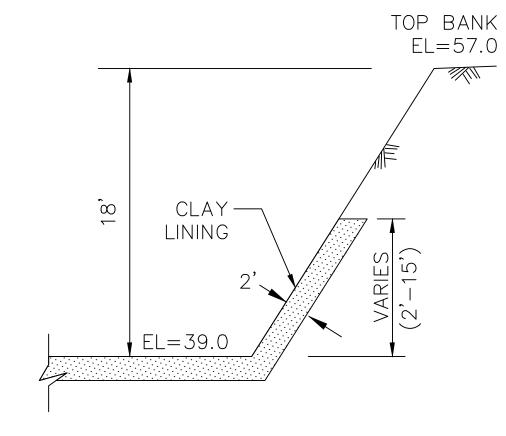
SHARPSTOWN AREA DETENTION POND A

GRADING CONTROL POINT AND CURVE TABLE

|    | WBS NUMBER                | FOR CITY OF HOUSTON USE ONL |
|----|---------------------------|-----------------------------|
|    | M-410040-001A-4           |                             |
|    | DRAWING SCALE             |                             |
|    | AS NOTED                  |                             |
|    | CITY OF HOUSTON PM        |                             |
|    | SUPUN ILANGAMUDALIGE P.E. |                             |
| 20 | SHEET NO. 16 OF 42        |                             |

HCFCD PROJECT ID #D100-00-00-Y020 SHEET NO. 16



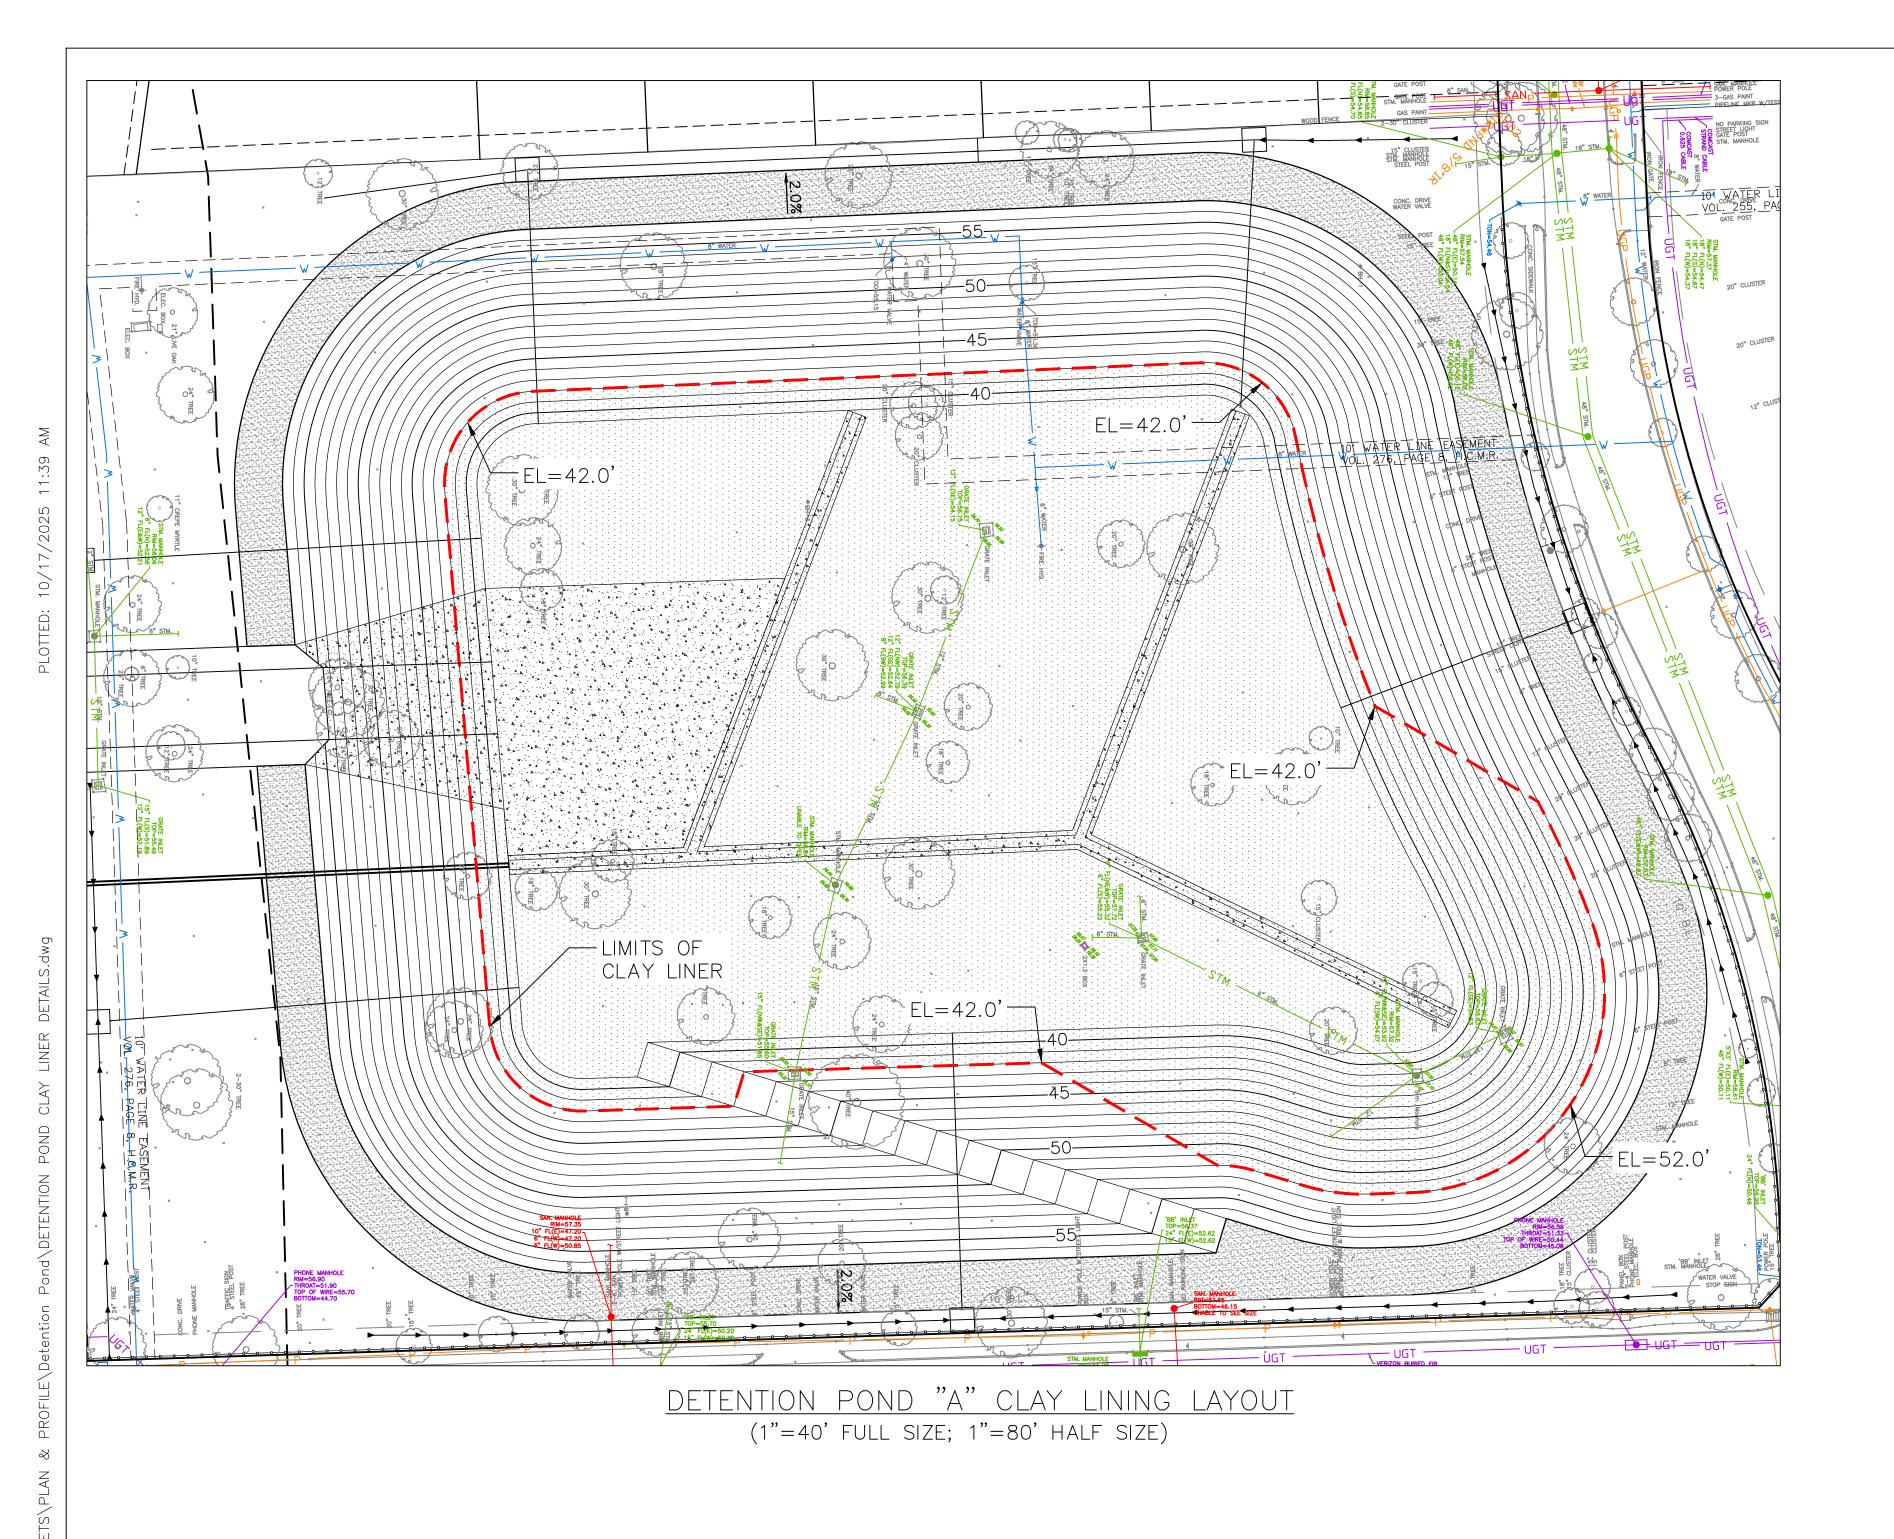


CLAY LINER TYPICAL SECTION

(NOT TO SCALE)

NOTES:

1. DELINEATED AREA SHOWS
WHERE 2' THICK CLAY LINER IS
REQUIRED. SEE GEOTECH
REPORT PREPARED BY AVILES
ENGINEERING FOR CLAY LINER
SPECIFICATIONS.

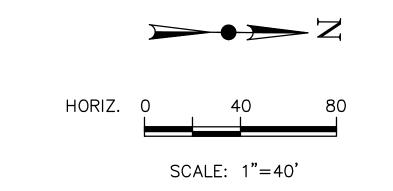

15021 KATY FREEWAY, STE. 500
HOUSTON, TX. 77094
281-945-0069
TX FIRM NUMBER: F-6932
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TEXAS REG. NO. 55474
October 17, 2025

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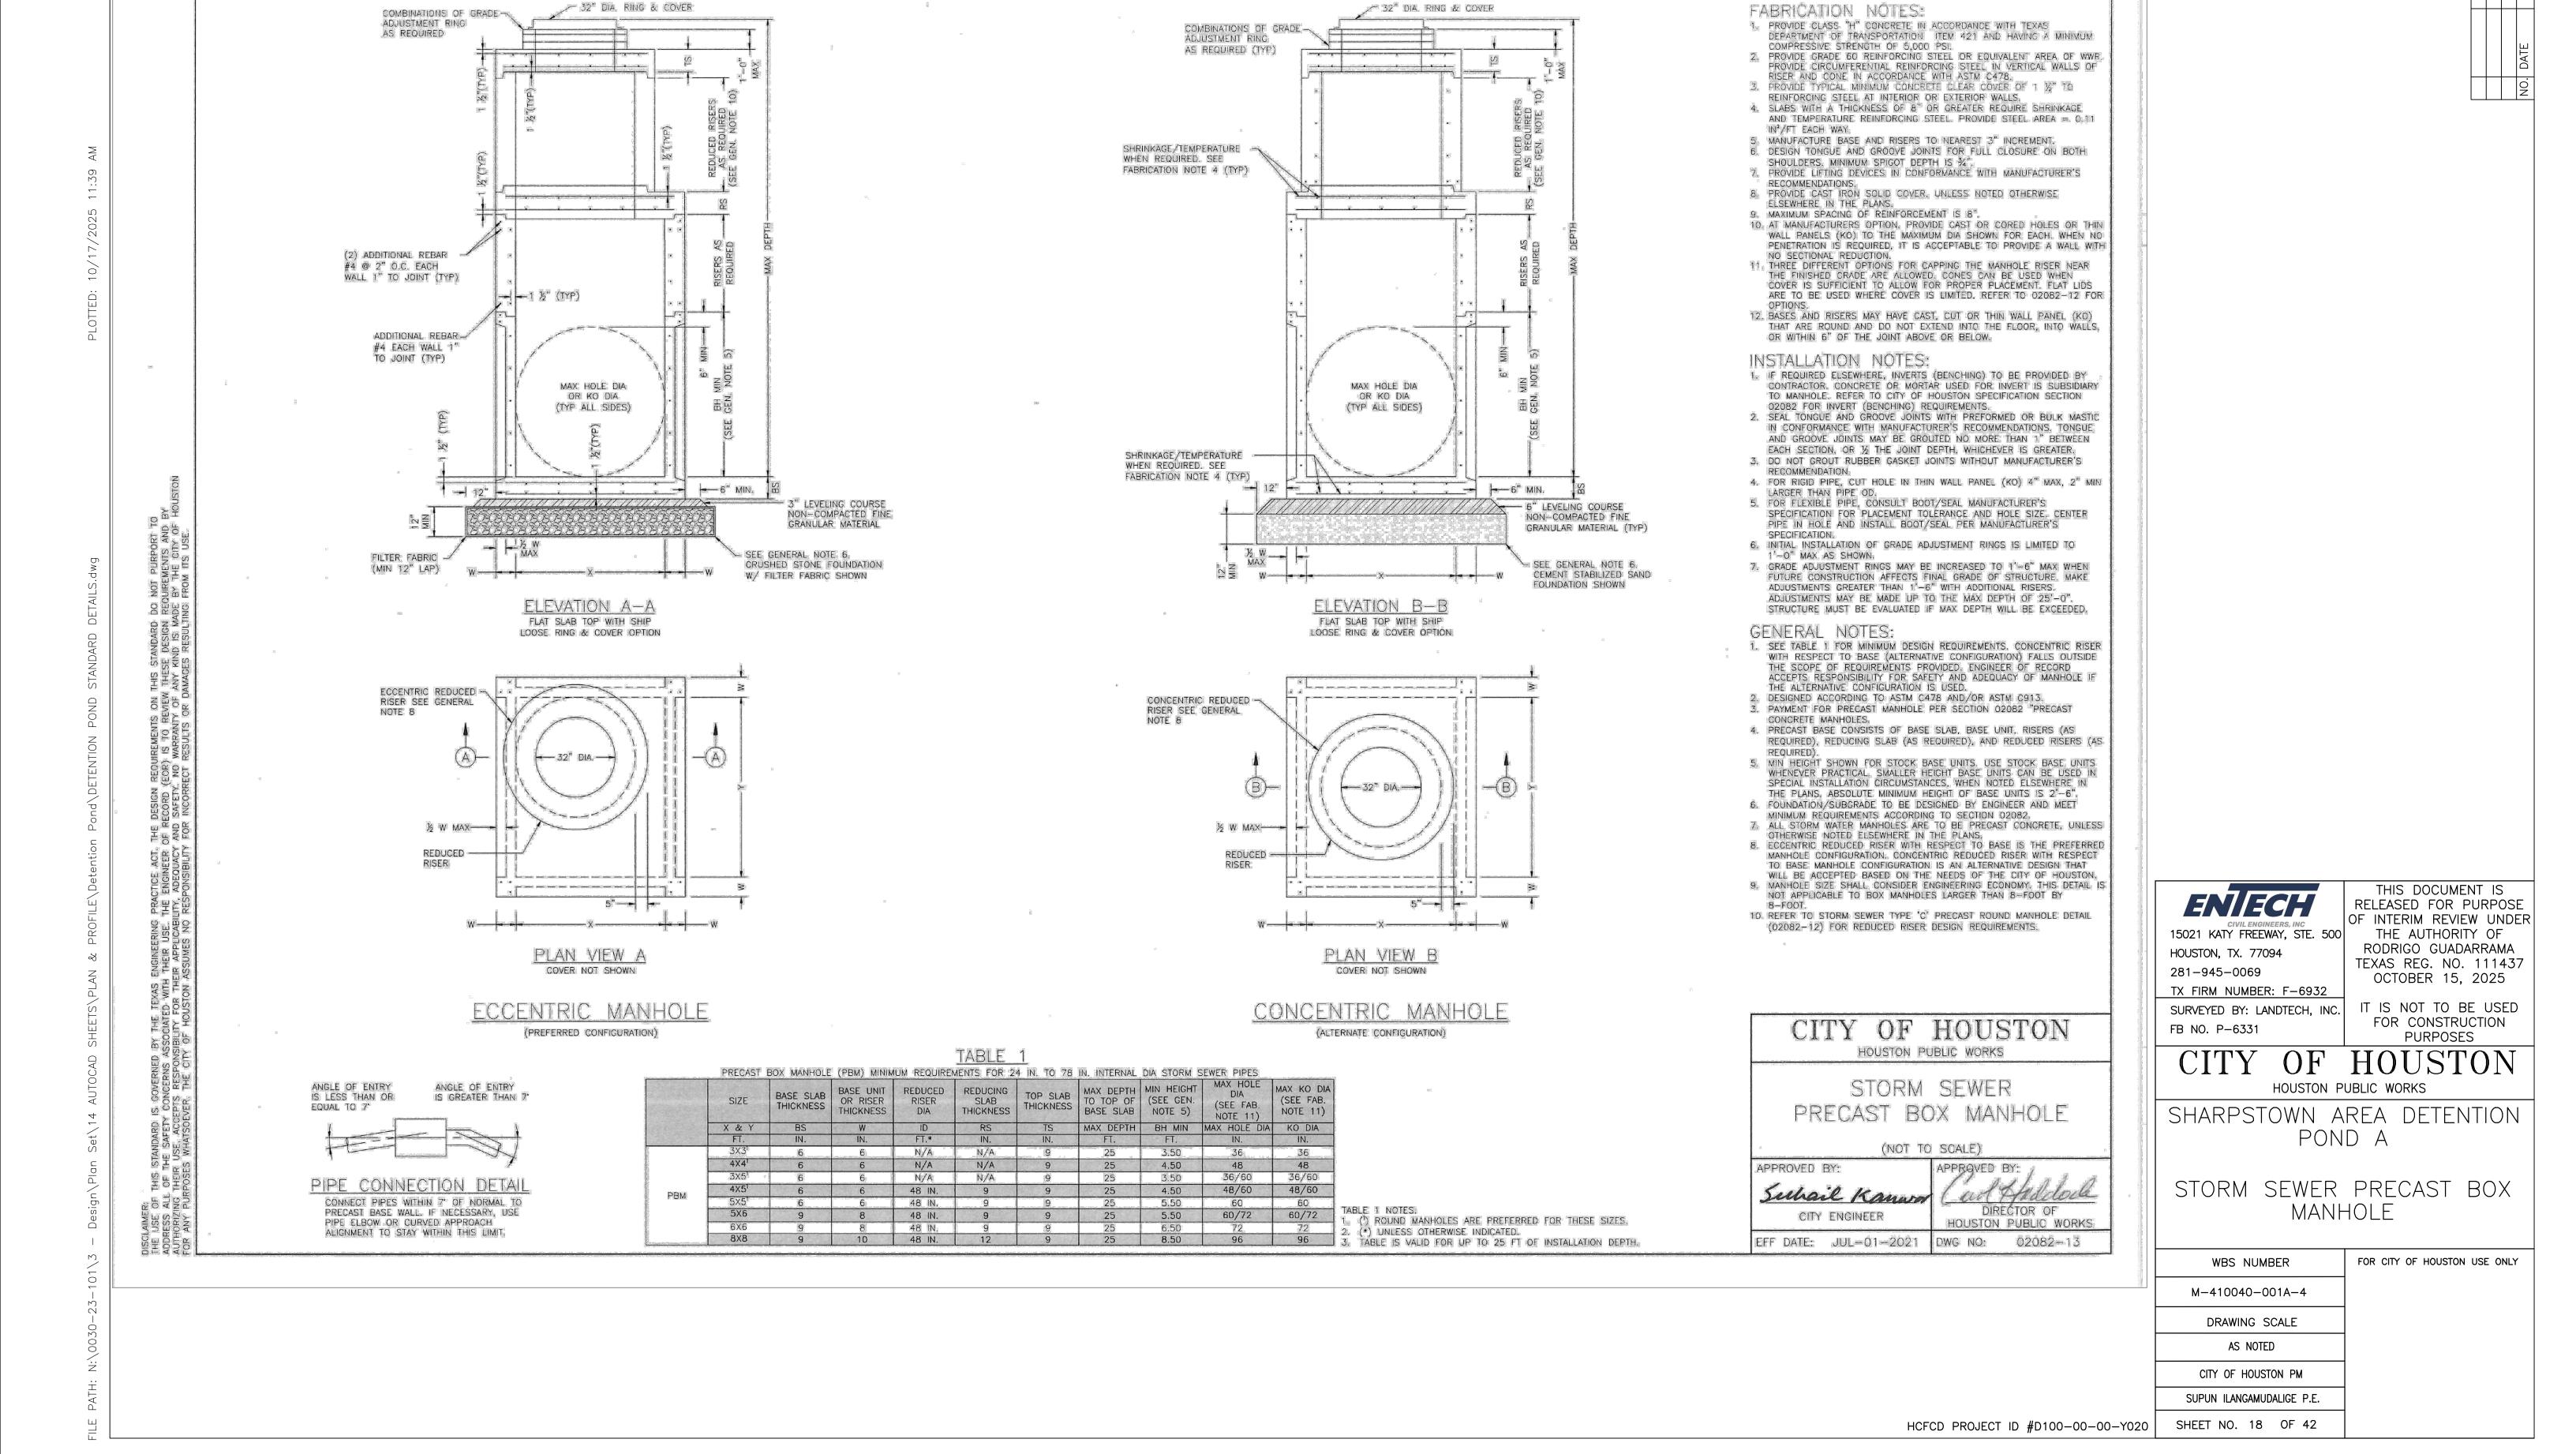
## CITY OF HOUSTON

HOUSTON PUBLIC WORKS

SHARPSTOWN AREA DETENTION POND A

CLAY LINING DETAILS

| WBS NUMBER           | FOR CITY OF HOUSTON USE ONLY |
|----------------------|------------------------------|
| M-410040-001A-3      |                              |
| DRAWING SCALE        |                              |
| AS NOTED             |                              |
| CITY OF HOUSTON PM   |                              |
| SUPUN ILANGAMUDALIGE |                              |
| SHEET NO. 17 OF 41   |                              |



15021 KATY FREEWAY, STE. 500 HOUSTON, TX. 77094 281-945-0069

TX FIRM NUMBER: F-6932 SURVEYED BY: LANDTECH, INC. FB NO. P-6331

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## OF HOUSTON HOUSTON PUBLIC WORKS

SHARPSTOWN AREA DETENTION POND A

> STORM SEWER DETAILS (1 OF 2)

WBS NUMBER FOR CITY OF HOUSTON USE ONLY M-410040-001A-4 DRAWING SCALE AS NOTED CITY OF HOUSTON PM SUPUN ILANGAMUDALIGE P.E. SHEET NO. 19 OF 42

FIRM INFORMATION

APPROVED BY:

SHEET NO.

DIRECTOR

EFFECTIVE DATE: JUL-01-2019

ENGINEER'S SEAL


HOUSTON PUBLIC WORKS

STORM SEWER

02317-03 THROUGH 07

FOR CITY OF HOUSTON USE ONLY

APPROVED BY:

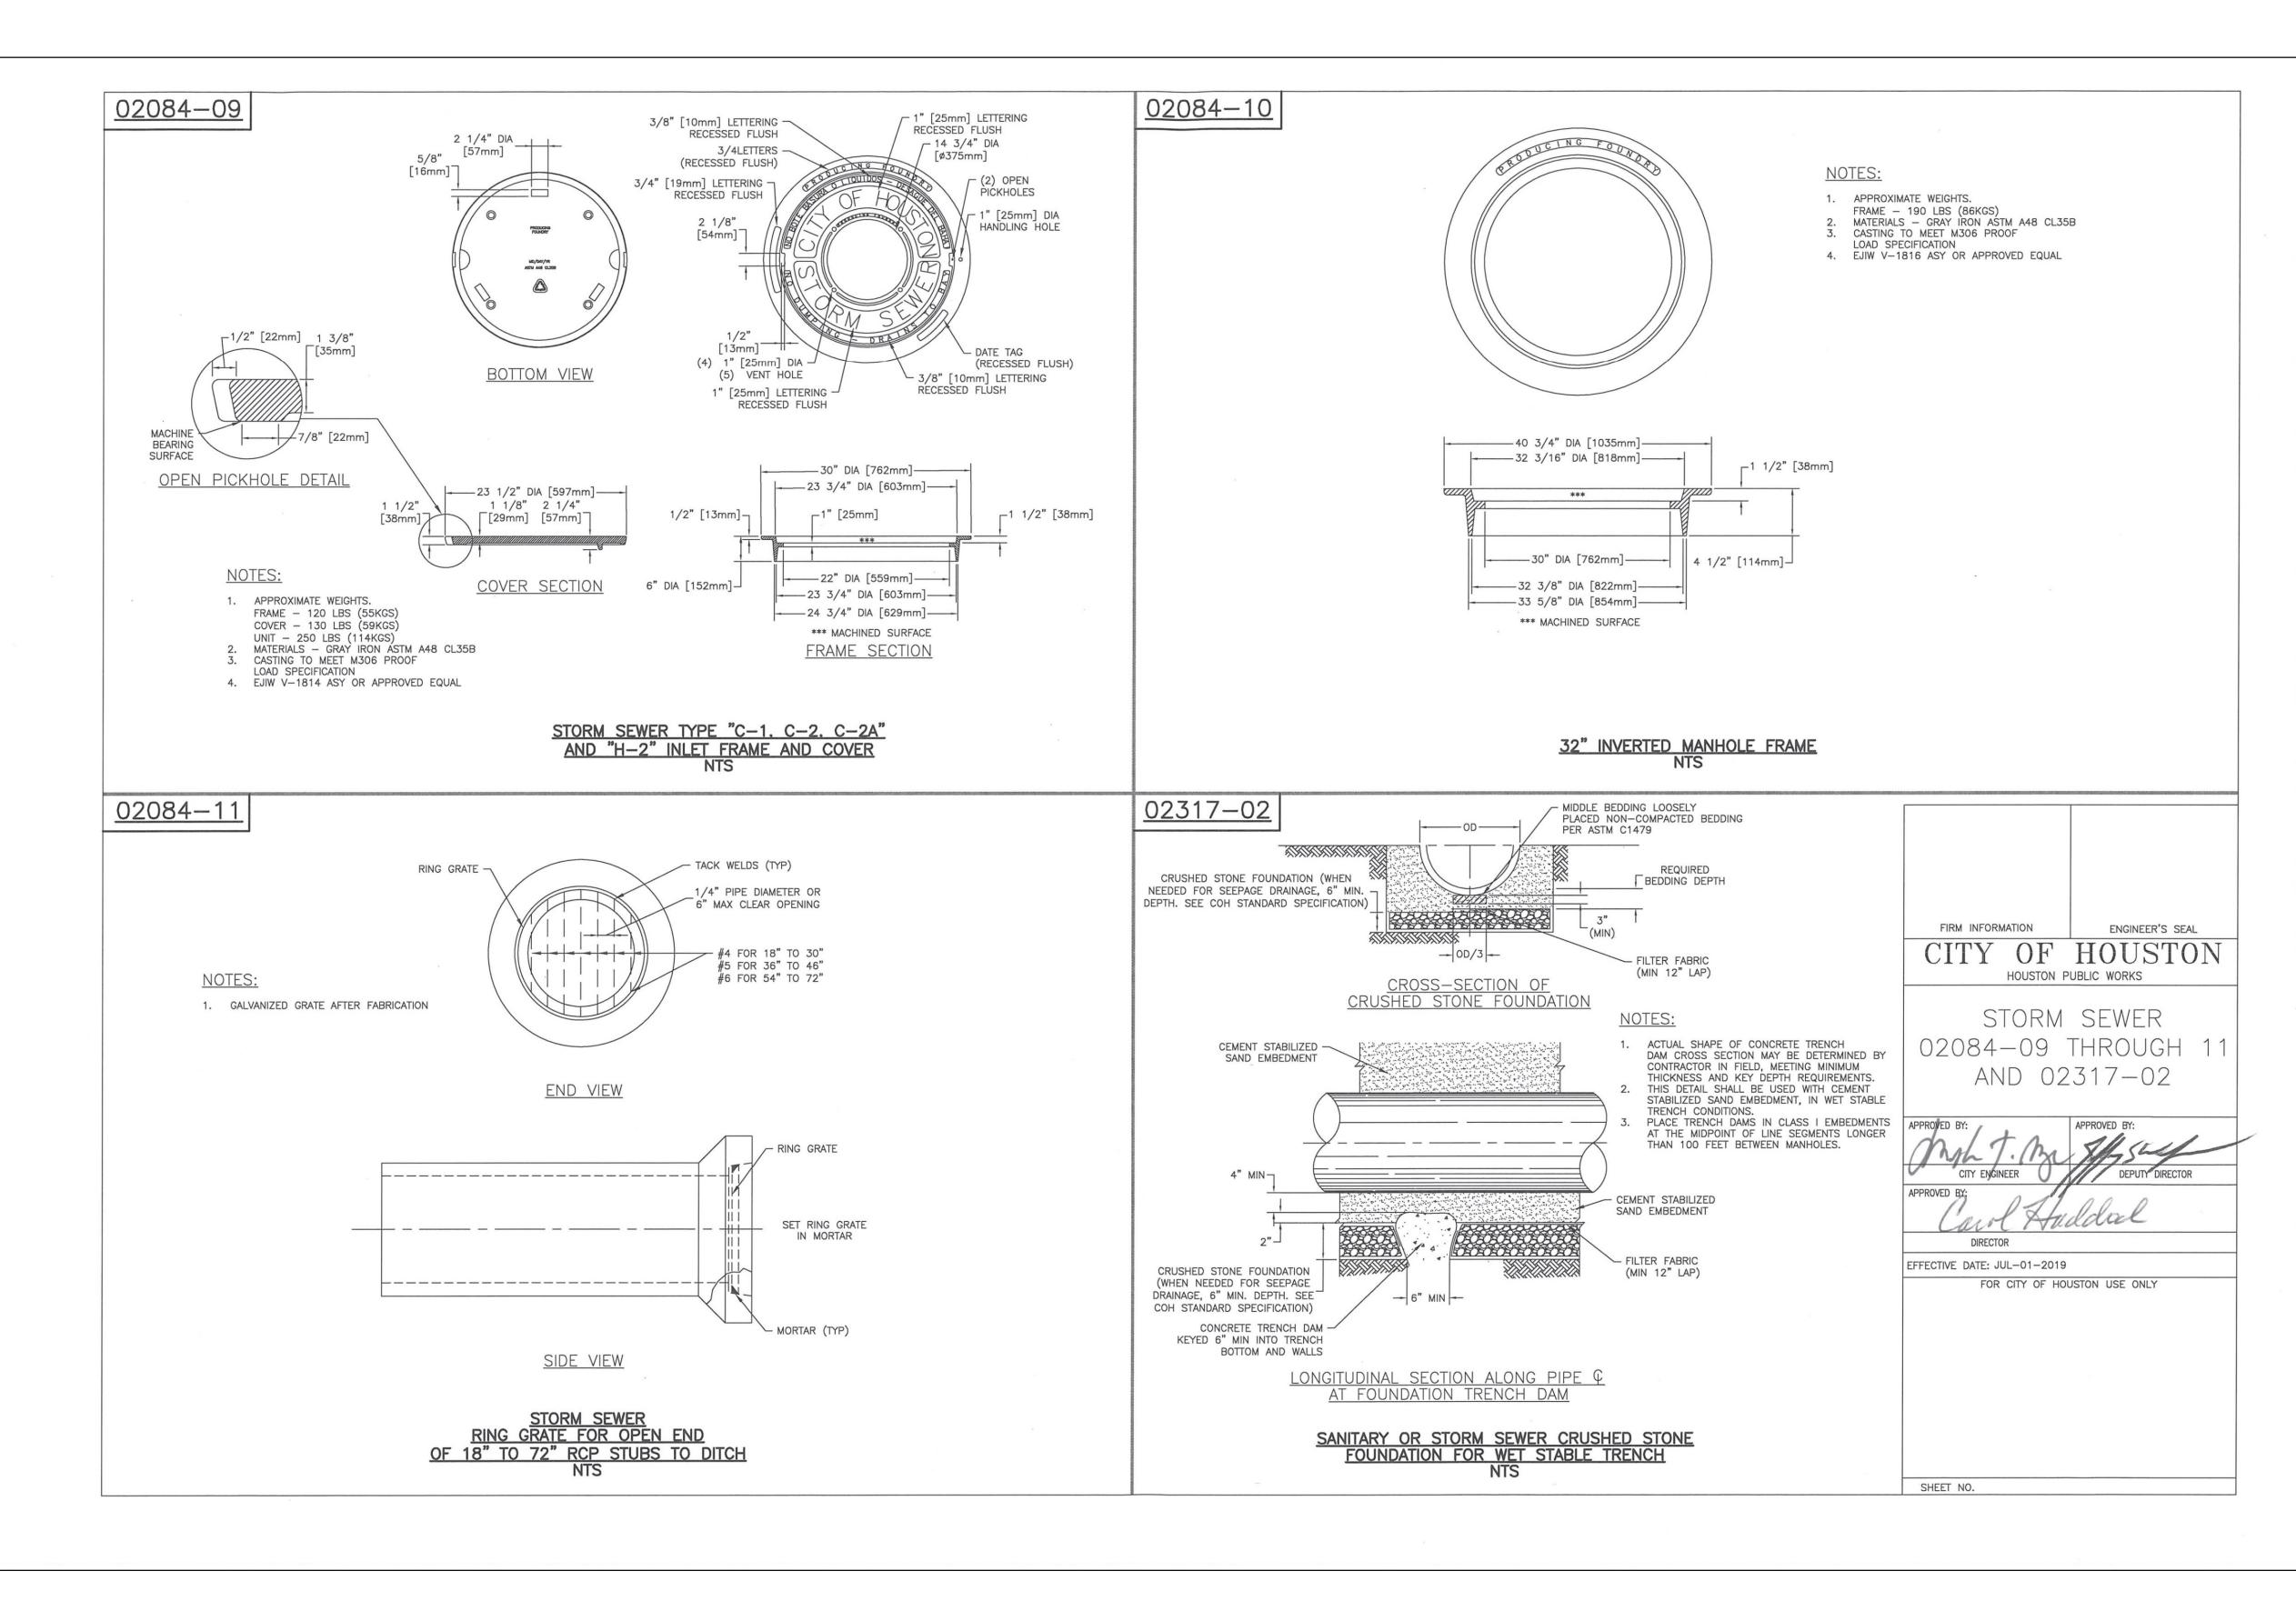

15021 KATY FREEWAY, STE. 500 HOUSTON, TX. 77094 281-945-0069

> TX FIRM NUMBER: F-6932 SURVEYED BY: LANDTECH, INC. FB NO. P-6331

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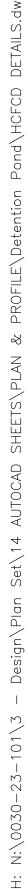
# CITY OF HOUSTON


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SHARPSTOWN AREA DETENTION POND A

> STORM SEWER DETAILS (2 OF 2)

|     | WBS NUMBER                | FOR CITY OF HOUSTON USE ONLY |
|-----|---------------------------|------------------------------|
|     | M-410040-001A-4           |                              |
|     | DRAWING SCALE             |                              |
|     | AS NOTED                  |                              |
|     | CITY OF HOUSTON PM        |                              |
|     | SUPUN ILANGAMUDALIGE P.E. |                              |
| 020 | SHEET NO. 20 OF 42        |                              |



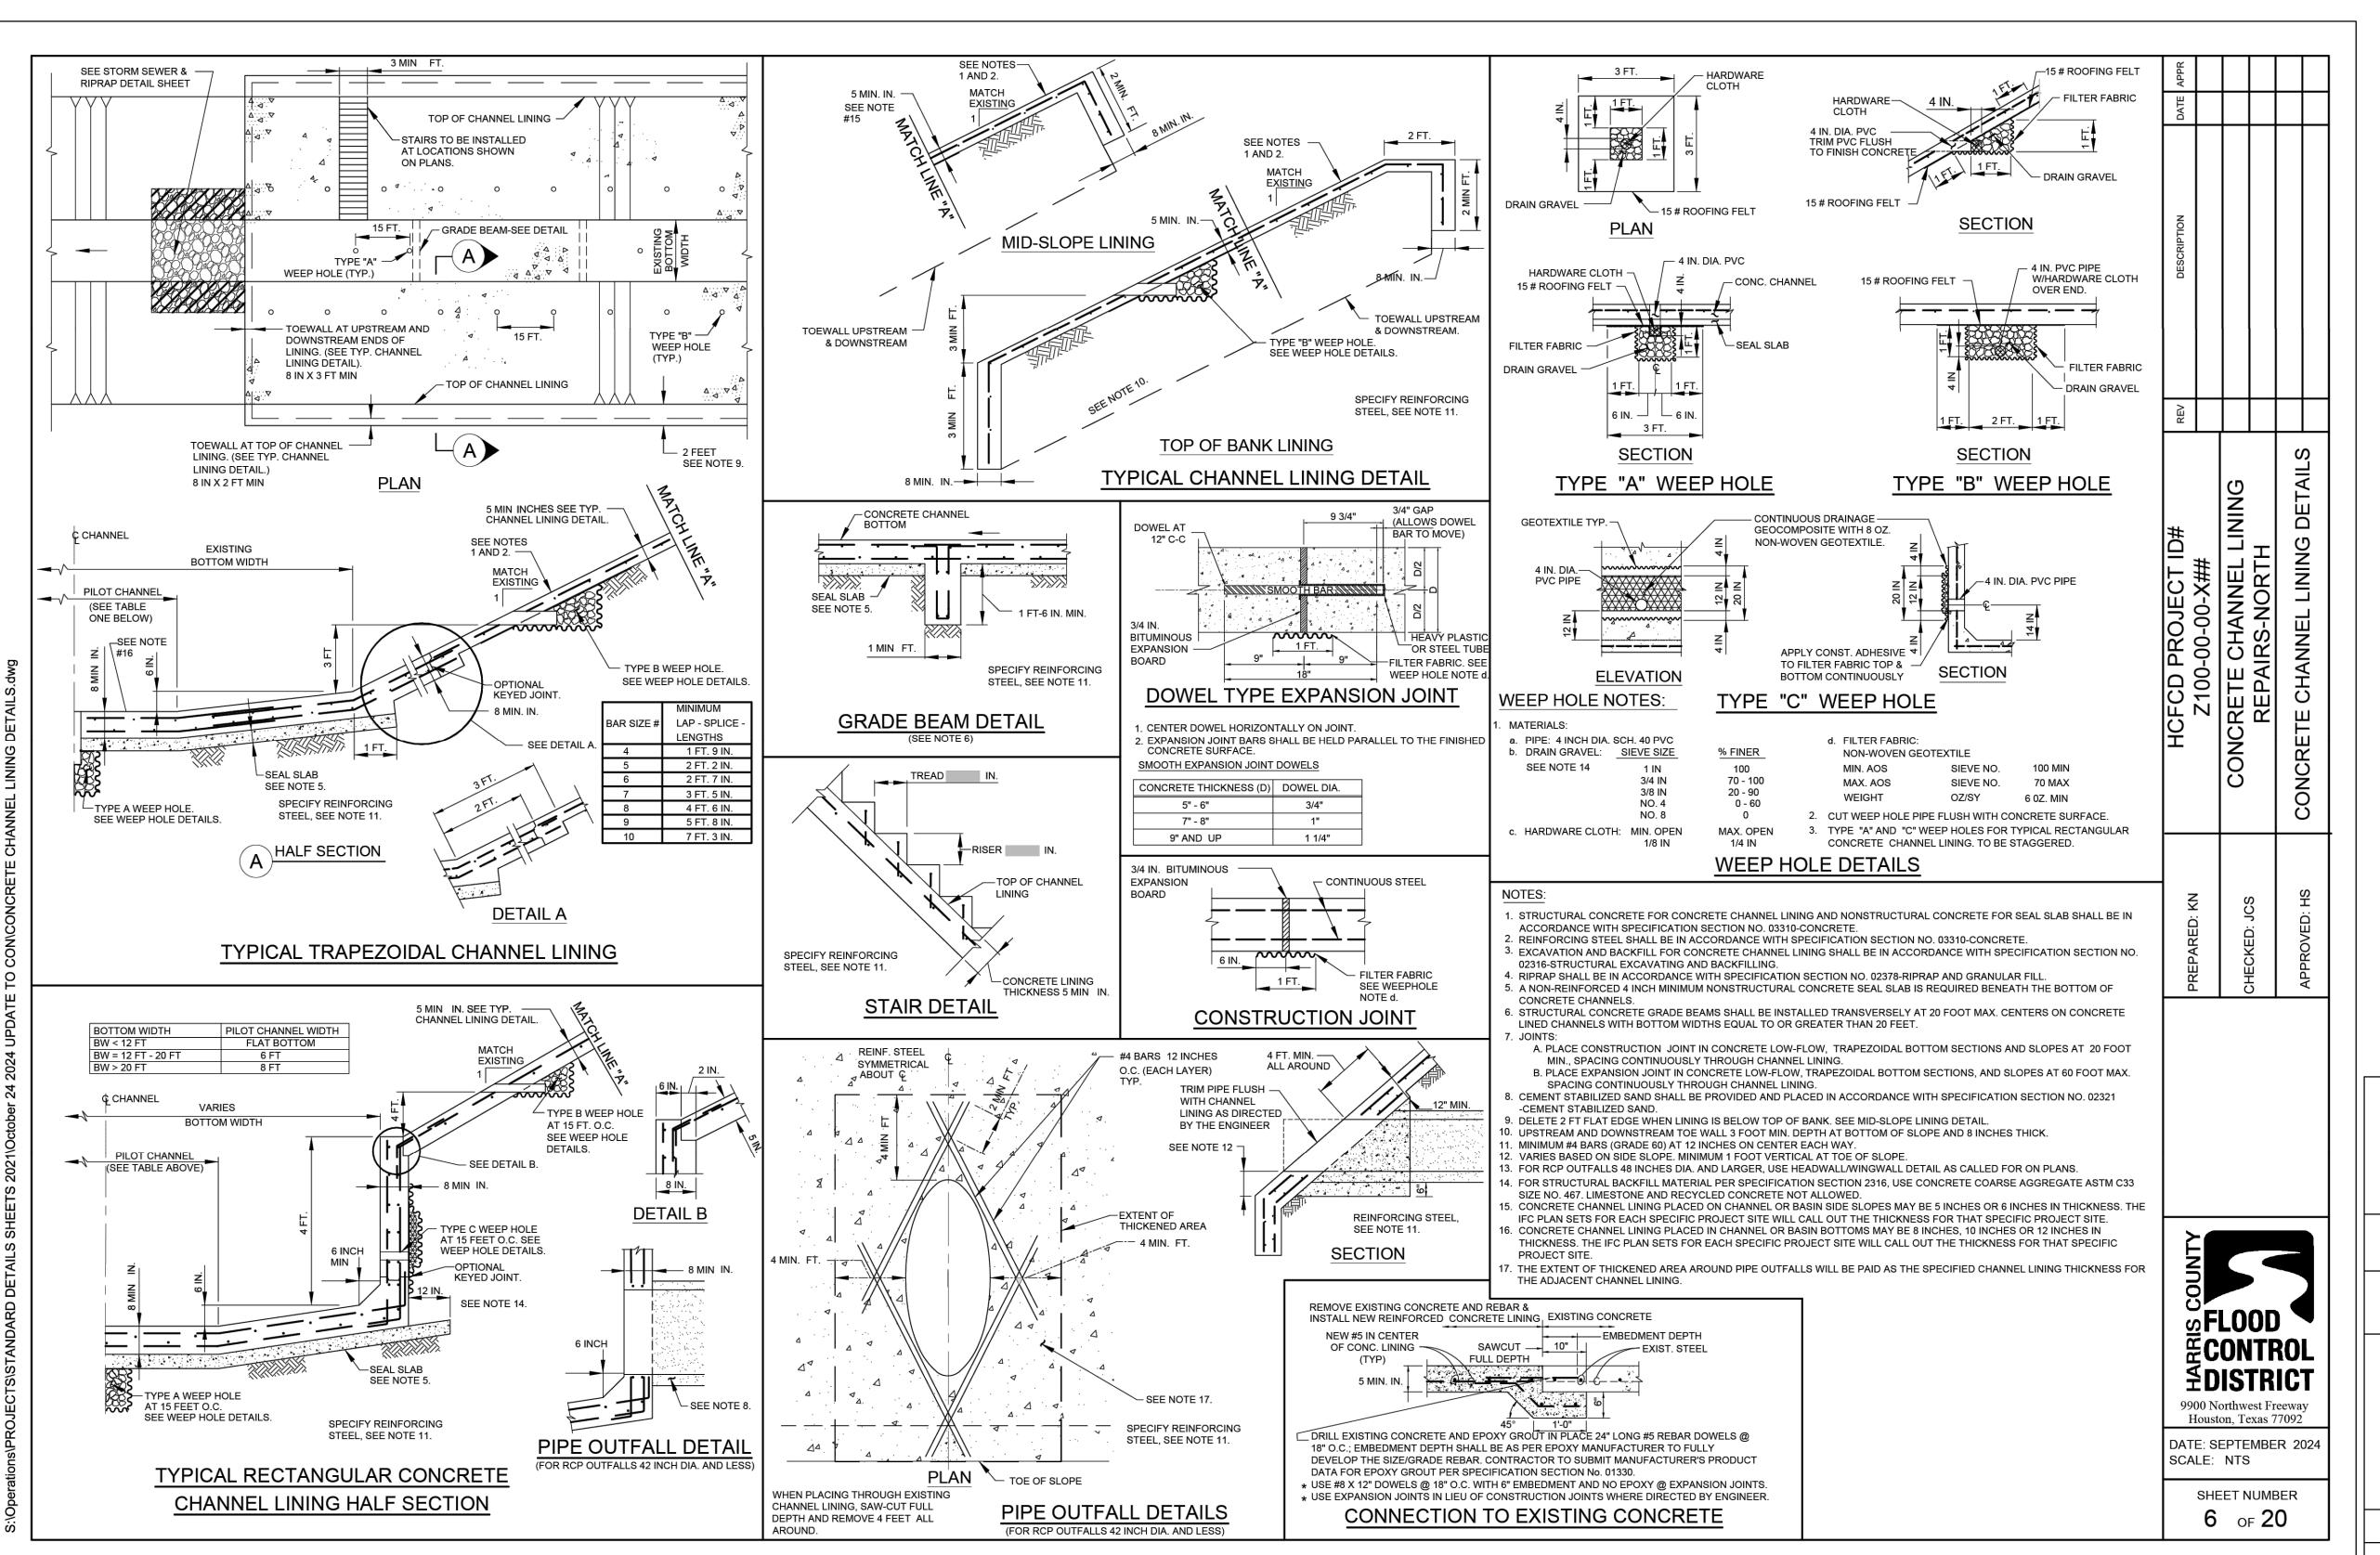

## CIVIL ENGINEERS, INC 15021 KATY FREEWAY, STE. 500 HOUSTON, TX. 77094 281-945-0069

TX FIRM NUMBER: F-6932

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OCTOBER 15, 2025

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# CITY OF HOUSTON HOUSTON PUBLIC WORKS


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SHARPSTOWN AREA DETENTION POND A

CONCRETE CHANNEL LINING DETAILS

| 1 1                 |                           |                              |
|---------------------|---------------------------|------------------------------|
| $\rfloor \parallel$ | WBS NUMBER                | FOR CITY OF HOUSTON USE ONLY |
|                     | M-410040-001A-4           |                              |
|                     | DRAWING SCALE             |                              |
|                     | NOT TO SCALE              |                              |
|                     | CITY OF HOUSTON PM        |                              |
|                     | SUPUN ILANGAMUDALIGE P.E. |                              |
| Y020                | SHEET NO. 21 OF 42        |                              |
|                     |                           |                              |



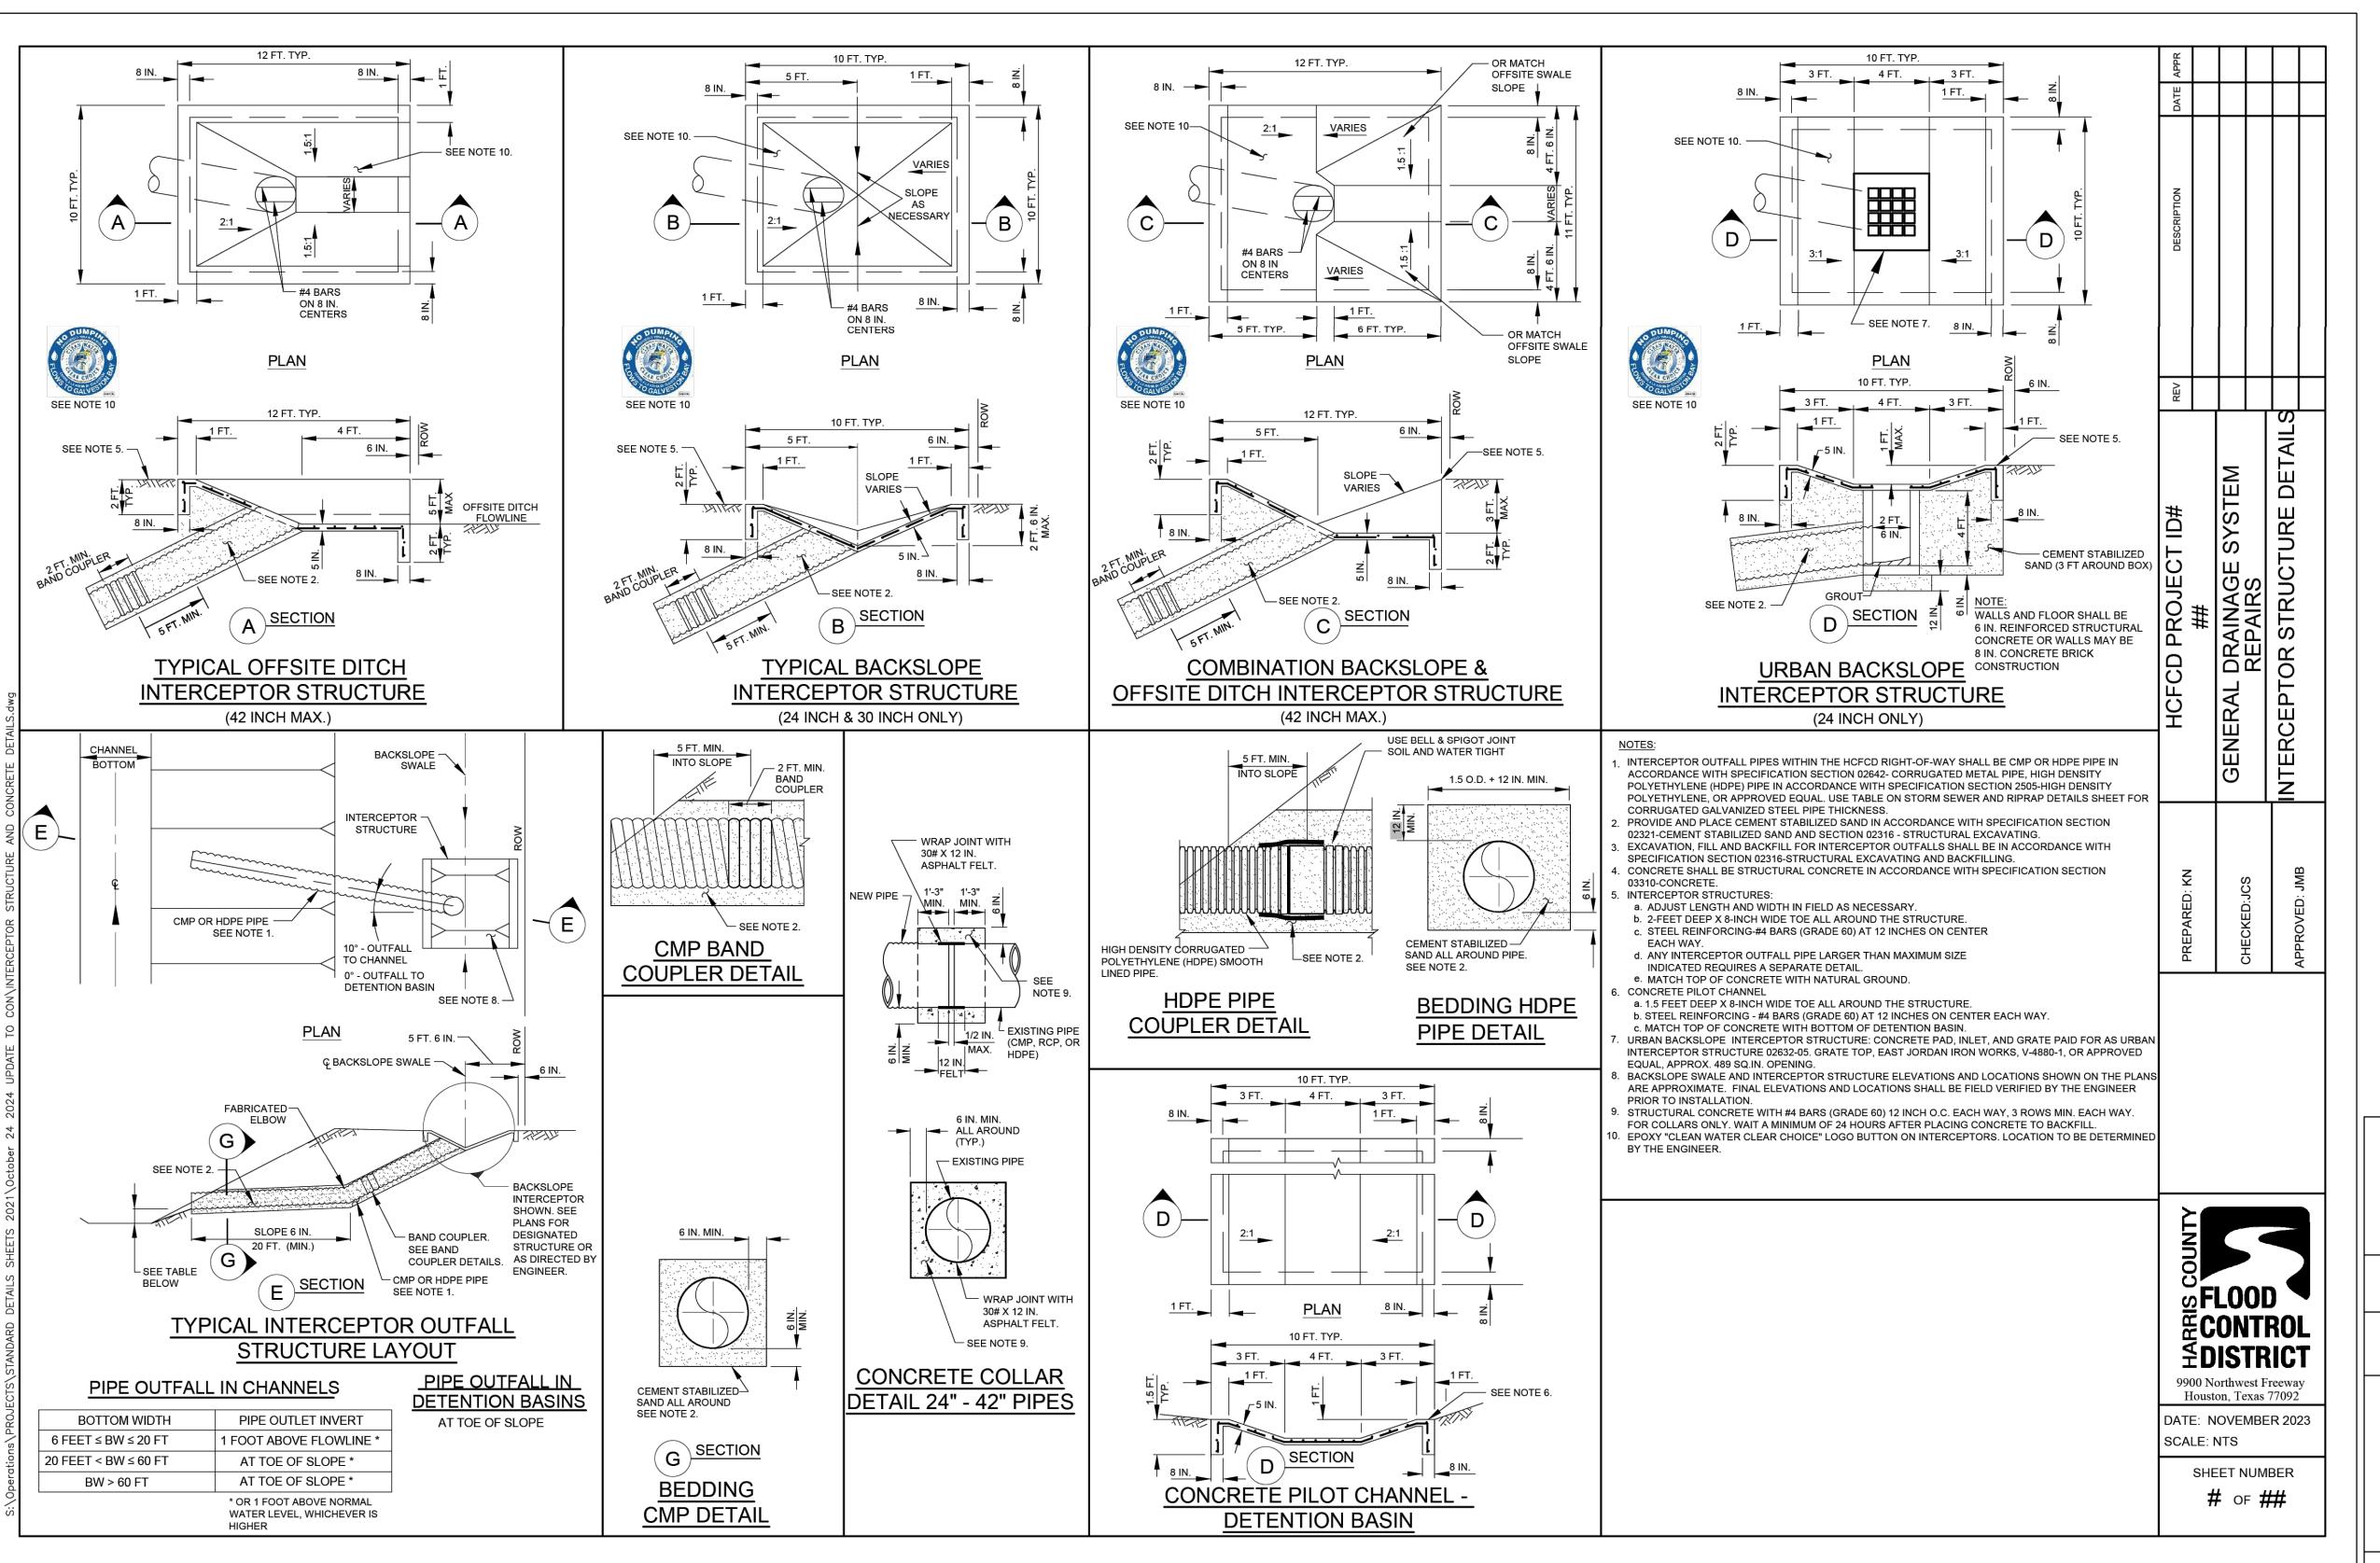

## CIVIL ENGINEERS, INC 15021 KATY FREEWAY, STE. 500 HOUSTON, TX. 77094 281-945-0069

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OCTOBER 15, 2025

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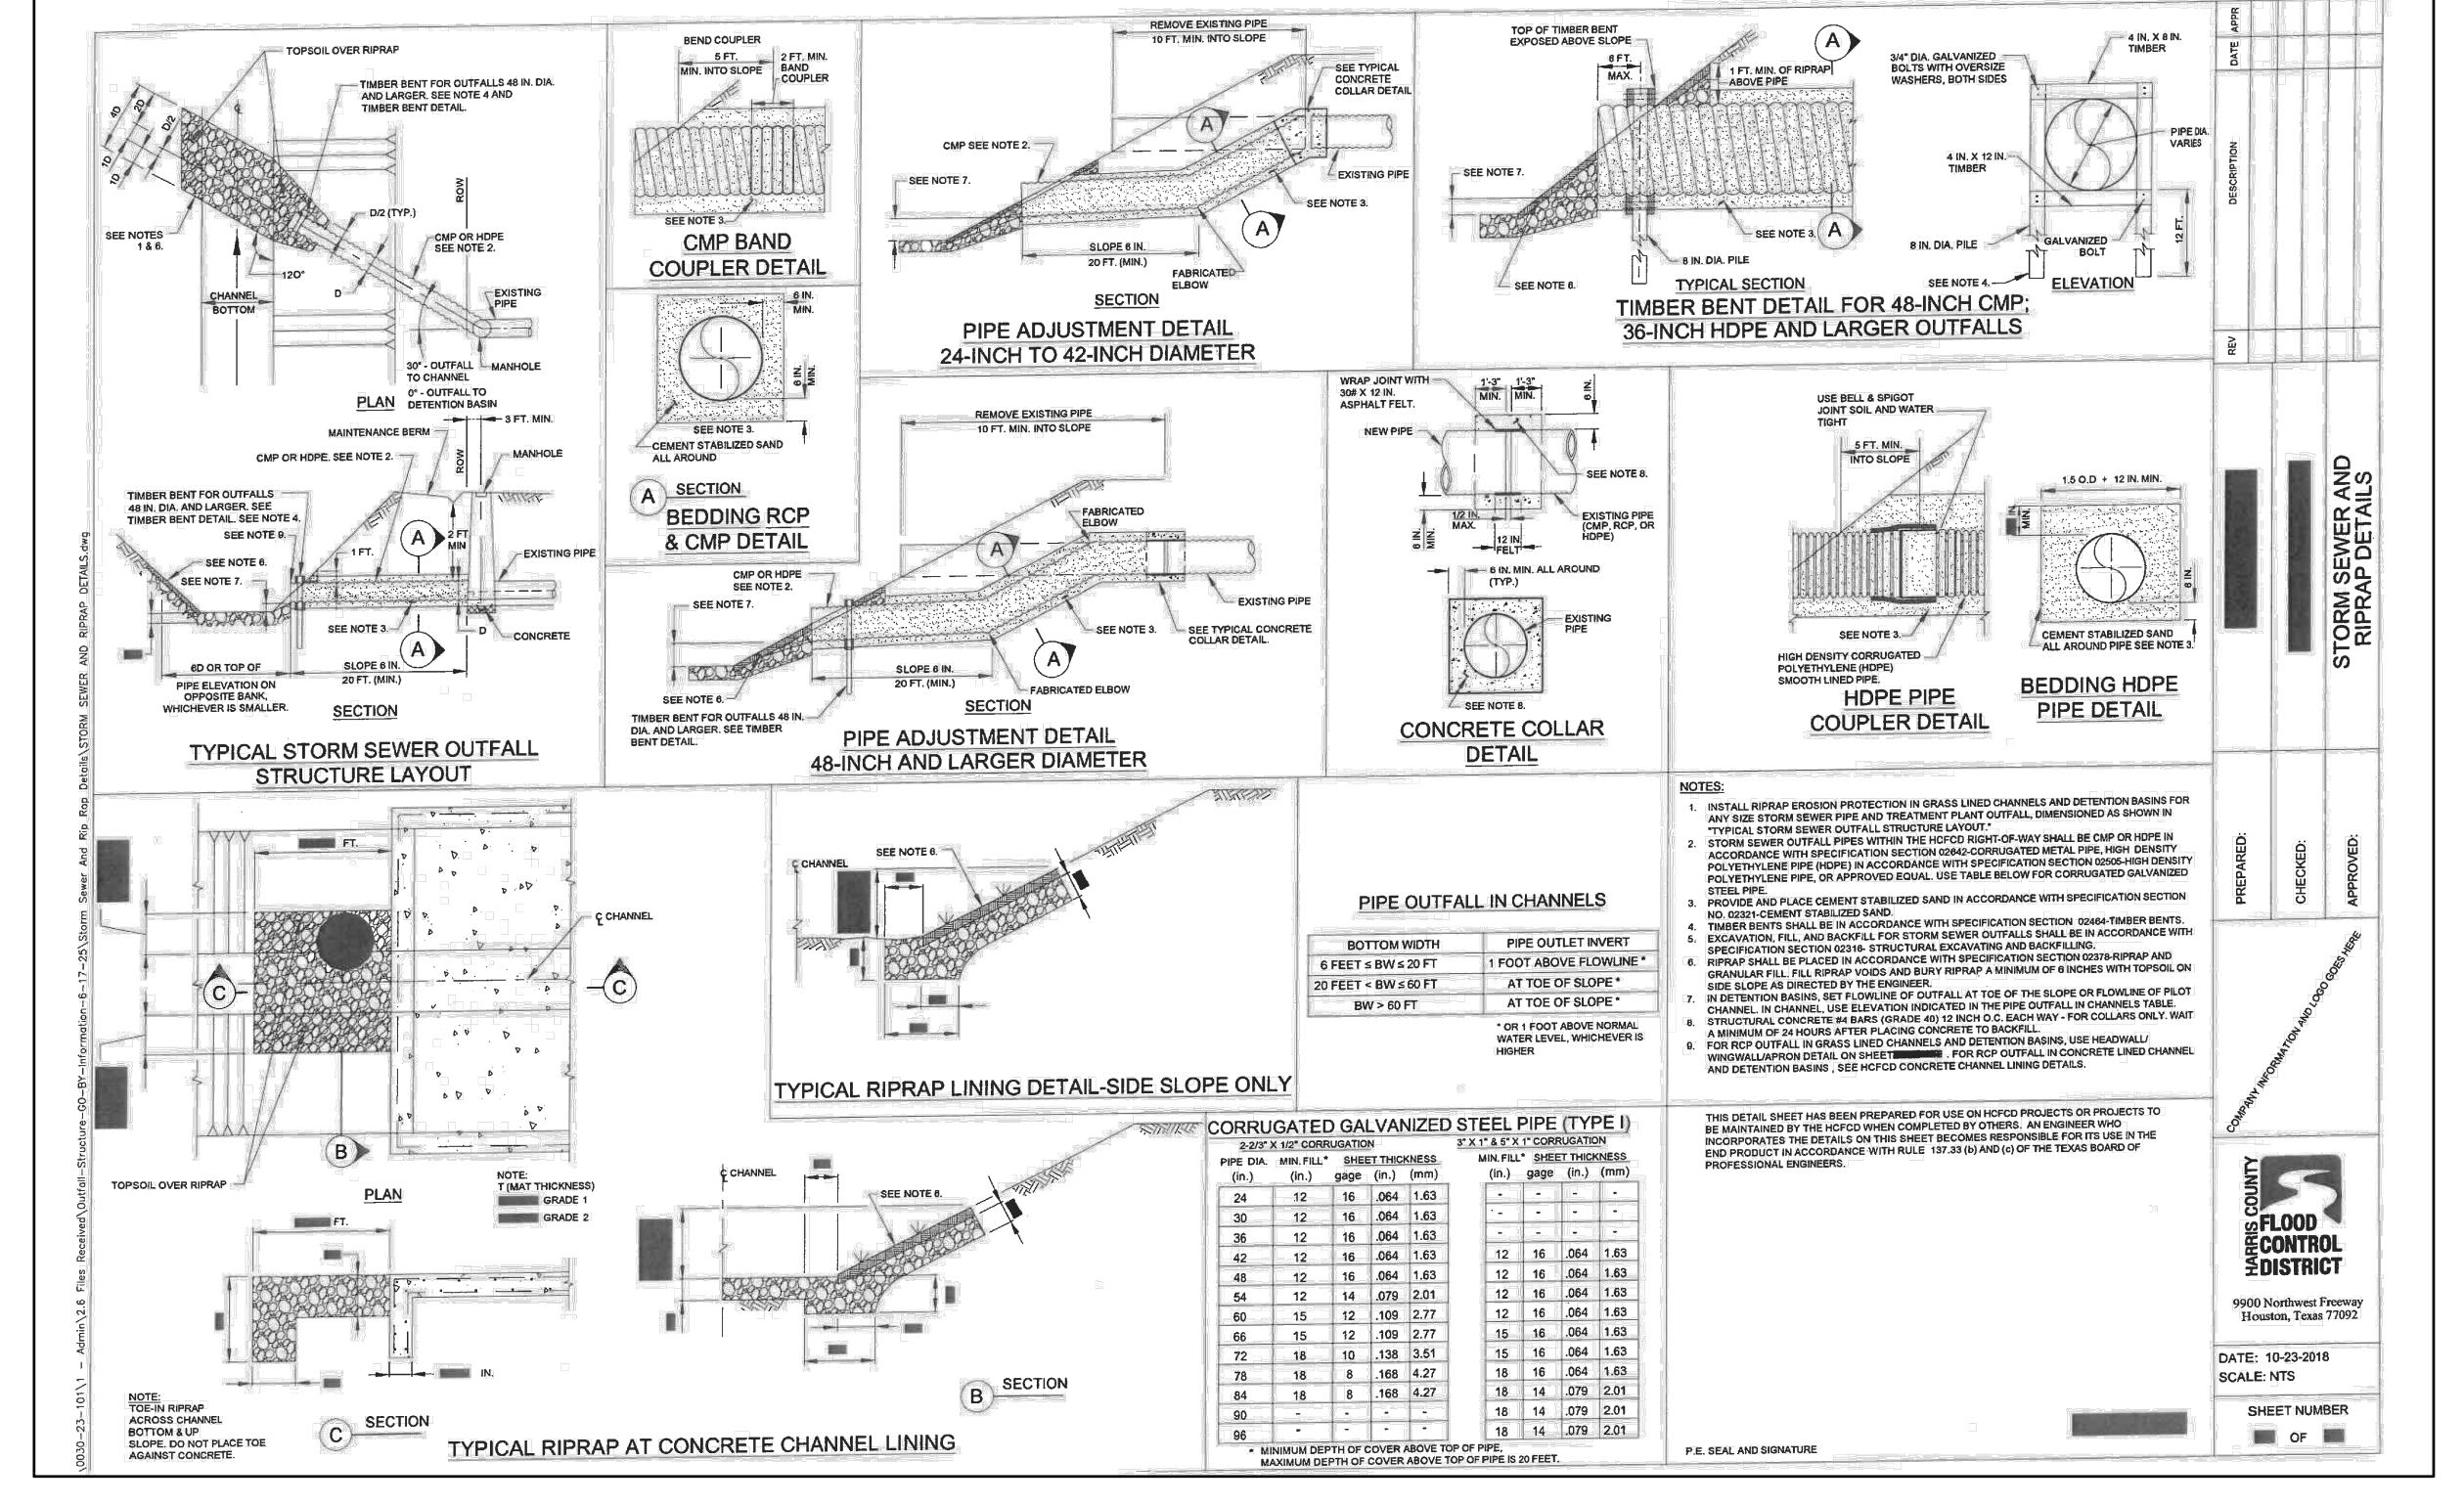
CITY OF HOUSTON PUBLIC WORKS

TIOUSTON TOBEIC WOR

SHARPSTOWN AREA DETENTION POND A

INTERCEPTOR STRUCTURE DETAILS

| - 1 |                           |                              |
|-----|---------------------------|------------------------------|
|     | WBS NUMBER                | FOR CITY OF HOUSTON USE ONLY |
|     | M-410040-001A-4           |                              |
|     | DRAWING SCALE             |                              |
|     | NOT TO SCALE              |                              |
|     | CITY OF HOUSTON PM        |                              |
|     | SUPUN ILANGAMUDALIGE P.E. |                              |
| 020 | SHEET NO. 22 OF 42        |                              |



ENECH CIVIL ENGINEERS, INC 15021 KATY FREEWAY, STE. 500 HOUSTON, TX. 77094 281-945-0069

TX FIRM NUMBER: F-6932

SURVEYED BY: LANDTECH, INC.

FB NO. P-6331

THIS DOCUMENT IS
RELEASED FOR PURPOSE
OF INTERIM REVIEW UNDER
THE AUTHORITY OF
RODRIGO GUADARRAMA
TEXAS REG. NO. 111437
OCTOBER 15, 2025

IT IS NOT TO BE USED FOR CONSTRUCTION PURPOSES


## CITY OF HOUSTON

HOUSTON PUBLIC WORKS

SHARPSTOWN AREA DETENTION POND A


STORM SEWER & RIPRAP DETAILS


|     | WBS NUMBER                | FOR CITY OF HOUSTON USE ONLY |
|-----|---------------------------|------------------------------|
|     | M-410040-001A-4           |                              |
|     | DRAWING SCALE             |                              |
|     | NOT TO SCALE              |                              |
|     | CITY OF HOUSTON PM        |                              |
|     | SUPUN ILANGAMUDALIGE P.E. |                              |
| 020 | SHEET NO. 23 OF 42        |                              |

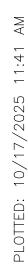







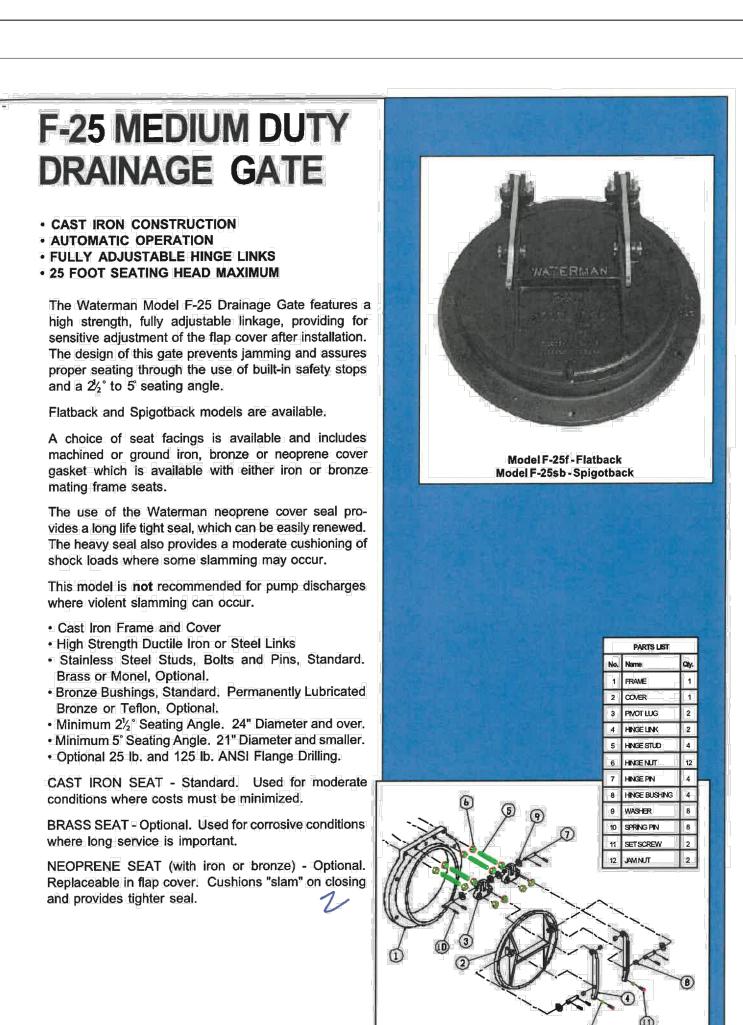

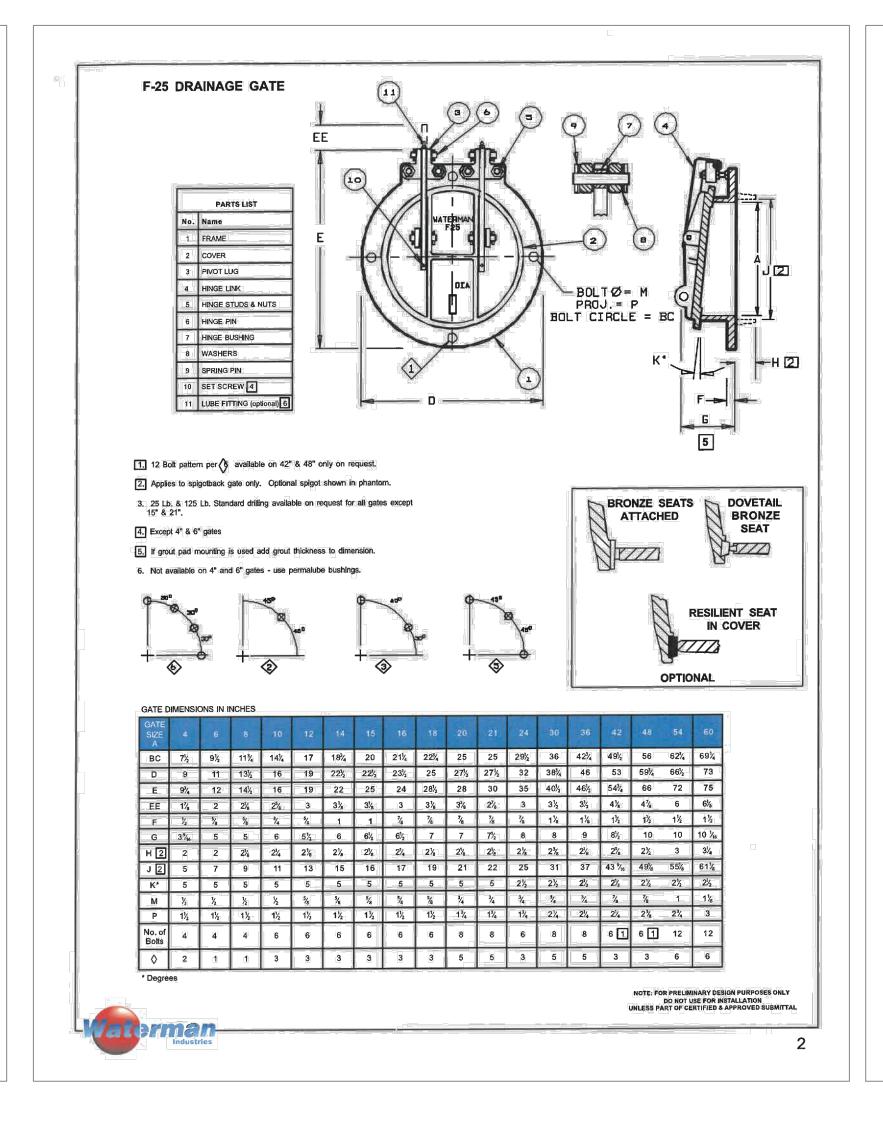

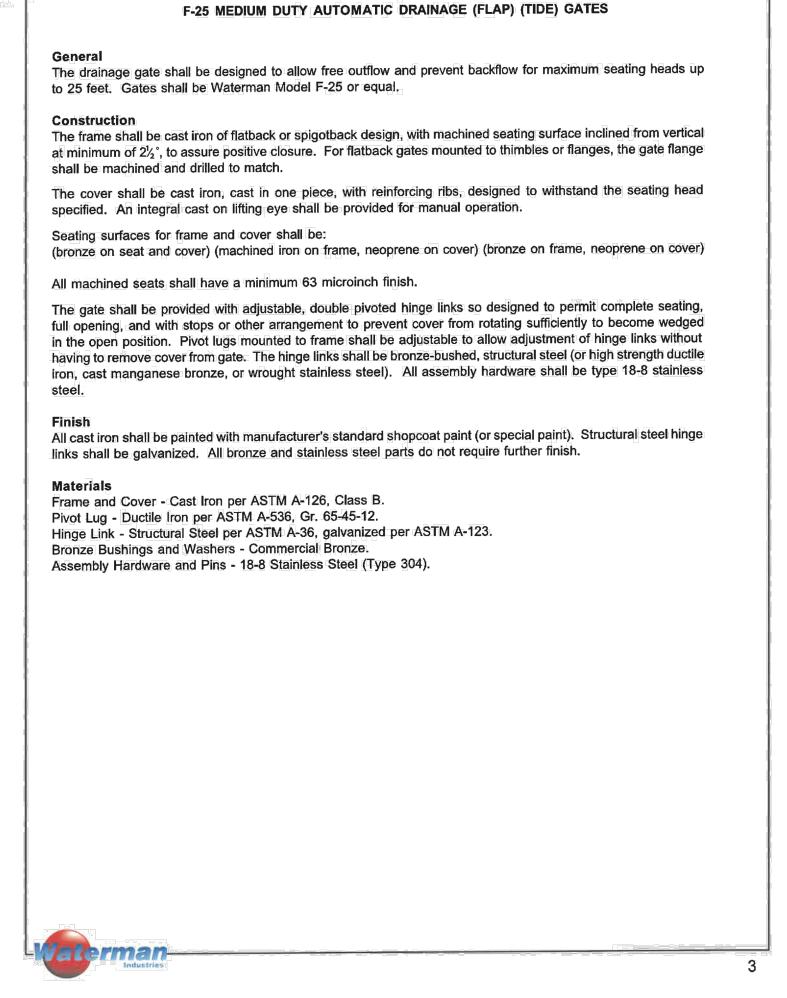

TYPICAL SPECIFICATIONS

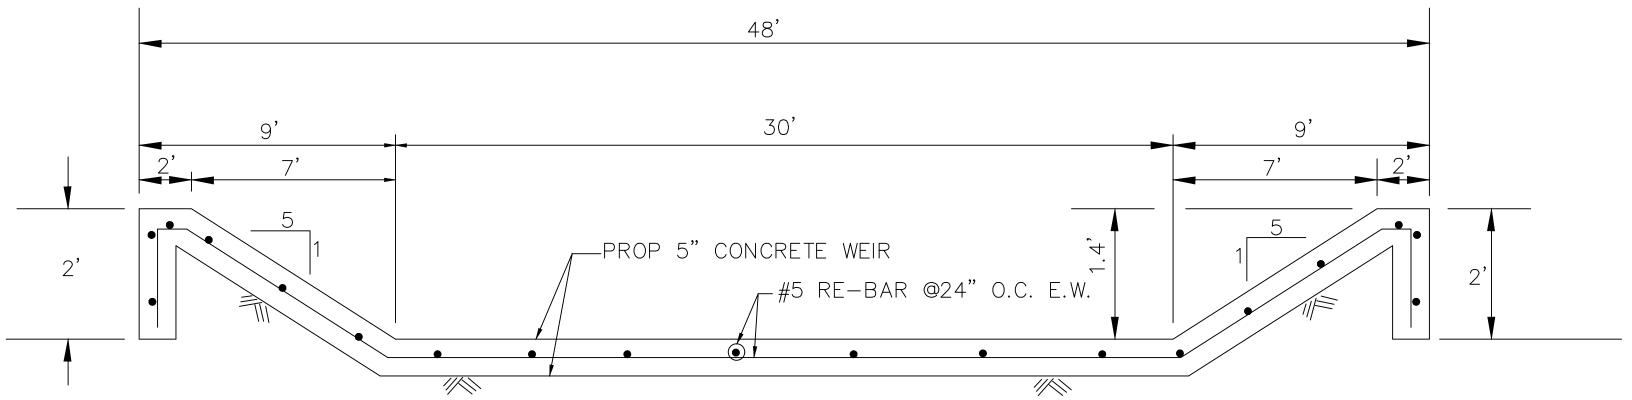

SECTION B-B (NOT TO SCALE)

HOUSTON, TX. 77094 281-945-0069

TX FIRM NUMBER: F-6932 SURVEYED BY: LANDTECH, INC. FB NO. P-6331

TEXAS REG. NO. 111437 OCTOBER 15, 2025 IT IS NOT TO BE USED FOR CONSTRUCTION PURPOSES

RODRIGO GUADARRAMA


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HOUSTON HOUSTON PUBLIC WORKS

SHARPSTOWN AREA DETENTION POND A

MISCELLANEOUS DETAILS

|    | WBS NUMBER                | FOR CITY OF HOUSTON USE ONL |
|----|---------------------------|-----------------------------|
|    | M-410040-001A-4           |                             |
|    | DRAWING SCALE             |                             |
|    | AS NOTED                  |                             |
|    | CITY OF HOUSTON PM        |                             |
|    | SUPUN ILANGAMUDALIGE P.E. |                             |
| 20 | SHEET NO. 24 OF 42        |                             |

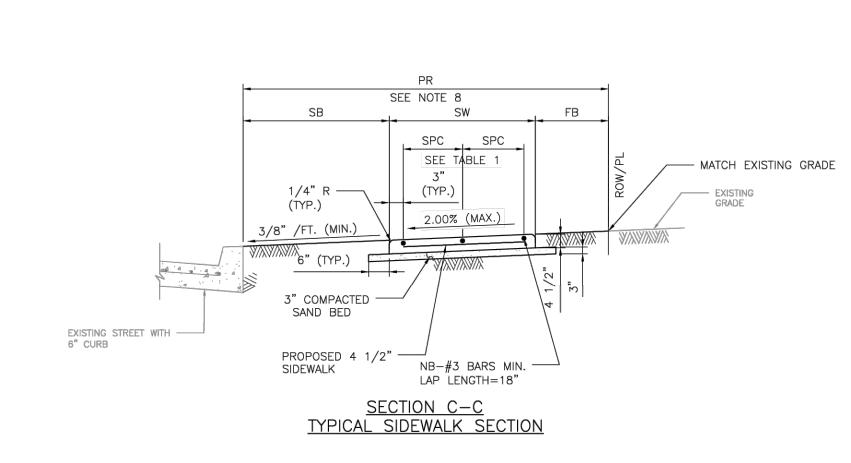

34" BOARD EXPANSION JOINT OR

SIDEWALK (TYP)

½" SAW CUT PREFORMED JOINT

- PROPOSED CONCRETE

— EXISTING

CURB (TYP.)

- DETECTABLE WARNING SURFACE IF

- PROPOSED CONCRETE

SIDEWALK (TYP)

REQUIRED. SEE NOTE 9 (TYP)

SIDEWALK (TYP)

SAW CUT AND EXPOSE 15"

(MIN. SAW CUT DEPTH=2")

1:12 (MAX)

- 6" STABILIZED SUBGRADE

--- SCORE

ALL OTHERS #4 BAR @24" C-C EACH WAY

MIN. LAP LENGTH=22"

SINGLE FAMILY

SINGLE FAMILY

BOARD EXPANSION #3 BAR @18" C-C EACH WAY

JOINT OR 1/2"SAW CUT MIN. LAP LENGTH=16" PREFORMED JOINT

OF REINFORCING STEEL

DRIVEWAY WIDTH

SEE TABLE 2

IEND CURB AT ---

GUTTERLINE ——

6" STABILIZED -

SUBGRADE

の SIDEWALK (TYP)

/--- SCORE

PROPOSED

DRIVEWAY

PLAN VIEW

<u>DRIVEWAY</u>

DRIVEWAY WIDTH

SEE TABLE 2

PROPOSED -

DRIVEWAY

PROPOSED SIDEWALK THROUGH DRIVEWAY WITH EXCESSIVE ELEVATION DIFFERENCE WITH EXISTING SIDEWALK

SEE NOTE 8

SECTION B-B

TYPICAL DRIVEWAY SECTION

2% (MAX)

12 MAX

TABLE 1

REINFORCING STEEL INFORMATION FOR 4 ½ " THICK SIDEWALKS EXPANSION JOINT SPACING = 40 FT fc' = 3,500 PSI AND fy = 60,000 PSI

TYPE A DRIVEWAY

(FOR SINGLE FAMILY RESIDENTIAL HOUSES OR

MAX

THE MINIMUM WIDTH FOR JOINT ACCESS DRIVEWAY IS 12 FT.

RADIUS (FT)

4) REFER TO CHAPTER 42 OF THE CODE OF ORDINANCES FOR DRIVEWAY WIDTHS FOR NARROW LOTS.

5) ONLY MURS AND COURTYARD STYLE DEVELOPMENTS ON CORNER LOTS CAN HAVE ONE—WAY DRIVEWAYS.

MAX

MIN

WIDTH (FT)

10<sup>(3)</sup>

TRAFFIC TYPE

ONE-WAY

TWO-WAY

34" BOARD EXPANSION

JOINT OR ½" SAW CUT PREFORMED JOINT

REFER TO CONTRACT DRAWINGS FOR SIDEWALKS WIDER THAN 6 FEET.

|                |               | L                      | ONGITUDINAL S            | STEEL                   |                         |
|----------------|---------------|------------------------|--------------------------|-------------------------|-------------------------|
| SIDEWALK       | SIDEWALK      | #3 BARS                |                          |                         | TRANSVERSE STEEL        |
| THICKNESS (IN) | WIDTH<br>(FT) | NO. OF<br>BARS<br>"NB" | SPACING<br>"SPC"<br>(IN) | END BAR<br>SPACING (IN) | #3 BARS SPACING<br>(IN) |
| 4.5            | 5             | 3                      | 27                       | 3                       | 48                      |
| 4.5            | 6             | 4                      | 22                       | 3                       | 48                      |

TABLE 2

DRIVEWAY DESIGN CRITERIA (1)(2)

MAX

MIN

I) REFER TO INFRASTRUCTURE DESIGN MANUAL ARTICLE 15.2.07.C.1.F FOR DRIVEWAYS THAT REQUIRE A VEHICLE SWEPT PATH ANALYSIS.

(2) REFER TO INFRASTRUCTURE DESIGN MANUAL ARTCILES 15.2.07.C.1.G.(1) AND 15.2.07.C.1.G.(2) FOR TYPE 1 PAE AND TYPE 2 PAE REQUIREMENTS.

(6) REFER TO CHAPTER 42, SECTION 42-146 OF THE CODE OF ORDINANCES FOR EXCEPTIONS TO THE MINIMUM DRIVEWAY WIDTH FOR SHARED DRIVEWAYS.

TYPE B DRIVEWAY

(SHARED ACCESS/SHARED DRIVEWAY)

RADIUS (FT)

MIN

MAX

10<sup>(5)</sup>

TYPE C DRIVEWAY

(COMMERCIAL DRIVEWAY)

WIDTH (FT)

MIN

MAX

RADIUS (FT)

MIN MAX

10 20

- 1. REPAIR, RECONSTRUCTION OR REPLACEMENT OF 7. CURB RAMPS THAT ARE STEEPER THAN A 1:12 MAX SIDEWALKS SHALL MEET PERMITTING REQUIREMENTS SLOPE WILL NOT BE ACCEPTED BY THE CITY OF OF CODE OF ORDINANCES SECTION 40-552.
- 2. FOR REPAIR, RECONSTRUCTION, OR REPLACEMENT 8. REFER TO CONTRACT DRAWINGS FOR PEDESTRIAN
- OF EXISTING SIDEWALKS: 2.1. EXISTING SIDEWALKS LESS THAN OR EQUAL
- TO 20 FEET IN TOTAL LENGTH: 2.1.1. THE PROPOSED SIDEWALK WIDTH
- EXISTING SIDEWALK. 2.2. EXISTING SIDEWALKS GREATER THAN 20 FEET IN TOTAL LENGTH:

WILL BE ALLOWED TO MATCH THE

- 2.2.1. THE SIDEWALK WIDTH FOR THE ENTIRE PROPERTY WIDTH SHALL BE IMPROVED TO MEET WIDTH REQUIREMENTS ACCORDING TO THE LATEST INFRASTRUCTURE DESIGN
- 2.3. 20 FOOT TOTAL LENGTH IS DEFINED AS:
  - 2.3.1. UP TO 10 FEET ON BOTH SIDES OF THE DRIVEWAY: OR
  - 2.3.2. UP TO 20 FEET WHEN SIDEWALK AFFECTED IS LOCATED ONLY ON ONE SIDE OF THE DRIVEWAY.
- 3. ALL JOINTS ALONG THE SIDEWALK SHALL BE CONSTRUCTED ACCORDING TO DRAWING 02752-02 AND SPECIFICATION 02752.
- 4. DRIVEWAYS SHALL BE MINIMUM 6" THICK FOR SINGLE FAMILY AND DUPLEXES. DRIVEWAYS SHALL BE MINIMUM 7" THICK FOR ALL OTHERS
- (I.E. COMMERCIAL, INDUSTRIAL, ETC.) 5. DRIVEWAYS AND SIDEWALKS SHALL BE CONSTRUCTED WITH PORTLAND CEMENT CONCRETE AND INCLUDE 5 1/2 SACKS OF CEMENT PER CUBIC YARD OF CONCRETE.
- 6. ALL RAMPS AND SIDEWALKS/WALKWAYS SHALL BE CONSTRUCTED IN ACCORDANCE WITH HOUSTON PUBLIC WORKS STANDARDS, TEXAS ACCESSIBILITY STANDARDS (TAS) AND AMERICANS WITH DISABILITIES ACT (ADA) REQUIREMENTS. IF THERE IS A CONFLICT IN THE REQUIREMENTS, THE STRICTEST REQUIREMENTS SHALL GOVERN.

- REALM (PR), SIDEWALK (SW), FRONTAGE BUFFER (FB), AND SAFETY BUFFER (SB) WIDTHS.
- 9. DETECTABLE WARNING SURFACES:
- 9.1. SIDEWALK SHALL HAVE A DETECTABLE WARNING SURFACE WHERE:
  - 9.1.1. SIDEWALK INTERSECTS TYPE C DRIVEWAYS (COMMERCIAL DRIVEWAYS) THAT ARE STOP, YIELD, OR TRAFFIC SIGNAL CONTROLLED; OR
  - 9.1.2. SIDEWALK SLOPE IS GREATER THAN 1:20 AND INTERSECTS A TYPE C DRIVEWAY (COMMERCIAL DRIVEWAY)
- 9.2. DETECTABLE WARNING SURFACES ARE OPTIONAL WHERE SIDEWALKS INTERSECT TYPE A DRIVEWAYS (SINGLE FAMILY RESIDENTIAL HOUSES OR DÙPLEXES) OR TYPE B DRIVEWAYS (SHARED ACCESS/SHARED DRIVEWAYS).
- 9.3. REFER TO STANDARD DETAILS 02775-06 TO 02775-07 FOR DETECTABLE WARNING SURFACE STANDARDS.

| APPROVED BY:                                   | APPROVED BY:                 |
|--|------------------------------|
| Docusigned by: Sulail Earwar 9EF8B0C841F5478   | EHING NGUYEN 95A29EFDA75B4CD |
| CITY ENGINEER                                  | CITY TRAFFIC ENGINEER        |
| APPROVED BY:                                   |                              |
| DocuSigned by:  Lirol Hadlock  A93C410B72B3453 |                              |
| DIRECTOR OF HOUS                               | TON PUBLIC WORKS             |
| EFF DATE: NOV-27-2023                          | DWG NO: 02754-01B            |
|  |                              |
|  | HOUSTON                      |

DRIVEWAY DETAIL WITH 6" CURBED STREETS

|               | FOR CITY OF HOUSTON USE ONL |
|---------------|-----------------------------|
|               |                             |
| DRAWING SCALE |                             |
| NOT TO SCALE  |                             |
|               |                             |
|               | ]                           |

HOUSTON PUBLIC WORKS STANDARD

HOUSTON PUBLIC WORKS SHARPSTOWN AREA DETENTION

15021 KATY FREEWAY, STE. 500

TX FIRM NUMBER: F-6932

SURVEYED BY: LANDTECH, INC.

HOUSTON, TX. 77094

281-945-0069

FB NO. P-6331

POND A

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THE AUTHORITY OF

RODRIGO GUADARRAMA

TEXAS REG. NO. 111437

OCTOBER 15, 2025

IT IS NOT TO BE USED


FOR CONSTRUCTION

PURPOSES

DRIVEWAY DETAIL

FOR CITY OF HOUSTON USE ONLY WBS NUMBER M-410040-001A-4 DRAWING SCALE AS NOTED CITY OF HOUSTON PM SUPUN ILANGAMUDALIGE P.E. SHEET NO. 25 OF 42



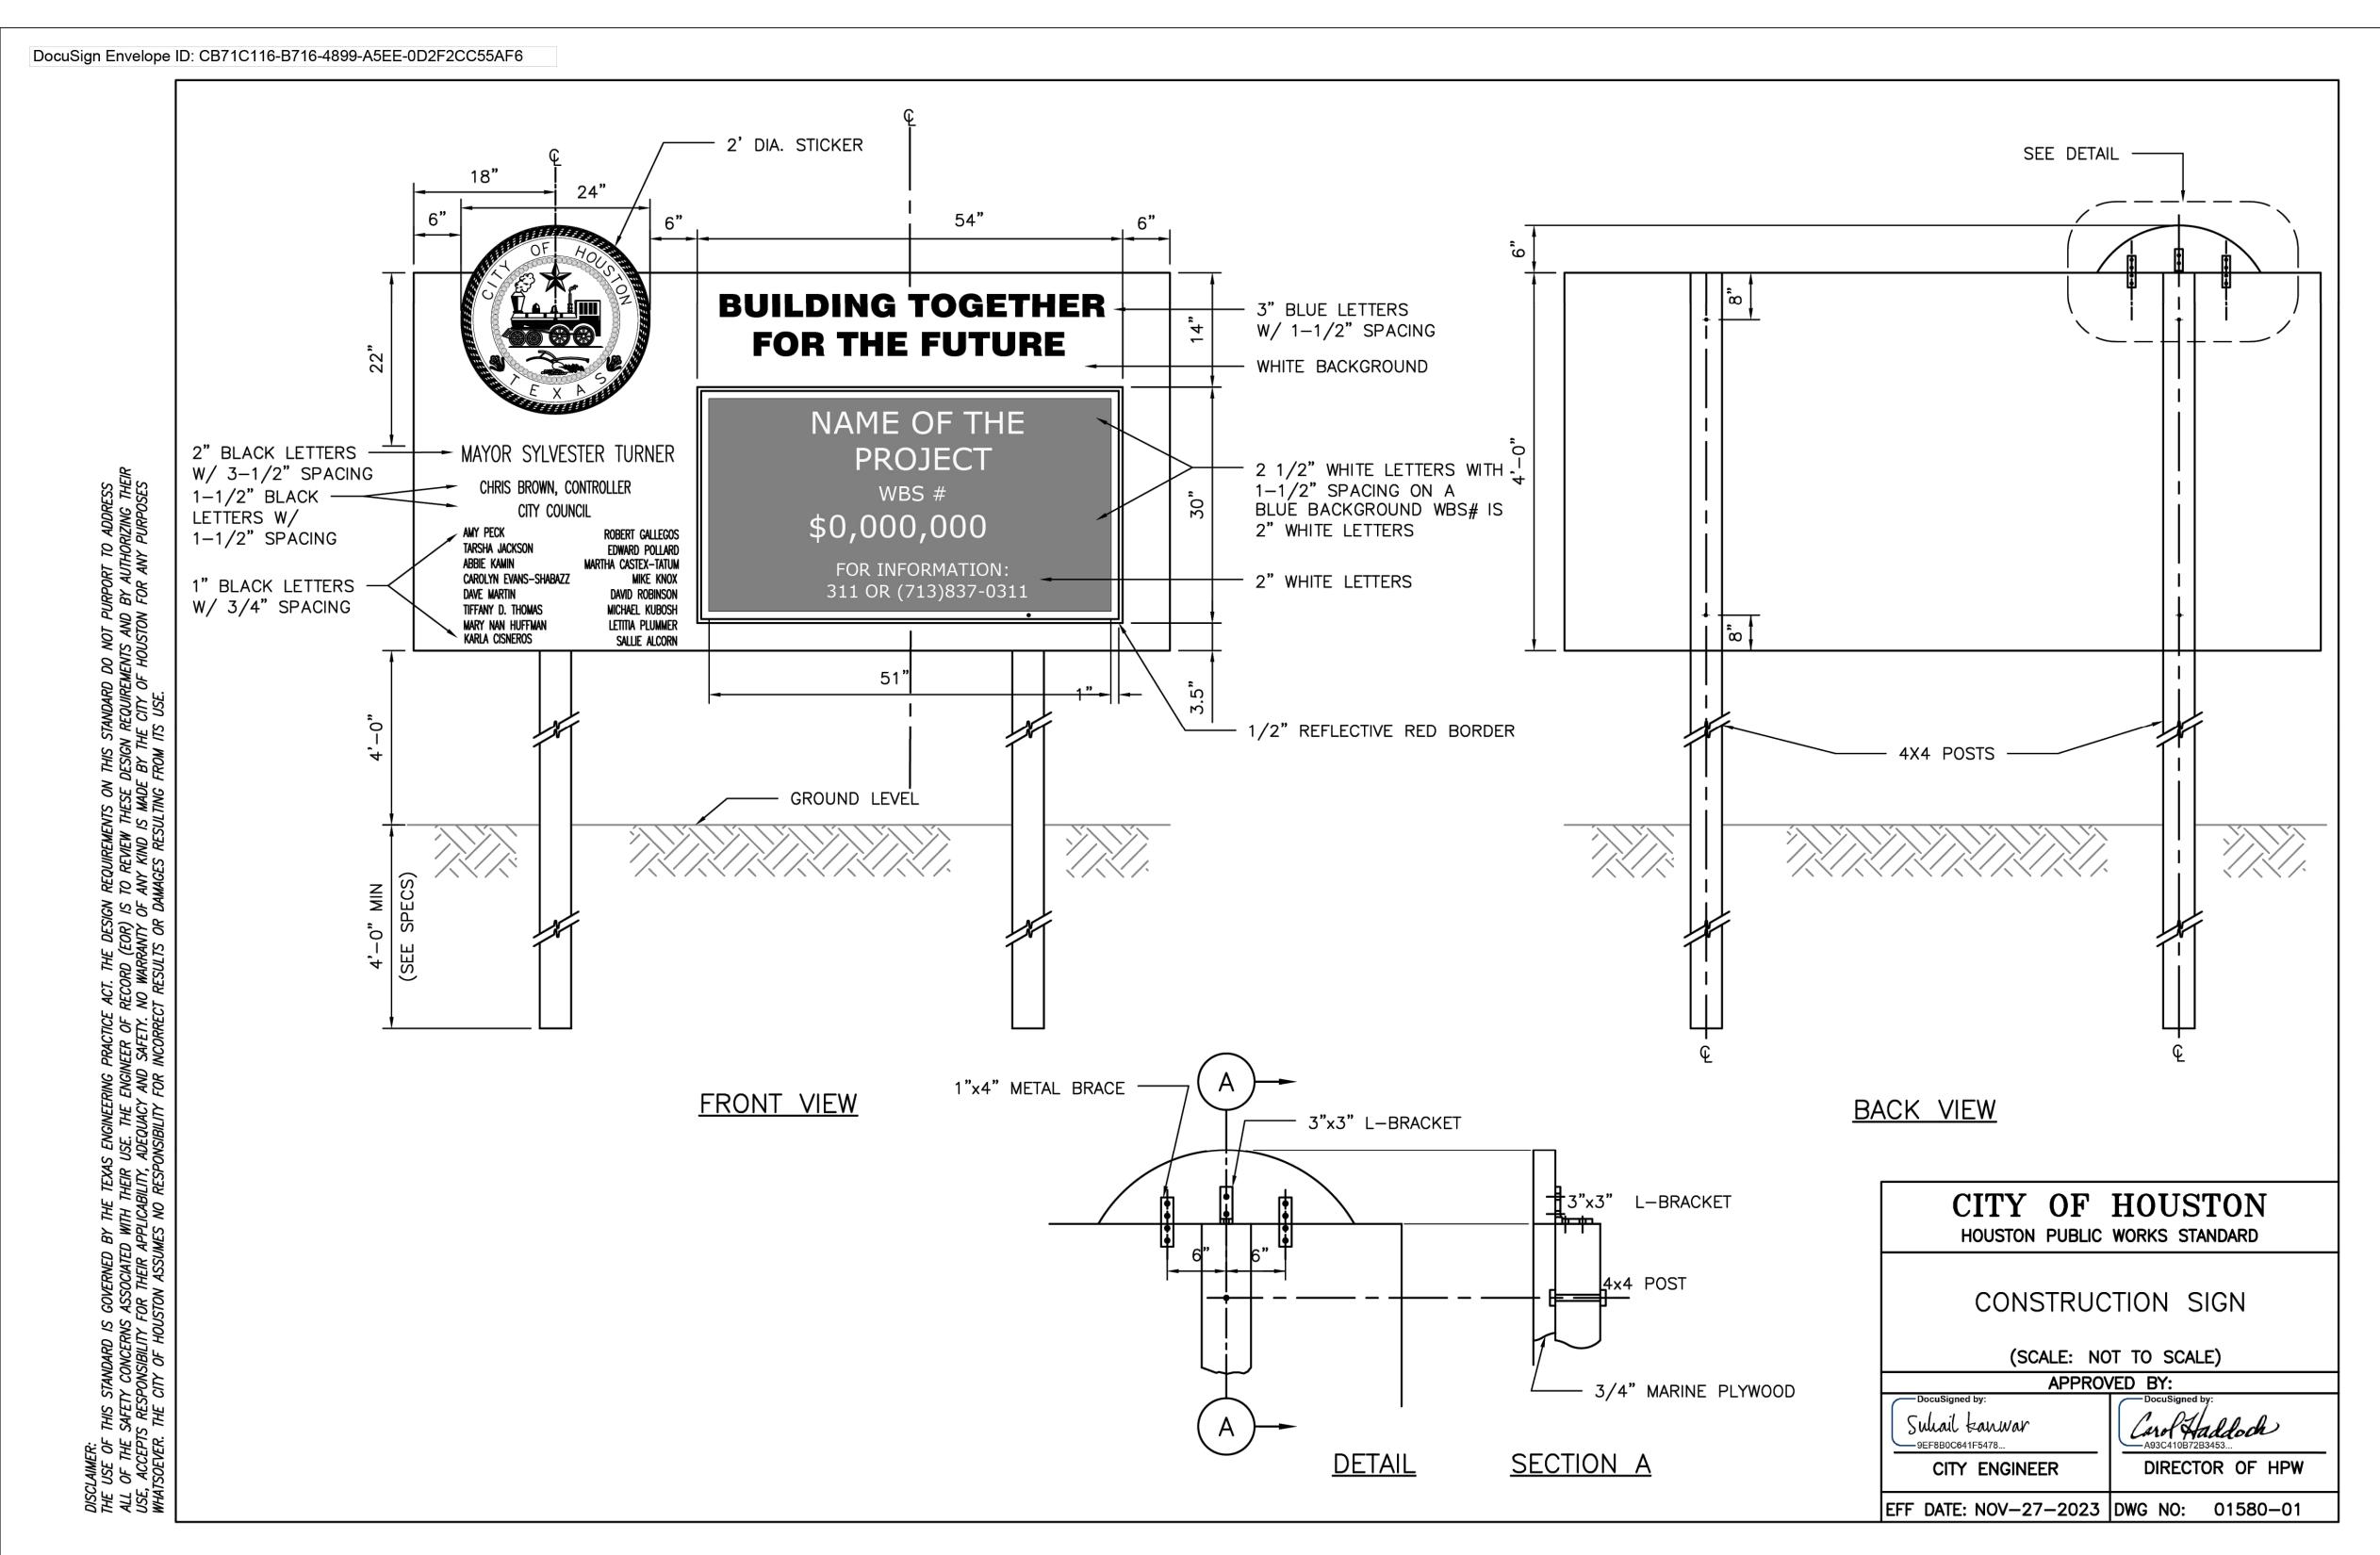

15021 KATY FREEWAY, STE. 500 HOUSTON, TX. 77094 281-945-0069 TX FIRM NUMBER: F-6932

FB NO. P-6331

SURVEYED BY: LANDTECH, INC.

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THE AUTHORITY OF RODRIGO GUADARRAMA TEXAS REG. NO. 111437 OCTOBER 15, 2025

IT IS NOT TO BE USED FOR CONSTRUCTION PURPOSES

OF HOUSTON HOUSTON PUBLIC WORKS

SHARPSTOWN AREA DETENTION POND A

CONSTRUCTION SIGN DETAIL

|      | WBS NUMBER                | FOR CITY OF HOUSTON USE ONLY |
|------|---------------------------|------------------------------|
|      | M-410040-001A-4           |                              |
|      | DRAWING SCALE             |                              |
|      | AS NOTED                  |                              |
|      | CITY OF HOUSTON PM        |                              |
|      | SUPUN ILANGAMUDALIGE P.E. |                              |
| 1020 | SHEET NO. 26 OF 42        |                              |

#### NOTE

 INSTALLATION OF STORM POLLUTION PREVENTION STRUCTURES FOR BACKSLOPE SWALES MUST BE COMPLETE BEFORE CONSTRUCTION OPERATIONS TAKE PLACE. (CLEARING AND GRUBBING OPERATIONS MAY TAKE PLACE CONCURRENTLY WITH THE INSTALLATION OF POLLUTION PREVENTION STRUCTURES)

(SOD)

- 2. STORM POLLUTION PREVENTION STRUCTURES SHOWN WILL REMAIN IN PLACE UNTIL ENGINEER ACCEPTS CONSTRUCTION IS COMPLETED. CERTAIN CIRCUMSTANCES MAY REQUIRE STORM POLLUTION PREVENTION MEASURES TO REMAIN IN PLACE UNTIL SITE HAS BEEN PERMANENTLY STABILIZED WITH VEGETATION. CONCRETE PAVING, RIPRAP, OR ARTICULATED CONCRETE BLOCK.
- 3. ONLY TYPICAL EROSION AND SEDIMENTATION CONTROL STRUCTURES AND LOCATIONS ARE SHOWN. CONTRACTOR IS RESPONSIBLE FOR COMPLYING WITH ALL REQUIREMENTS OF TPDES CONSTRUCTION GENERAL PERMIT. IF WASHING IS DONE AT CONSTRUCTION ACCESS POINT, CONTRACTOR WILL INSTALL SEDIMENT TRAPS TO CONTROL WASH WATER SEDIMENT. COST OF SEDIMENT TRAPS ARE INCIDENTAL TO STABILIZED CONSTRUCTION ACCESS.

- 4. OFF-SITE TRACKING OF SEDIMENT SHALL BE MINIMIZED. SEDIMENT TRACKED OFF-SITE SHALL BE REMOVED IMMEDIATELY AND DISPOSED OF BY CONTRACTOR AT HIS EXPENSE AT AN APPROVED LOCATION.
- 5. REINFORCED SILT FENCE SHALL BE USED AROUND ALL STOCKPILES.
  DISTURBED AREAS, AND AREAS USED FOR STORAGE OF MATERIALS THAT
  ARE EXPOSED TO PRECIPITATION AND HAVE THE POTENTIAL FOR STORM
  POLLUTION ENTERING THE DRAINAGE SYSTEM.
- 6. INSTALL SOD AROUND THE BACKSLOPE INTERCEPTOR, ACROSS THE SWALES AND ALONG THE SLOPES OF THE CHANNEL.
- 7. SCAs NEED TO BE PROVIDED AT ALL ACCESS POINTS. ALTERNATE ACCESS POINTS NEED TO BE APPROVED BY THE HCFCD ENGINEER.

## LEGEND

WANDA LANE

60' R.O.W. vol. 183, pg. 121, h.c.m.r.

28' PRIVATE STREET VOL. 230, PG. 55, H.C.M.R.


IPB-II

IPB-I


INLET PROTECTION BARRIER STAGE I

INLET PROTECTION BARRIER STAGE II

STABILIZED CONSTRUCTION ACCESS

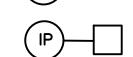

INTERCEPTOR STRUCTURE & INLET PROTECTION

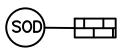

SODDING



ROCK FILTER DAM

FLOW DIRECTION



FLOATING TURBIDITY CURTAINS

# ISAN

civil \ design \ engineers
10448 Westoffice Drive
Houston, Texas 77042
P 713 747 2399
F 713 748 3748
TBPE Firm Reg. #4575

SURVEYED BY: LANDTECH, INC. FB NO. P-6331

ENGINEER: RAHUL B MENON, P.E
P.E. Reg No: 130533
DATE: JUNE 2025

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NOT INTENDED FOR PERMIT

BIDDING OR CONSTRUCTION


# CITY OF HOUSTON HOUSTON PUBLIC WORKS

# SHARPSTOWN AREA DETENTION POND A

STORMWATER POLLUTION PREVENTION PLAN LAYOUT SHEET 1 OF 2

| WBS NUMBER           | FOR CITY OF HOUSTON USE ONLY |
|----------------------|------------------------------|
| M-410040-001A-3      |                              |
| DRAWING SCALE        |                              |
| 1"=40'               |                              |
| CITY OF HOUSTON PM   |                              |
| SUPUN ILANGAMUDALIGE |                              |
| SHEET NO. 27 OF 42   |                              |

# MATCH LINE A-A

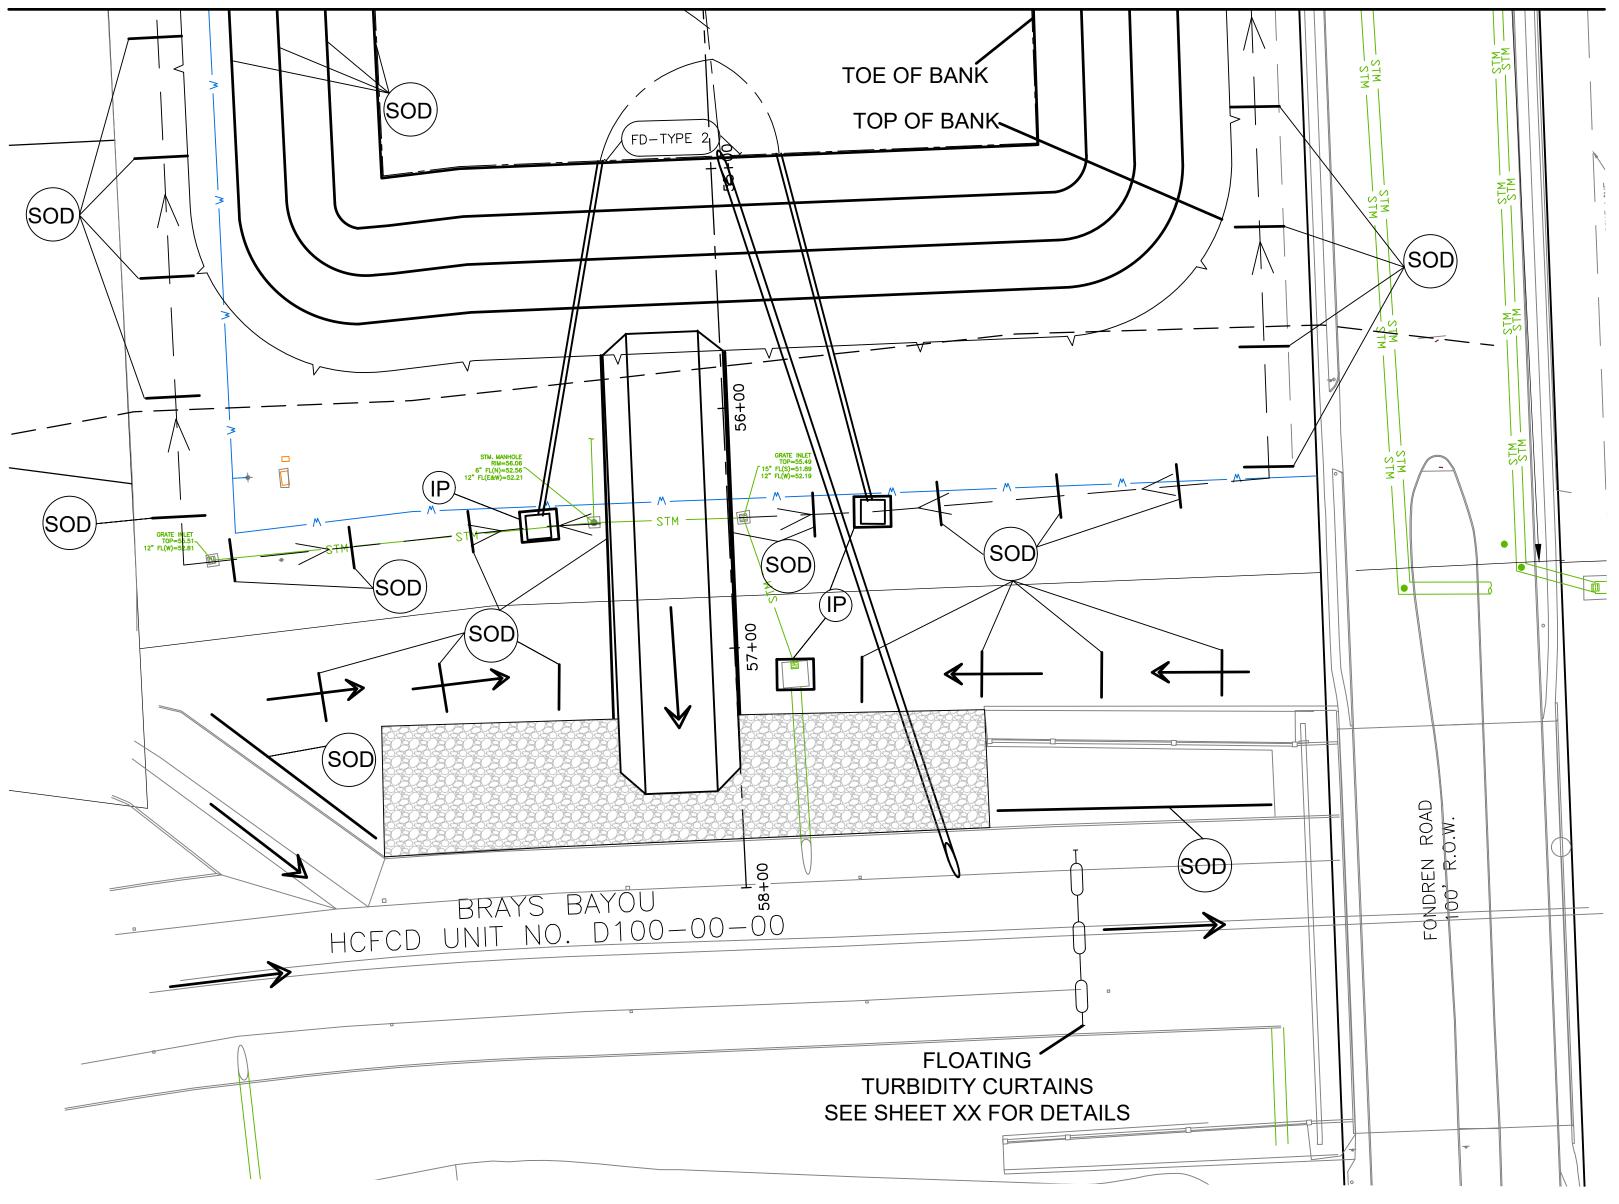

#### NOTE

- 1. INSTALLATION OF STORM POLLUTION PREVENTION STRUCTURES FOR BACKSLOPE SWALES MUST BE COMPLETE BEFORE CONSTRUCTION OPERATIONS TAKE PLACE. (CLEARING AND GRUBBING OPERATIONS MAY TAKE PLACE CONCURRENTLY WITH THE INSTALLATION OF POLLUTION PREVENTION STRUCTURES)
- 2. STORM POLLUTION PREVENTION STRUCTURES SHOWN WILL REMAIN IN PLACE UNTIL ENGINEER ACCEPTS CONSTRUCTION IS COMPLETED. CERTAIN CIRCUMSTANCES MAY REQUIRE STORM POLLUTION PREVENTION MEASURES TO REMAIN IN PLACE UNTIL SITE HAS BEEN PERMANENTLY STABILIZED WITH VEGETATION. CONCRETE PAVING, RIPRAP, OR ARTICULATED CONCRETE BLOCK.
- 3. ONLY TYPICAL EROSION AND SEDIMENTATION CONTROL STRUCTURES AND LOCATIONS ARE SHOWN. CONTRACTOR IS RESPONSIBLE FOR COMPLYING WITH ALL REQUIREMENTS OF TPDES CONSTRUCTION GENERAL PERMIT. IF WASHING IS DONE AT CONSTRUCTION ACCESS POINT, CONTRACTOR WILL INSTALL SEDIMENT TRAPS TO CONTROL WASH WATER SEDIMENT. COST OF SEDIMENT TRAPS ARE INCIDENTAL TO STABILIZED CONSTRUCTION ACCESS.

- 4. OFF-SITE TRACKING OF SEDIMENT SHALL BE MINIMIZED. SEDIMENT TRACKED OFF-SITE SHALL BE REMOVED IMMEDIATELY AND DISPOSED OF BY CONTRACTOR AT HIS EXPENSE AT AN APPROVED LOCATION.
- 5. REINFORCED SILT FENCE SHALL BE USED AROUND ALL STOCKPILES. DISTURBED AREAS, AND AREAS USED FOR STORAGE OF MATERIALS THAT ARE EXPOSED TO PRECIPITATION AND HAVE THE POTENTIAL FOR STORM POLLUTION ENTERING THE DRAINAGE SYSTEM.
- 6. INSTALL SOD AROUND THE BACKSLOPE INTERCEPTOR, ACROSS THE SWALES AND ALONG THE SLOPES OF THE CHANNEL.
- 7. SCAs NEED TO BE PROVIDED AT ALL ACCESS POINTS. ALTERNATE ACCESS POINTS NEED TO BE APPROVED BY THE HCFCD ENGINEER.




## LEGEND

IPB-I


INLET PROTECTION BARRIER STAGE I

INLET PROTECTION BARRIER STAGE II

STABILIZED CONSTRUCTION ACCESS

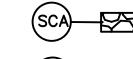


INTERCEPTOR STRUCTURE & INLET PROTECTION

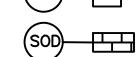



FLOW DIRECTION

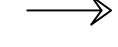

FLOATING TURBIDITY CURTAINS

INTERIM REVIEW ONLY DOCUMENT INCOMPLETE;

NOT INTENDED FOR PERMIT BIDDING OR CONSTRUCTION ENGINEER: RAHUL B MENON, P.E. P.E. Reg No: 130533

DATE: JUNE 2025

10448 Westoffice Drive Houston, Texas 77042 P 713 747 2399 F 713 748 3748 TBPE Firm Reg. #4575


SURVEYED BY: LANDTECH, INC. FB NO. P-6331

## CITY OF HOUSTON HOUSTON PUBLIC WORKS

### SHARPSTOWN AREA DETENTION POND A

STORMWATER POLLUTION PREVENTION PLAN LAYOUT SHEET 2 OF 2

| WBS NUMBER           | FOR CITY OF HOUSTON USE ONLY |
|----------------------|------------------------------|
| M-410040-001A-3      |                              |
| DRAWING SCALE        |                              |
| 1"=40'               |                              |
| CITY OF HOUSTON PM   |                              |
| SUPUN ILANGAMUDALIGE |                              |
| SHEET NO. 28 OF 42   |                              |

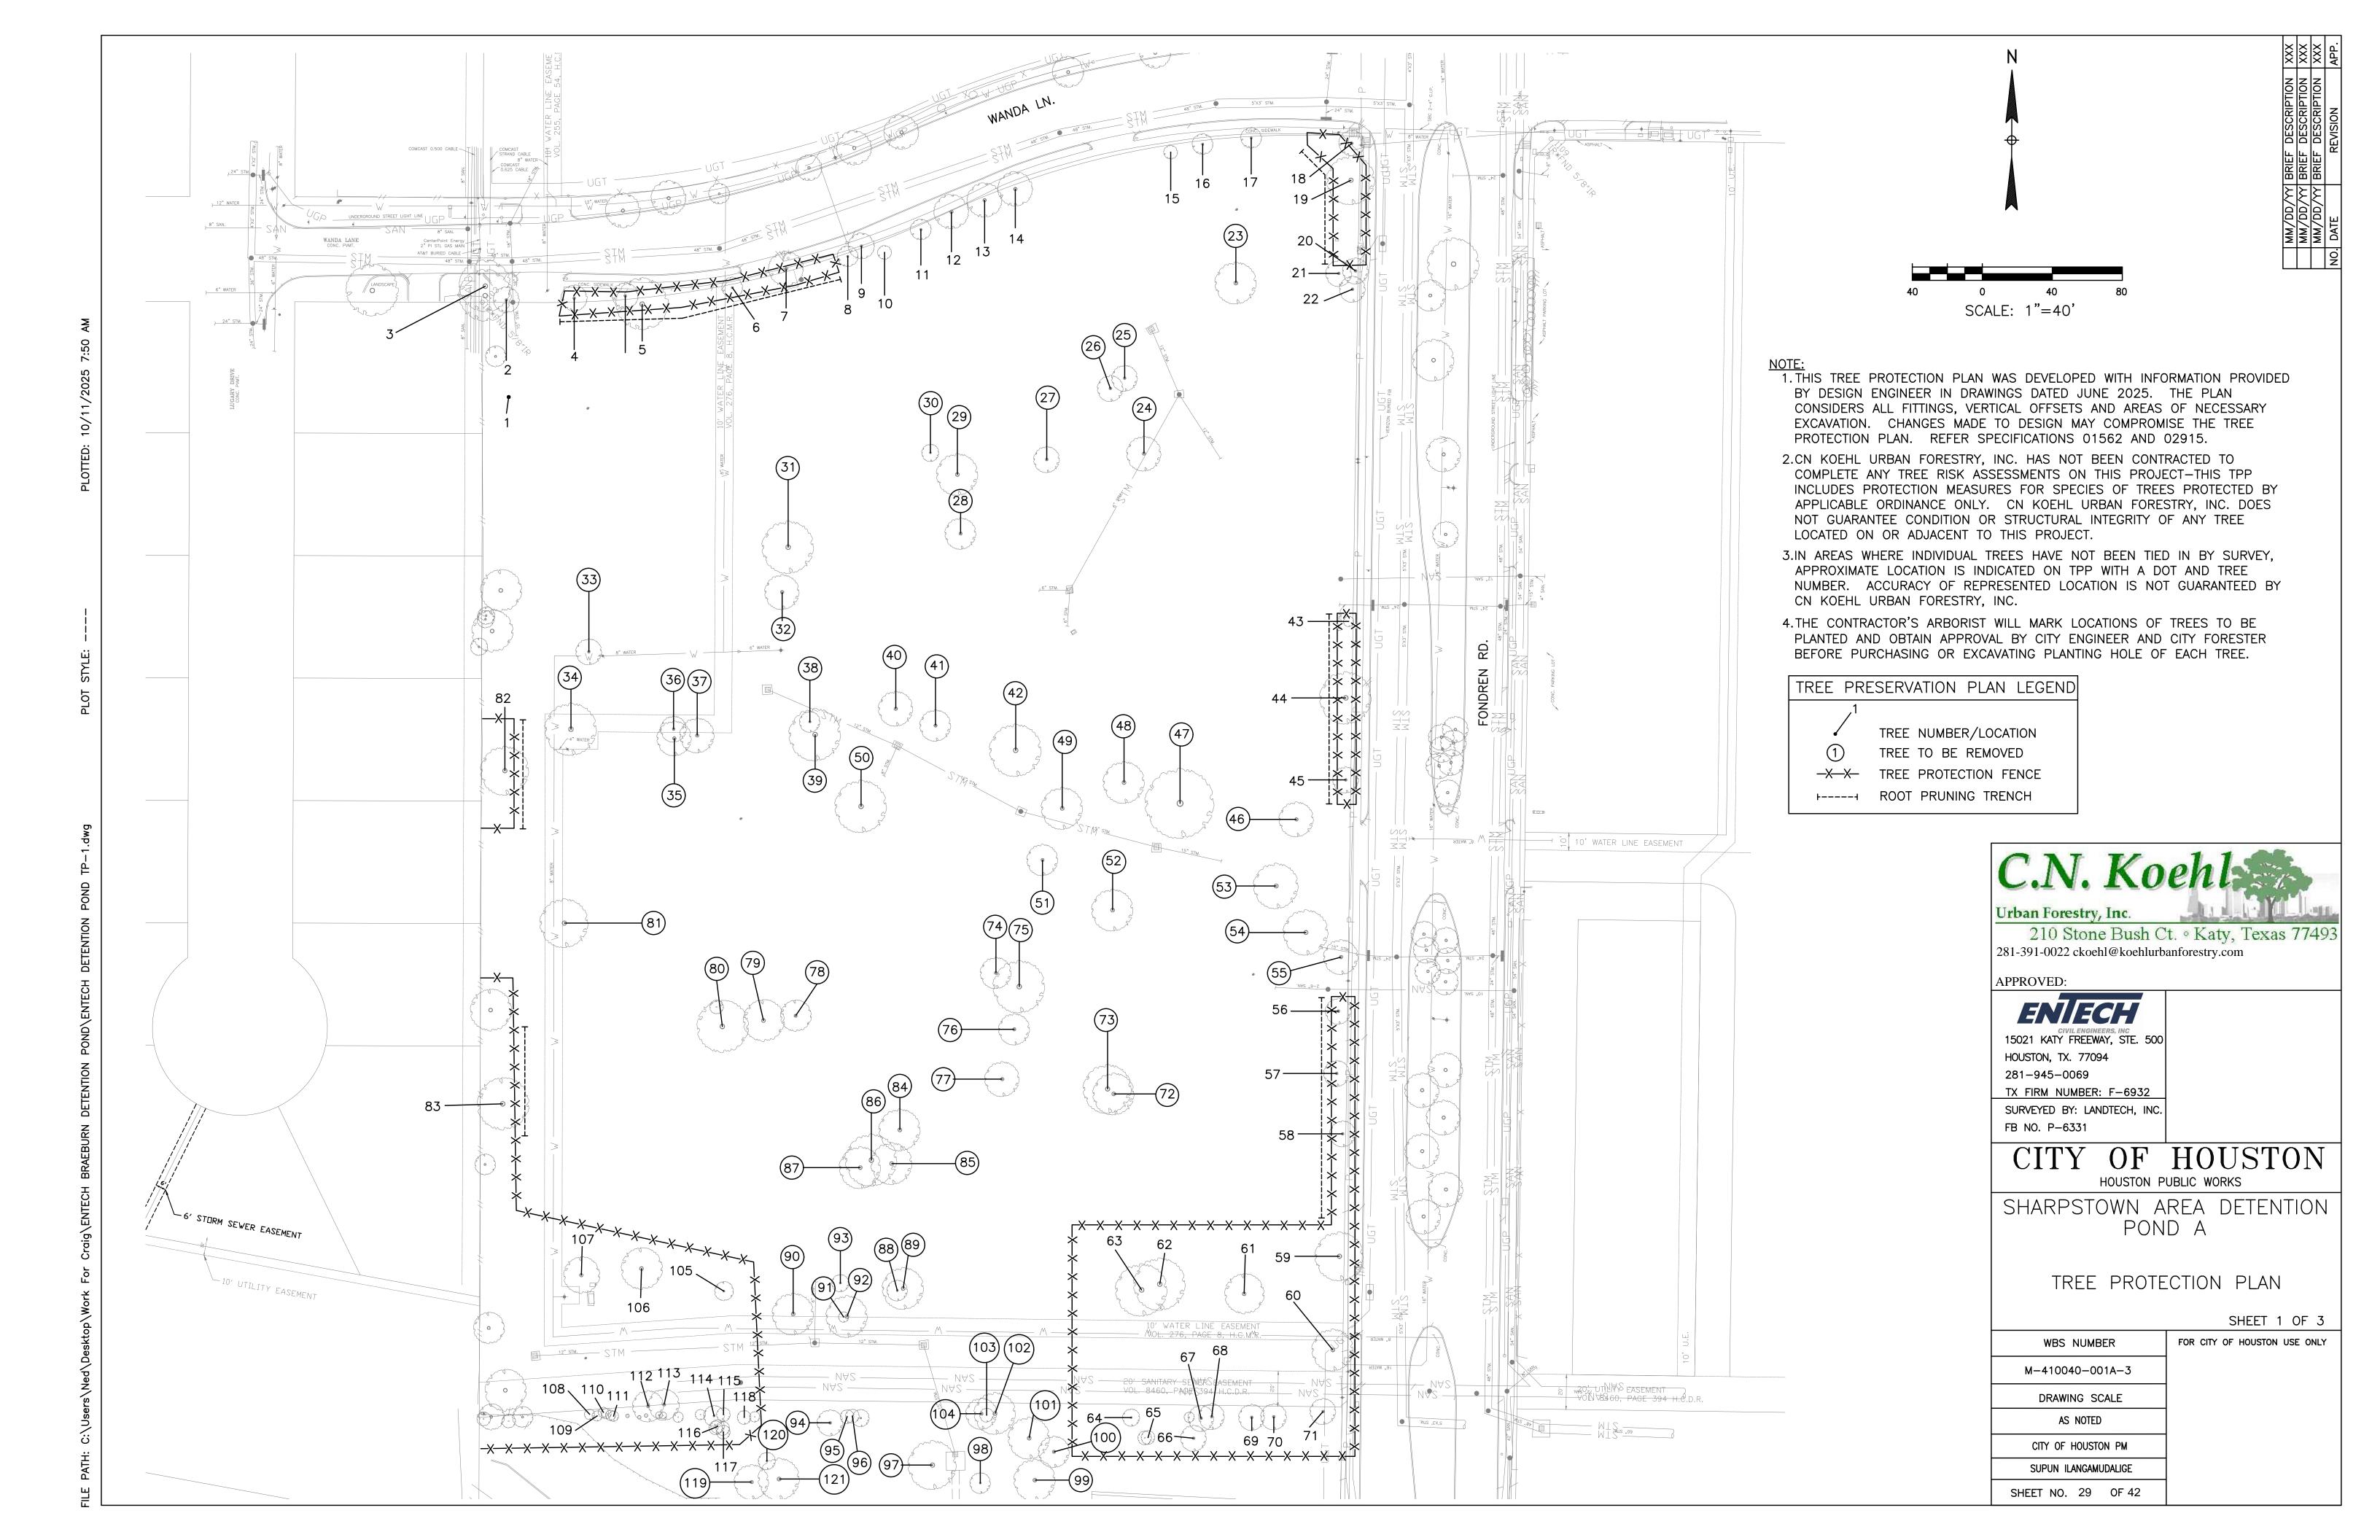

| The book   Location   Description   Status   Comments   Treatment  |          |                   |  | _         |                               |  |
|--|----------|-------------------|--|-----------|-------------------------------|--|
| 1 1010 Forden Road 3 12 Supathery Nor Protected 1 1010 Forden Road 3 1010 Forden Road 4 1010 Forden Road 4 1010 Forden Road 4 1010 Forden Road 5 1010 Forden Road 6 1010 Forden Road 7 Accord Ash 1010 Forden Road 7 1010 Forden Road 7 Road Road 7 Road Road 7 Road Road 7 Road Road 8 1010 Forden Road 7 Road Road 8 1010 Forden Road 7 Road Road 8 1010 Forden Road 9 1010 Forden R | Tree     |                   |  | -         |                               |  |
| 3   100 Former Road   15" Ligarium   Not Protected   |          |                   | <u> </u>   |           | Comments                      | Treatment                              |
| 3   900 Fordien Road   15" Ligastum   Nc. Protected   Ferce, Roat pune for dicht   5" 900 Fordien Road   15" Attacos Ash   Protected   Ferce, Roat pune for dicht   15" Attacos Ash   9" 100 Fordien Road   2" Code Elm   Protected   Ferce, Roat pune for dicht   15" 10" 10"   15" 10" 10"   15" 10"   15" 10"   15" 10"   15" 10"   15" 10"   15" 10" 10"   15" 10"   15" 10"   15" 10"   15" 10"   15" 10"   15" 10" 10"   15" 10"   15" 10"   15" 10"   15" 10"   15" 10"   15" 10" 10"   15" 10"   15" 10" 10"   15" 10" 10"   15" 10" 10"   15" 10" 10"   15" 10" 10"   15" 10" 10"   15" 10" 10"   15" 10" 10"   15" 10" 10"   15" 10" 10"   15" 10" 10" 10"   15" 10" 10" 10"   15" 10" 10" 10"   15" 10" 10" 10" 10" 10" 10" 10" 10" 10" 10  |          |                   |  |           |                               |  |
| April   10  Fonders Road   19' César Elim   Protected   Fence, Roat pume for rich   19' César Elim   Protected   Fence, Roat pume for rich   19' César Elim   Protected   Fence, Roat pume for rich   19' César Elim   19' César Elim   Protected   Fence, Roat pume for rich   19' César Elim   19'    |          |                   | <u> </u>   |           |                               |  |
| 300 Fordinin Road   37* Altzona Ash   Personal Color Em   Professed   Fortice Road   Fortice R   | <u> </u> |                   | _  |           |                               |  |
| Professor   Prof   |          |                   |  |           |                               | •                                      |
| 9 9100 Fondern Road 9 100 Fondern Road 9 100 Fondern Road 9 1100 Fondern Road 10 9100 Fondern Road 11 9100 Fondern Road 12 9100 Fondern Road 12 9100 Fondern Road 13 9100 Fondern Road 13 9100 Fondern Road 14 9100 Fondern Road 15 9100 Fondern Road 15 9100 Fondern Road 16 9100 Fondern Road 17 9100 Fondern Road 19 9100 Fondern |          |                   |  |           |                               | · ·                                    |
| 8 PIOP Fanchern Road 10 PIOP Fanchern Road 11 PIOD Fanchern Road 12 PIOD Fanchern Road 12 PIOD Fanchern Road 13 PIOD Fanchern Road 14 PIOD Fanchern Road 15 PIOD Fanchern Road 16 PIOD Fanchern Road 17 PIOD Fanchern Road 17 PIOD Fanchern Road 18 PIOD Fanchern Road 19 PIOD Fanchern Road 1 |          |                   |  |           |                               | ·                                      |
| Second   S   |          |                   |  |           |                               | Fence, Root prune for ditch            |
| 10 1000 Fondrien Road 11 1000 Fondrien Road 11 10 Cope Myrtla 13 1000 Fondrien Road 11 11 Cope Myrtla 13 1000 Fondrien Road 11 10 Cope Myrtla 13 1000 Fondrien Road 12 10 100 Fondrien Road 13 1000 Fondrien Road 14 10 Fondrien Road 15 10 Fondrien Road 16 10 Fondrien Road 17 10 Fondrien Road 18 10 Fondrien Road 19 10 Fondrien Road 19 10 Fondrien Road 10 Fondri | <u> </u> |                   | · · ·  |           |                               |  |
| 11 19100 Fonden Road 11 19 Crope Ryttle 13 19100 Fonden Road 16 19 Crope Ryttle 13 19100 Fonden Road 18 19 Crope Ryttle 19 19100 Fonden Road 19 19100 F |          |                   |  |           |                               |  |
| 12 1900 Fondern Road 11" Crepe Hytels Not Protected 13 9100 Fondern Road 11" Crepe Hytels Not Protected 15 9100 Fondern Road 11" Crepe Hytels Not Protected 15 9100 Fondern Road 11" Crepe Hytels Not Protected 15 9100 Fondern Road 11" Crepe Hytels Not Protected 15 9100 Fondern Road 11" Crepe Hytels Not Protected 15 9100 Fondern Road 11" Crepe Hytels Not Protected 15 9100 Fondern Road 11" Crepe Hytels Not Protected 15 9100 Fondern Road 15" Line Oak Protected 15 9100 Fondern Road 15" Line Oak Protected 15 9100 Fondern Road 15" Line Oak Protected 15 9100 Fondern Road 15" Crepe Hytel Not Protected 15 9100 Fondern Road 15" Crepe Hytel Not Protected 15 9100 Fondern Road 15" Crepe Hytel Not Protected 15 9100 Fondern Road 15" Stadford Pear Not Protected 15 9100 Fondern Road 15" Stadford Pear Not Protected 15 9100 Fondern Road 15" Stadford Pear Not Protected 15 9100 Fondern Road 15" Stadford Pear Not Protected 15 9100 Fondern Road 15" Stadford Pear Not Protected 15 9100 Fondern Road 15" Stadford Pear Not Protected 15 9100 Fondern Road 15" Stadford Pear Not Protected 15 9100 Fondern Road 15" Stadford Pear Not Protected 15 9100 Fondern Road 15" Arizona Ash Not Protected 15 9100 Fondern Road 15" Arizona Ash Not Protected 15 9100 Fondern Road 15" Arizona Ash Not Protected 15 9100 Fondern Road 15" Arizona Ash Not Protected 15 9100 Fondern Road 15" Arizona Ash Not Protected 15 9100 Fondern Road 15" Arizona Ash Not Protected 15 9100 Fondern Road 15" Arizona Ash Not Protected 15 9100 Fondern Road 15" Arizona Ash Not Protected 15 9100 Fondern Road 15" Arizona Ash Not Protected 15 9100 Fondern Road 15" Arizona Ash Not Protected 15 9100 Fondern Road 15" Arizona Ash Not Protected 15 9100 Fondern Road 15" Arizona Ash Not Protected 15 9100 Fondern Road 15" Arizona Ash Not Protected 15 9100 Fondern Road 15" Arizona Ash Not Protected 15 9100 Fondern Road 15" Arizona Ash Not Protected 15 9100 Fondern Road 15" Arizona Ash Not Protected 15 9100 Fondern Road 15" Arizona Ash Not Protected 15 9100 Fondern Road 15" Arizona Ash Not Protected 15  |          |                   |  |           |                               |  |
| 133 1910 Frontern Road 11" Crope Myrtle Not Protected 15" Crop |          |                   |  |           |                               |  |
| 190 Fondren Road 11" Crope Myrtle Not Protected Fonder Road 12" Live Oak Protected Topped by Center Point Energy Fonder Road 9" Crope Myrtle Not Protected Fonder Road 9" Artzona Ash Not Protected Fonder Road 9" Artzona Road 9" Artzon |          |                   | · · · · · · · · · · · · · · · · · · ·            |           |                               |  |
| 15 9100 Fondren Road 11" Crepe Myrtle Nat Protected 19 100 Fondren Road 11" Crepe Myrtle Nat Protected 19 100 Fondren Road 11" Crepe Myrtle Nat Protected 19 9100 Fondren Road 19" Crepe Myrtle Nat Protected 19 9100 Fondren Road 9" Crepe Myrtle Nat Protected 19 9100 Fondren Road 9" Crepe Myrtle Nat Protected 19 9100 Fondren Road 9" Crepe Myrtle Nat Protected 19 9100 Fondren Road 9" Crepe Myrtle Nat Protected 19 9100 Fondren Road 9" Crepe Myrtle Nat Protected 19 9100 Fondren Road 9" Crepe Myrtle Nat Protected 19 9100 Fondren Road 9" Crepe Myrtle Nat Protected 19 9100 Fondren Road 19" Crepe Myrtle Nat Protected 19 9100 Fondren Road 19" Family Protected 19 9100 Fondren Road 19" Family Protected 19 9100 Fondren Road 10" Holly 19 Protected 19 9100 Fondren Road 19" Family 19 9100  |          |                   | · · ·  |           |                               |  |
| 15 9100 Fondren Road 11" Crepe Myrile Not Protected 15" Crepe  |          |                   |  |           |                               |  |
| 19 9100 Fondren Road 11° Crepe Myrtle Not Protected Fonder Energy Fence. Root prune for ditch. Clearance 19 9100 Fondren Road 9° Crepe Myrtle Not Protected 70 Pr |          |                   | · · · · · · · · · · · · · · · · · · ·            |           |                               |  |
| 15 9 100 Fondren Road 16° Cedar Elm Protected 70 Protecte |          |                   | <u> </u>   |           |                               |  |
| 15 9100 Fondren Road 9° Crepe Myrtle Nat Protected 9° Crepe Myrtle |          |                   |  |           |                               | Fence Root prune for ditch             |
| 20   9100 Fondren Road   9° Crepe Myrtle   Not Protected   |          |                   |  |           | Topped by Center Point Energy | •                                      |
| 22 9100 Fondren Road 9° Crepe Myrtle Not Protected 23 9100 Fondren Road 9° Crepe Myrtle Not Protected 24 9100 Fondren Road 15° Bradford Pear Not Protected 25° 9100 Fondren Road 15° Bradford Pear Not Protected 25° 9100 Fondren Road 10° Holly Protected 26° 9100 Fondren Road 27° 1000 Fondren Road 28° Aizona Ash Not Protected 28° 9100 Fondren Road 28° Aizona Ash Not Protected 38° 9100 Fondren Road 28° Aizona Ash Not Protected 38° 9100 Fondren Road 28° Aizona Ash Not Protected 38° 9100 Fondren Road 28° Aizona Ash Not Protected 39° 9100 Fondren Road 28° Aizona Ash Not Protected 39° 9100 Fondren Road 28° Aizona Ash Not Protected 39° 9100 Fondren Road 28° Aizona Ash Not Protected 39° 9100 Fondren Road 39° Aizona Ash Not Protected 39° 9100 Fondren Road 39° Aizona Ash Not Protected 39° 9100 Fondren Road 39° Aizona Ash Not Protected 39° 9100 Fondren Road 39° Aizona Ash Not Protected 39° 9100 Fondren Road 39° Aizona Ash Not Protected 39° 9100 Fondren Road 39° Aizona Ash Not Protected 39° 9100 Fondren Road 39° Aizona Ash Not Protected 39° 9100 Fondren Road 39° Aizona Ash Not Protected 39° 9100 Fondren Road 30° Aizona Ash Not Protected 39° 9100 Fondren Road 30° Aizona Ash Not Protected 39° 9100 Fondren Road 30° Aizona Ash Not Protected 39° 9100 Fondren Road 30° Aizona Ash Protected 30° 9100 Fondren Road 30° Aizona Ash Not Protected 30° 9100 Fondren Road 30° Aizona Ash Protected 3 |          |                   |  |           | Toppod by Conton I out Energy | Chee, rest plans for altern, electrice |
| 22 9100 Fondren Road 2° Crepe Myrtle 23 9100 Fondren Road 2° Aprox Ash Protected Remove tree, No replacement required Remo |          |                   |  |           |                               |  |
| 23 9100 Fondren Road   |          |                   | <u> </u>   |           |                               |  |
| 25 9100 Fondren Road 16" Bradford Pear Not Protected Remote tree, No replacement required Protected Dead Remote tree, No replacement required Remote Remote tree, No replacement required Remote tree, No replacement required Remote Remote tree, No replacement required Remote Remot |          |                   | <u> </u>   |           |                               | Remove tree. No replacement required   |
| 25 9100 Fondren Road 10" Holly Protected Dead Remove tree, No replacement required 26 9100 Fondren Road 8" Anzona Ash Not Protected Remove tree, No replacement required 27 9100 Fondren Road 21" Cedar Elim Protected Remove tree, No replacement required 28 9100 Fondren Road 21" Cedar Elim Protected Remove tree, No replacement required 29 9100 Fondren Road 25" Anzona Ash Not Protected B0% Dieback Remove tree, No replacement required 29 9100 Fondren Road 25" Anzona Ash Not Protected Dead Remove tree, No replacement required 29 9100 Fondren Road 25" Anzona Ash Protected Dead Remove tree, No replacement required 29 9100 Fondren Road 26" Anzona Ash Protected Remove tree, No replacement required 29 9100 Fondren Road 21" Cedar Elim Protected Remove tree, No replacement required 23 9100 Fondren Road 21" Cedar Elim Protected Remove tree, No replacement required 23 9100 Fondren Road 21" Cege Myrtle Not Protected Remove tree, No replacement required 25 9100 Fondren Road 14" Crepe Myrtle Not Protected Remove tree, No replacement required 25 9100 Fondren Road 14" Crepe Myrtle Not Protected Remove tree, No replacement required 28 9100 Fondren Road 17" Water Oak Protected Remove tree, No replacement required 29 9100 Fondren Road 17" Water Oak Protected Remove tree, No replacement required 29 9100 Fondren Road 17" Water Oak Protected Remove tree, No replacement required 29 9100 Fondren Road 17" Water Oak Protected Remove tree, No replacement required 29 9100 Fondren Road 17" Water Oak Protected Remove tree, No replacement required 29 9100 Fondren Road 17" Water Oak Protected Remove tree, No replacement required 29 9100 Fondren Road 17" Water Oak Protected Remove tree, No replacement required 29 9100 Fondren Road 21" Live Oak Protected Remove tree, No replacement required 29 9100 Fondren Road 21" Live Oak Protected Remove tree, No replacement required 29 9100 Fondren Road 26" Live Oak Protected Remove tree, No replacement required 29 9100 Fondren Road 26" Live Oak Protected Remove tree, No replacement required 29 9100 Fondren Roa |          |                   |  |           |                               | · · · · · · · · · · · · · · · · · · ·  |
| 26 9100 Fondren Road 8" Holly Protected Dead Remove tree. No replacement required Remove tree, No replacement required Remove tree, No replacement required 99 100 Fondren Road 21" Cedar Elm Protected Remove tree, No replacement required 29 9100 Fondren Road 25" Arizona Ash Not Protected Remove tree, No replacement required 31 9100 Fondren Road 12" Arizona Ash Not Protected Dead Remove tree, No replacement required 29 9100 Fondren Road 24" Arizona Ash Protected Remove tree, No replacement required Remove tree, No replacement required 31 9100 Fondren Road 24" Arizona Ash Protected Remove tree, No replacement required Remove tree, No replacement required 32 9100 Fondren Road 34" Live Oak Protected Remove tree, No replacement required Not Protected Remove tree, No replacement required Not Protected Remove tree, No replacement required Remove tree, No replacement required Remove tree, No replacement required Not Protected Remove tree, No replacement required Remove tree, No replacement required Remove tree, No replacement required Not Protected Remove tree, No replacement required Remove tree, No replacement required Not Protected Remove tree, No replacement required Not Protected Remove tree, No replacement required Not Protected Remove tree, No replacement required Remove tree, No replacement required Not Protected Remove tree, No replacement required Not Protected Remove tree, No replacement required Remove tree, No replacement required Remove tree, No replacement required Not Protected Remove tree, No replacement required Not Protected Remo |          |                   |  |           |                               | · · · · · · · · · · · · · · · · · · ·  |
| 28 9100 Fondren Road 21" Cedar Elm Protected Remove tree, No replacement required Remove tree, No replacement required 99 100 Fondren Road 25" Cadar Elm Protected Bow Remove tree, No replacement required 80% Dieback Remove tree, No replacement required 819 100 Fondren Road 36" Airzona Ash Protected Remove tree, No replacement required 819 100 Fondren Road 24" Airzona Ash Protected Remove tree, No replacement required 819 100 Fondren Road 34" Live Oak Protected Remove tree, No replacement required 829 100 Fondren Road 14" Crepe Myrtle Not Protected Remove tree, No replacement required 839 9100 Fondren Road 14" Crepe Myrtle Not Protected Remove tree, No replacement required 839 9100 Fondren Road 14" Crepe Myrtle Not Protected Remove tree, No replacement required 839 9100 Fondren Road 14" Crepe Myrtle Not Protected Remove tree, No replacement required 839 9100 Fondren Road 14" Crepe Myrtle Not Protected Remove tree, No replacement required 839 9100 Fondren Road 14" Crepe Myrtle Not Protected Remove tree, No replacement required 839 9100 Fondren Road 14" Crepe Myrtle Not Protected Remove tree, No replacement required 839 9100 Fondren Road 15" Live Oak Protected Remove tree, No replacement required 840 9100 Fondren Road 15" Cedar Elm Protected Remove tree, No replacement required 841 9100 Fondren Road 15" Cedar Elm Protected Remove tree, No replacement required 841 9100 Fondren Road 15" Live Oak Protected Remove tree, No replacement required 841 9100 Fondren Road 25" Live Oak Protected Remove tree, No replacement required 841 9100 Fondren Road 25" Live Oak Protected Remove tree, No replacement required 841 9100 Fondren Road 25" Live Oak Protected Remove tree, No replacement required 841 9100 Fondren Road 25" Live Oak Protected Remove tree, No replacement required 841 9100 Fon |          |                   | <del>                                     </del> |           | Dead                          | · · · · · · · · · · · · · · · · · · ·  |
| 28 9100 Fondren Road 21° Cedar Elm Protected Remove tree, No replacement required 9100 Fondren Road 25° Arizona Ash Not Protected 80% Dioback Remove tree, No replacement required 9100 Fondren Road 39° Arizona Ash Not Protected Remove tree, No replacement required Remove tree, No replacement required 9100 Fondren Road 39° Arizona Ash Protected Remove tree, No replacement required Remove tree, No replacement required 9100 Fondren Road 24° Arizona Ash Protected Remove tree, No replacement required 21° 100° Fondren Road 21° Arizona Ash Protected Remove tree, No replacement required Remove tree, No replacement required Remove tree, No replacement required 21° 100° Fondren Road 31° Live Oak Protected Remove tree, No replacement required Remove tre |          |                   | ļ  |           | Dead                          | · · · · · · · · · · · · · · · · · · ·  |
| 29 9100 Fondren Road 25° Arizona Ash Not Protected 80% Dieback Remove tree, No replacement required 33 9100 Fondren Road 12° Arizona Ash Protected Remove tree, No replacement required Remove tree, |          |                   |  |           |                               | · · · · · · · · · · · · · · · · · · ·  |
| 30 9100 Fondren Road 39 Arizona Ash 9100 Fondren Road 24 Arizona Ash 9100 Fondren Road 21 Cedar Elm 9100 Fondren Road 34 Live Oak 9100 Fondren Road 14 Crepe Myrtle Not Protected Remove tree, No replacement required Remove tree, No replacement  |          |                   |  |           | 80% Dieback                   | · · · · · · · · · · · · · · · · · · ·  |
| 31 9100 Fondren Road 24" Arizona Ash Protected Remove tree, No replacement required Process Remove tree, No replacement required Process Remove tree, No replacement required Remove tree, No replac |          |                   |  |           |                               | · · · · · · · · · · · · · · · · · · ·  |
| 32 9100 Fondren Road 24" Arizona Ash Protected Remove tree, No replacement required Remove tree, No replacement required 24 9100 Fondren Road 34" Live Oak Protected Remove tree, No replacement required Remove tree, No replacement required 35 9100 Fondren Road 14" Crepe Myrtle Not Protected Remove tree, No replacement required 36 9100 Fondren Road 14" Crepe Myrtle Not Protected Remove tree, No replacement required 37 9100 Fondren Road 14" Crepe Myrtle Not Protected Remove tree, No replacement required 38 9100 Fondren Road 17" Water Oak Protected Remove tree, No replacement required Remove tree, No replacement required 28 9 9100 Fondren Road 28" Live Oak Protected Remove tree, No replacement required Remove tree, No replacement required 39 9100 Fondren Road 28" Live Oak Protected Remove tree, No replacement required 39 9100 Fondren Road 31" Live Oak Protected Remove tree, No replacement required 39 9100 Fondren Road 31" Live Oak Protected Remove tree, No replacement required 39 9100 Fondren Road 31" Live Oak Protected Remove tree, No replacement required 39 9100 Fondren Road 31" Live Oak Protected Remove tree, No replacement required 39 9100 Fondren Road 31" Live Oak Protected Remove tree, No replacement required 39 9100 Fondren Road 31" Live Oak Protected Remove tree, No replacement required 39 9100 Fondren Road 28" Live Oak Protected Fence, Root prune for ditch, Clearance 39 100 Fondren Road 28" Live Oak Protected Remove tree, No replacement required 39 9100 Fondren Road 28" Live Oak Protected Remove tree, No replacement required 39 9100 Fondren Road 39" Live Oak Protected Remove tree, No replacement required 39 9100 Fondren Road 39" Live Oak Protected Remove tree, No replacement required 39 9100 Fondren Road 38" Live Oak Protected Remove tree, No replacement required 39 9100 Fondren Road 38" Live Oak Protected Remove tree, No replacement required 39 9100 Fondren Road 38" Live Oak Protected Remove tree, No replacement required 39 9100 Fondren Road 38" Live Oak Protected Remove tree, No replacement required 39 9 |          |                   |  |           | Dead                          | · · · · · · · · · · · · · · · · · · ·  |
| 33 9100 Fondren Road 34" Live Oak Protected Remove tree, No replacement required Remove tree, No replacement required 35 9100 Fondren Road 14" Crepe Myrtle Not Protected Remove tree, No replacement required 14" Crepe Myrtle Not Protected Remove tree, No replacement required Protected Remove tree, No replacement required Remove tree, No replac |          |                   |  |           |                               | · · · · · · · · · · · · · · · · · · ·  |
| 34 100 Fondren Road 34" Live Oak Protected Remove tree, No replacement required Remove tree, No replacement required 14" Crepe Myrtle Not Protected Remove tree, No replacement required Remove tree, No replacement required 15" 100 Fondren Road 14" Crepe Myrtle Not Protected Remove tree, No replacement required 18" 100 Fondren Road 17" Water Oak Protected Remove tree, No replacement required 18" 100 Fondren Road 17" Water Oak Protected Remove tree, No replacement required 19" 100 Fondren Road 28" Live Oak Protected Remove tree, No replacement required 19" 100 Fondren Road 21" Arizona Ash Protected Remove tree, No replacement required 19" 100 Fondren Road 13" Cedar Elm Protected Remove tree, No replacement required 19" 100 Fondren Road 31" Live Oak Protected Remove tree, No replacement required 19" 100 Fondren Road 31" Live Oak Protected Remove tree, No replacement required 19" 100 Fondren Road 31" Live Oak Protected Remove tree, No replacement required 19" 100 Fondren Road 31" Live Oak Protected Fence, Root prune for ditch, Clearance 19" 100 Fondren Road 18" Live Oak Protected Fence, Root prune for ditch 100 Fondren Road 18" Live Oak Protected Remove tree, No replacement required 19" 100 Fondren Road 21" Live Oak Protected Remove tree, No replacement required 19" 100 Fondren Road 21" Live Oak Protected Remove tree, No replacement required 19" 100 Fondren Road 21" Live Oak Protected Remove tree, No replacement required 19" 100 Fondren Road 21" Live Oak Protected Remove tree, No replacement required 19" 100 Fondren Road 21" Live Oak Protected Remove tree, No replacement required 19" 100 Fondren Road 21" Live Oak Protected Remove tree, No replacement required 19" 100 Fondren Road 21" Live Oak Protected Remove tree, No replacement required 19" 100 Fondren Road 22" Live Oak Protected Remove tree, No replacement required 19" 100 Fondren Road 34" Live Oak Protected Remove tree, No replacement required 19" 100 Fondren Road 34" Live Oak Protected Remove tree, No replacement required 19" 100 Fondren Road 34" Live Oak Prote |          |                   |  |           |                               | · · · · · · · · · · · · · · · · · · ·  |
| 35   9100 Fondren Road   14" Crepe Myrtle   Not Protected   Remove tree, No replacement required   Remove tree, No replacement requir   |          |                   |  |           |                               | · · · · · · · · · · · · · · · · · · ·  |
| 36   9100 Fondren Road   14" Crepe Myrtle   Not Protected   Remove tree, No replacement required   37   9100 Fondren Road   14" Crepe Myrtle   Not Protected   Remove tree, No replacement required   38   9100 Fondren Road   17" Water Oak   Protected   Remove tree, No replacement required   Remove tree, No replacement required   39   9100 Fondren Road   28" Live Oak   Protected   Remove tree, No replacement required   Remove tree, No replaceme   |          |                   |  |           |                               | · · · · · · · · · · · · · · · · · · ·  |
| 37 9100 Fondren Road   14" Crepe Myrtle   Not Protected   Remove tree, No replacement required   38 9100 Fondren Road   17" Water Oak   Protected   Remove tree, No replacement required   39 9100 Fondren Road   28" Live Oak   Protected   Remove tree, No replacement required   40 9100 Fondren Road   21" Arizona Ash   Protected   Remove tree, No replacement required   41 9100 Fondren Road   13" Cedar Elm   Protected   Remove tree, No replacement required   42 9100 Fondren Road   31" Live Oak   Protected   Remove tree, No replacement required   43 9100 Fondren Road   9" Live Oak   Protected   Remove tree, No replacement required   44 9100 Fondren Road   26" Live Oak   Protected   Fence, Root prune for ditch, Clearance   44 9100 Fondren Road   18" Live Oak   Protected   Fence, Root prune for ditch   45 9100 Fondren Road   21" Live Oak   Protected   Remove tree, No replacement required   47 9100 Fondren Road   21" Live Oak   Protected   Remove tree, No replacement required   48 9100 Fondren Road   39" Live Oak   Protected   Remove tree, No replacement required   48 9100 Fondren Road   21" Arizona Ash   Protected   Remove tree, No replacement required   49 9100 Fondren Road   28" Live Oak   Protected   Remove tree, No replacement required   50 9100 Fondren Road   43" Live Oak   Protected   Remove tree, No replacement required   51 9100 Fondren Road   38" Live Oak   Protected   Remove tree, No replacement required   52 9100 Fondren Road   38" Live Oak   Protected   Remove tree, No replacement required   53 9100 Fondren Road   38" Citonwood   Protected   Remove tree, No replacement required   54 9100 Fondren Road   38" Citonwood   Protected   Remove tree, No replacement required   55 9100 Fondren Road   24" Live Oak   Protected   Remove tree, No replacement required   56 9100 Fondren Road   25" Live Oak   Protected   Remove tree, No replacement required   56 9100 Fondren Road   25" Live Oak   Protected   Remove tree, No replacement required   56 9100 Fondren Road   25" Live Oak   Protected   Remove tree, No replacemen   |          |                   | · · · · · · · · · · · · · · · · · · ·            |           |                               |  |
| 9100 Fondren Road 17" Water Oak Protected Remove tree, No replacement required Protected Remove tree, No replacement required Protected Remove tree, No replacement required Remove tree, No replace |          |                   | <u> </u>   |           |                               |  |
| 9100 Fondren Road 28" Live Oak Protected Remove tree, No replacement required 40 9100 Fondren Road 21" Arizona Ash Protected Remove tree, No replacement required 41 9100 Fondren Road 31" Live Oak Protected Remove tree, No replacement required 42 9100 Fondren Road 9" Live Oak Protected Fence, Root prune for ditch, Clearance 44 9100 Fondren Road 26" Live Oak Protected Fence, Root prune for ditch 45 9100 Fondren Road 18" Live Oak Protected Fence, Root prune for ditch 46 9100 Fondren Road 21" Live Oak Protected Remove tree, No replacement required 47 9100 Fondren Road 39" Live Oak Protected Remove tree, No replacement required 48 9100 Fondren Road 21" Arizona Ash Protected Remove tree, No replacement required 49 9100 Fondren Road 21" Arizona Ash Protected Remove tree, No replacement required 50 9100 Fondren Road 28" Live Oak Protected Remove tree, No replacement required 51 9100 Fondren Road 38" Live Oak Protected Remove tree, No replacement required 52 9100 Fondren Road 38" Live Oak Protected Remove tree, No replacement required 53 9100 Fondren Road 38" Live Oak Protected Remove tree, No replacement required 54 9100 Fondren Road 38" Live Oak Protected Remove tree, No replacement required 55 9100 Fondren Road 37" Live Oak Protected Remove tree, No replacement required 56 9100 Fondren Road 27" Live Oak Protected Remove tree, No replacement required 57 9100 Fondren Road 38" Live Oak Protected Remove tree, No replacement required 58 9100 Fondren Road 38" Cottonwood Protected Remove tree, No replacement required 58 9100 Fondren Road 22" Live Oak Protected Remove tree, No replacement required 58 9100 Fondren Road 22" Live Oak Protected Remove tree, No replacement required 59 9100 Fondren Road 22" Live Oak Protected Remove for storm Remove tree, No replacement required 59 9100 Fondren Road 22" Live Oak Protected Remove for storm Remove tree, No replacement required 59 9100 Fondren Road 22" Live Oak Protected Fence, Root prune for ditch, Clearance 59 9100 Fondren Road 25" Live Oak Protected Fence, Root prune for ditch, Cl |          |                   |  |           |                               | · · · · · · · · · · · · · · · · · · ·  |
| 40 9100 Fondren Road 21" Arizona Ash Protected Remove tree, No replacement required R |          |                   |  |           |                               | · · · · · · · · · · · · · · · · · · ·  |
| 41 9100 Fondren Road 13" Cedar Elm Protected Remove tree, No replacement required 42 9100 Fondren Road 31" Live Oak Protected Fence, Root prune for ditch, Clearance 43 9100 Fondren Road 26" Live Oak Protected Fence, Root prune for ditch Clearance 44 9100 Fondren Road 18" Live Oak Protected Fence, Root prune for ditch Fence, Root prune for ditch, Clearance Fence, Root prune for ditch,  |          |                   |  |           |                               |  |
| 42 9100 Fondren Road 31" Live Oak Protected Remove tree, No replacement required 43 9100 Fondren Road 9" Live Oak Protected Fence, Root prune for ditch, Clearance 44 9100 Fondren Road 26" Live Oak Protected Fence, Root prune for ditch 45 9100 Fondren Road 18" Live Oak Protected Fence, Root prune for ditch 46 9100 Fondren Road 21" Live Oak Protected Remove tree, No replacement required 47 9100 Fondren Road 39" Live Oak Protected Remove tree, No replacement required 48 9100 Fondren Road 21" Arizona Ash Protected Remove tree, No replacement required 49 9100 Fondren Road 28" Live Oak Protected Remove tree, No replacement required 50 9100 Fondren Road 43" Live Oak Protected Remove tree, No replacement required 51 9100 Fondren Road 38" Live Oak Protected Remove tree, No replacement required 52 9100 Fondren Road 38" Live Oak Protected Remove tree, No replacement required 53 9100 Fondren Road 38" Live Oak Protected Remove tree, No replacement required 54 9100 Fondren Road 34" Live Oak Protected Remove tree, No replacement required 55 9100 Fondren Road 34" Live Oak Protected Remove tree, No replacement required 56 9100 Fondren Road 38" Cottonwood Protected Dead Remove tree, No replacement required 57 9100 Fondren Road 24" Live Oak Protected Remove for storm Remove tree, No replacement required 58 9100 Fondren Road 22" Live Oak Protected Fence, Root prune for ditch, Clearance 59 9100 Fondren Road 23" Live Oak Protected Fence, Root prune for ditch, Clearance 59 9100 Fondren Road 25" Live Oak Protected Fence, Root prune for ditch, Clearance   |          |                   |  |           |                               | <u>'</u>                               |
| 43 9100 Fondren Road 9" Live Oak Protected Fence, Root prune for ditch, Clearance 44 9100 Fondren Road 26" Live Oak Protected Fence, Root prune for ditch 45 9100 Fondren Road 16" Live Oak Protected Remove tree, No replacement required 47 9100 Fondren Road 21" Live Oak Protected Remove tree, No replacement required 48 9100 Fondren Road 21" Arizona Ash Protected Remove tree, No replacement required 49 9100 Fondren Road 28" Live Oak Protected Remove tree, No replacement required 50 9100 Fondren Road 38" Live Oak Protected Remove tree, No replacement required 51 9100 Fondren Road 38" Live Oak Protected Remove tree, No replacement required 52 9100 Fondren Road 38" Live Oak Protected Remove tree, No replacement required 53 9100 Fondren Road 37" Live Oak Protected Remove tree, No replacement required 54 9100 Fondren Road 34" Live Oak Protected Remove tree, No replacement required 55 9100 Fondren Road 38" Cottonwood Protected Remove tree, No replacement required 56 9100 Fondren Road 24" Live Oak Protected Dead Remove tree, No replacement required 57 9100 Fondren Road 24" Live Oak Protected Remove for storm Remove tree, No replacement required 58 9100 Fondren Road 25" Live Oak Protected Remove for storm Remove tree, No replacement required 58 9100 Fondren Road 22" Live Oak Protected Remove for storm Remove tree, No replacement required 58 9100 Fondren Road 22" Live Oak Protected Fence, Root prune for ditch, Clearance 59 9100 Fondren Road 25" Live Oak Protected Fence, Root prune for ditch, Clearance 59 9100 Fondren Road 25" Live Oak Protected Fence, Root prune for ditch, Clearance 59 9100 Fondren Road 25" Live Oak Protected Fence, Root prune for ditch, Clearance   |          |                   |  |           |                               |  |
| 44 9100 Fondren Road 26" Live Oak Protected Fence, Root prune for ditch 45 9100 Fondren Road 18" Live Oak Protected Remove tree, No replacement required 46 9100 Fondren Road 39" Live Oak Protected Remove tree, No replacement required 47 9100 Fondren Road 21" Arizona Ash Protected Remove tree, No replacement required 48 9100 Fondren Road 28" Live Oak Protected Remove tree, No replacement required 50 9100 Fondren Road 43" Live Oak Protected Remove tree, No replacement required 51 9100 Fondren Road 38" Live Oak Protected Remove tree, No replacement required 52 9100 Fondren Road 38" Live Oak Protected Remove tree, No replacement required 53 9100 Fondren Road 27" Live Oak Protected Remove tree, No replacement required 54 9100 Fondren Road 34" Live Oak Protected Remove tree, No replacement required 55 9100 Fondren Road 38" Cottonwood Protected Dead Remove tree, No replacement required 56 9100 Fondren Road 24" Live Oak Protected Remove tree, No replacement required 57 9100 Fondren Road 24" Live Oak Protected Remove tree, No replacement required 58 9100 Fondren Road 25" Live Oak Protected Remove for storm Remove tree, No replacement required 59 9100 Fondren Road 22" Live Oak Protected Fence, Root prune for ditch, Clearance 59 9100 Fondren Road 23" Live Oak Protected Fence, Root prune for ditch, Clearance 59 9100 Fondren Road 25" Live Oak Protected Fence, Root prune for ditch, Clearance   |          |                   |  |           |                               |  |
| 45 9100 Fondren Road 18" Live Oak Protected Remove tree, No replacement required 46 9100 Fondren Road 21" Live Oak Protected Remove tree, No replacement required 47 9100 Fondren Road 39" Live Oak Protected Remove tree, No replacement required 48 9100 Fondren Road 21" Arizona Ash Protected Remove tree, No replacement required 49 9100 Fondren Road 28" Live Oak Protected Remove tree, No replacement required 50 9100 Fondren Road 43" Live Oak Protected Remove tree, No replacement required 51 9100 Fondren Road 38" Live Oak Protected Remove tree, No replacement required 52 9100 Fondren Road 27" Live Oak Protected Remove tree, No replacement required 53 9100 Fondren Road 34" Live Oak Protected Remove tree, No replacement required 54 9100 Fondren Road 34" Live Oak Protected Remove tree, No replacement required 55 9100 Fondren Road 38" Cottonwood Protected Dead Remove tree, No replacement required 56 9100 Fondren Road 24" Live Oak Protected Remove for storm Remove tree, No replacement required 57 9100 Fondren Road 19" Live Oak Protected Remove for storm Remove tree, No replacement required 58 9100 Fondren Road 22" Live Oak Protected Fence, Root prune for ditch, Clearance 59 9100 Fondren Road 23" Live Oak Protected Fence, Root prune for ditch, Clearance 59 9100 Fondren Road 23" Live Oak Protected Fence, Root prune for ditch, Clearance  |          |                   |  |           |                               | · · · · · · · · · · · · · · · · · · ·  |
| 46 9100 Fondren Road 21" Live Oak Protected Remove tree, No replacement required 47 9100 Fondren Road 39" Live Oak Protected Remove tree, No replacement required 48 9100 Fondren Road 21" Arizona Ash Protected Remove tree, No replacement required 49 9100 Fondren Road 28" Live Oak Protected Remove tree, No replacement required 50 9100 Fondren Road 43" Live Oak Protected Remove tree, No replacement required 51 9100 Fondren Road 38" Live Oak Protected Remove tree, No replacement required 52 9100 Fondren Road 27" Live Oak Protected Remove tree, No replacement required 53 9100 Fondren Road 34" Live Oak Protected Remove tree, No replacement required 54 9100 Fondren Road 38" Cottonwood Protected Remove tree, No replacement required 55 9100 Fondren Road 38" Cottonwood Protected Dead Remove tree, No replacement required 56 9100 Fondren Road 24" Live Oak Protected Remove for storm Remove tree, No replacement required 57 9100 Fondren Road 24" Live Oak Protected Remove for storm Remove tree, No replacement required 58 9100 Fondren Road 22" Live Oak Protected Remove for storm Remove tree, No replacement required 59 9100 Fondren Road 22" Live Oak Protected Remove for storm Remove tree, No replacement required 59 9100 Fondren Road 22" Live Oak Protected Fence, Root prune for ditch, Clearance 59 9100 Fondren Road 23" Live Oak Protected Fence, Root prune for ditch, Clearance 59 9100 Fondren Road 25" Live Oak Protected Fence, Root prune for ditch, Clearance   |          |                   |  |           |                               |  |
| 47 9100 Fondren Road 39" Live Oak Protected Remove tree, No replacement required Remo |          |                   |  |           |                               | •                                      |
| 48 9100 Fondren Road 21" Arizona Ash Protected Remove tree, No replacement required 28" Live Oak Protected Remove tree, No replacement required 30 9100 Fondren Road 43" Live Oak Protected Remove tree, No replacement required 31 9100 Fondren Road 38" Live Oak Protected Remove tree, No replacement required 32 9100 Fondren Road 27" Live Oak Protected Remove tree, No replacement required 33 9100 Fondren Road 34" Live Oak Protected Remove tree, No replacement required 34 9100 Fondren Road 38" Cottonwood Protected Dead Remove tree, No replacement required 35 9100 Fondren Road 38" Cottonwood Protected Dead Remove tree, No replacement required 35 9100 Fondren Road 24" Live Oak Protected Remove for storm Remove tree, No replacement required 36 9100 Fondren Road 19" Live Oak Protected Remove for storm Remove tree, No replacement required 36 9100 Fondren Road 22" Live Oak Protected Remove for storm Remove tree, No replacement required 37 9100 Fondren Road 22" Live Oak Protected Fence, Root prune for ditch, Clearance 38 9100 Fondren Road 23" Live Oak Protected Fence, Root prune for ditch, Clearance 39 9100 Fondren Road 25" Live Oak Protected Fence, Root prune for ditch, Clearance   |          |                   |  |           |                               |  |
| 49 9100 Fondren Road 28" Live Oak Protected Remove tree, No replacement required 50 9100 Fondren Road 43" Live Oak Protected Remove tree, No replacement required 51 9100 Fondren Road 38" Live Oak Protected Remove tree, No replacement required 52 9100 Fondren Road 27" Live Oak Protected Remove tree, No replacement required 53 9100 Fondren Road 34" Live Oak Protected Remove tree, No replacement required 54 9100 Fondren Road 38" Cottonwood Protected Dead Remove tree, No replacement required 55 9100 Fondren Road 24" Live Oak Protected Remove for storm Remove tree, No replacement required 56 9100 Fondren Road 24" Live Oak Protected Remove for storm Remove tree, No replacement required 57 9100 Fondren Road 19" Live Oak Protected Fence, Root prune for ditch, Clearance 58 9100 Fondren Road 22" Live Oak Protected Fence, Root prune for ditch, Clearance 59 9100 Fondren Road 23" Live Oak Protected Fence, Root prune for ditch, Clearance 59 9100 Fondren Road 25" Live Oak Protected Fence, Root prune for ditch, Clearance   |          |                   |  |           |                               | · · · · · · · · · · · · · · · · · · ·  |
| So   9100 Fondren Road   43" Live Oak   Protected   Remove tree, No replacement required   | <u> </u> |                   |  |           |                               |  |
| 51 9100 Fondren Road 38" Live Oak Protected Remove tree, No replacement required 52 9100 Fondren Road 27" Live Oak Protected Remove tree, No replacement required 53 9100 Fondren Road 34" Live Oak Protected Remove tree, No replacement required 54 9100 Fondren Road 38" Cottonwood Protected Dead Remove tree, No replacement required 55 9100 Fondren Road 24" Live Oak Protected Remove for storm Remove tree, No replacement required 56 9100 Fondren Road 19" Live Oak Protected Remove for storm Remove tree, No replacement required 56 9100 Fondren Road 19" Live Oak Protected Fence, Root prune for ditch, Clearance 57 9100 Fondren Road 22" Live Oak Protected Fence, Root prune for ditch, Clearance 58 9100 Fondren Road 23" Live Oak Protected Fence, Root prune for ditch, Clearance 59 9100 Fondren Road 25" Live Oak Protected Fence, Root prune for ditch, Clearance  |          |                   |  |           |                               | · · · · · · · · · · · · · · · · · · ·  |
| 529100 Fondren Road27" Live OakProtectedRemove tree, No replacement required539100 Fondren Road34" Live OakProtectedRemove tree, No replacement required549100 Fondren Road38" CottonwoodProtectedDeadRemove tree, No replacement required559100 Fondren Road24" Live OakProtectedRemove for stormRemove tree, No replacement required569100 Fondren Road19" Live OakProtectedFence, Root prune for ditch, Clearance579100 Fondren Road22" Live OakProtectedFence, Root prune for ditch, Clearance589100 Fondren Road23" Live OakProtectedFence, Root prune for ditch, Clearance599100 Fondren Road25" Live OakProtectedFence  |          |                   |  |           |                               |  |
| 9100 Fondren Road 34" Live Oak Protected Dead Remove tree, No replacement required 54 9100 Fondren Road 38" Cottonwood Protected Dead Remove tree, No replacement required 55 9100 Fondren Road 24" Live Oak Protected Remove for storm Remove tree, No replacement required 56 9100 Fondren Road 19" Live Oak Protected Fence, Root prune for ditch, Clearance 57 9100 Fondren Road 22" Live Oak Protected Fence, Root prune for ditch, Clearance 58 9100 Fondren Road 23" Live Oak Protected Fence, Root prune for ditch, Clearance 59 9100 Fondren Road 25" Live Oak Protected Fence, Root prune for ditch, Clearance Fence, Root prune for ditch, Clearance  |          |                   |  |           |                               | · · · · · · · · · · · · · · · · · · ·  |
| 549100 Fondren Road38" CottonwoodProtectedDeadRemove tree, No replacement required559100 Fondren Road24" Live OakProtectedRemove for stormRemove tree, No replacement required569100 Fondren Road19" Live OakProtectedFence, Root prune for ditch, Clearance579100 Fondren Road22" Live OakProtectedFence, Root prune for ditch, Clearance589100 Fondren Road23" Live OakProtectedFence, Root prune for ditch, Clearance599100 Fondren Road25" Live OakProtectedFence  |          |                   |  |           |                               | · · · · · · · · · · · · · · · · · · ·  |
| 559100 Fondren Road24" Live OakProtectedRemove for stormRemove tree, No replacement required569100 Fondren Road19" Live OakProtectedFence, Root prune for ditch, Clearance579100 Fondren Road22" Live OakProtectedFence, Root prune for ditch, Clearance589100 Fondren Road23" Live OakProtectedFence, Root prune for ditch, Clearance599100 Fondren Road25" Live OakProtectedFence  |          |                   |  |           | D I                           | · ·                                    |
| 569100 Fondren Road19" Live OakProtectedFence, Root prune for ditch, Clearance579100 Fondren Road22" Live OakProtectedFence, Root prune for ditch, Clearance589100 Fondren Road23" Live OakProtectedFence, Root prune for ditch, Clearance599100 Fondren Road25" Live OakProtectedFence  |          |                   |  |           |                               | •                                      |
| 579100 Fondren Road22" Live OakProtectedFence, Root prune for ditch, Clearance589100 Fondren Road23" Live OakProtectedFence, Root prune for ditch, Clearance599100 Fondren Road25" Live OakProtectedFence  |          |                   | <u> </u>   |           | Remove for storm              | · · · · · · · · · · · · · · · · · · ·  |
| 589100 Fondren Road23" Live OakProtectedFence, Root prune for ditch, Clearance599100 Fondren Road25" Live OakProtectedFence  |          |                   |  |           |                               | <u> </u>                               |
| 59 9100 Fondren Road 25" Live Oak Protected Fence  |          |                   |  |           |                               | ·                                      |
|  |          |                   |  |           |                               |  |
| 60 9100 Fondren Road 26" Live Oak Protected Fence  |          |                   |  |           |                               |  |
|  | 60       | 9100 Fondren Road | 26" Live Oak                                     | Protected |                               | Fence                                  |

| ree |                   |                  | Chapter 33    |             |  |
|-----|-------------------|------------------|---------------|-------------|--|
|     | Location          | Description      | Status        | Comments    | Treatment                              |
|     | 9100 Fondren Road | 23" Live Oak     | Protected     |             | Fence                                  |
|     | 9100 Fondren Road | 28" Arizona Ash  | Protected     | 90% Dieback |  |
|     | 9100 Fondren Road | 28" Arizona Ash  | Protected     | 90% Dieback | Fence                                  |
|     | 9100 Fondren Road | 12" Sugarberry   | Not Protected |             | Fence                                  |
|     | 9100 Fondren Road | 9" Sugarberry    | Not Protected |             | Fence                                  |
|     | 9100 Fondren Road | 15" Sugarberry   | Not Protected |             | Fence                                  |
|     | 9100 Fondren Road | 17" Sugarberry   | Not Protected |             | Fence                                  |
|     | 9100 Fondren Road | 18" Sugarberry   | Not Protected |             | Fence                                  |
|     | 9100 Fondren Road | 14" Sugarberry   | Not Protected |             | Fence                                  |
|     | 9100 Fondren Road | 16" Sugarberry   | Not Protected |             | Fence                                  |
|     | 9100 Fondren Road | 15" Sugarberry   | Not Protected |             | Fence                                  |
|     |                   | 20" Green Ash    | Protected     |             |  |
|     | 9100 Fondren Road |                  |               |             | Remove tree, No replacement required   |
|     | 9100 Fondren Road | 25" Green Ash    | Protected     | Dood        | Remove tree, No replacement required   |
|     | 9100 Fondren Road | 25" Arizona Ash  | Protected     | Dead        | Remove tree, No replacement required   |
|     | 9100 Fondren Road | 34" Arizona Ash  | Protected     |             | Remove tree, No replacement required   |
|     | 9100 Fondren Road | 23" Arizona Ash  | Protected     |             | Remove tree, No replacement required   |
|     | 9100 Fondren Road | 25" Green Ash    | Protected     |             | Remove tree, No replacement required   |
|     | 9100 Fondren Road | 24" Arizona Ash  | Protected     | Dead        | Remove tree, No replacement required   |
|     | 9100 Fondren Road | 28" Arizona Ash  | Protected     |             | Remove tree, No replacement required   |
|     | 9100 Fondren Road | 32" Arizona Ash  | Protected     |             | Remove tree, No replacement required   |
| 81  | 9100 Fondren Road | 33" Live Oak     | Protected     |             | Remove tree, No replacement required   |
| 82  | 9100 Fondren Road | 27" Live Oak     | Protected     |             | Fence, Root prune for ditch, Clearance |
| 83  | 9100 Fondren Road | 25" Live Oak     | Protected     |             | Fence, Root prune for ditch, Clearance |
| 84  | 9100 Fondren Road | 23" Arizona Ash  | Protected     |             | Remove tree, No replacement required   |
| 85  | 9100 Fondren Road | 31" Arizona Ash  | Protected     |             | Remove tree, No replacement required   |
| 86  | 9100 Fondren Road | 35" Arizona Ash  | Protected     |             | Remove tree, No replacement required   |
| 87  | 9100 Fondren Road | 22" Arizona Ash  | Protected     |             | Remove tree, No replacement required   |
| 88  | 9100 Fondren Road | 14" Cedar Elm    | Protected     |             | Remove tree, No replacement required   |
|     | 9100 Fondren Road | 31" Willow Oak   | Protected     |             | Remove tree, No replacement required   |
|     | 9100 Fondren Road | 22" Live Oak     | Protected     |             | Remove tree, No replacement required   |
|     | 9100 Fondren Road | 9" Cedar Elm     | Protected     |             | Remove tree, No replacement required   |
|     | 9100 Fondren Road | 25" Live Oak     | Protected     |             | Remove tree, No replacement required   |
|     | 9100 Fondren Road | 11" Cedar Elm    | Protected     |             | Remove tree, No replacement required   |
|     | 9100 Fondren Road | 16" Sugarberry   | Not Protected |             | Remove tree, No replacement required   |
|     |                   |                  | Not Protected |             | · · · · · · · · · · · · · · · · · · ·  |
|     | 9100 Fondren Road | 13" Sugarberry   | Not Protected |             | Remove tree, No replacement required   |
|     | 9100 Fondren Road | 11" Sugarberry   |               |             | Remove tree, No replacement required   |
|     | 9100 Fondren Road | 18" Sugarberry   | Not Protected |             | Remove tree, No replacement required   |
|     | 9100 Fondren Road | 9" Sugarberry    | Not Protected |             | Remove tree, No replacement required   |
|     | 9100 Fondren Road | 17" Arizona Ash  | Not Protected |             | Remove tree, No replacement required   |
|     | 9100 Fondren Road | 14" Arizona Ash  | Not Protected |             | Remove tree, No replacement required   |
|     | 9100 Fondren Road | 13" Arizona Ash  | Not Protected |             | Remove tree, No replacement required   |
|     | 9100 Fondren Road | 18" Arizona Ash  | Not Protected |             | Remove tree, No replacement required   |
|     | 9100 Fondren Road | 12" Sugarberry   | Not Protected |             | Remove tree, No replacement required   |
|     | 9100 Fondren Road | 11" Sugarberry   | Not Protected |             | Remove tree, No replacement required   |
|     | 9100 Fondren Road | 11" Crepe Myrtle | Not Protected |             | Fence                                  |
| 106 | 9100 Fondren Road | 16" Arizona Ash  | Not Protected |             | Fence                                  |
| 107 | 9100 Fondren Road | 21" Live Oak     | Protected     |             | Fence                                  |
| 108 | 9100 Fondren Road | 7" Sugarberry    | Not Protected |             | Fence                                  |
| 109 | 9100 Fondren Road | 6" Sugarberry    | Not Protected |             | Fence                                  |
| 110 | 9100 Fondren Road | 13" Arizona Ash  | Not Protected |             | Fence                                  |
|     | 9100 Fondren Road | 13" Arizona Ash  | Not Protected |             | Fence                                  |
|     | 9100 Fondren Road | 11" Arizona Ash  | Not Protected |             | Fence                                  |
|     | 9100 Fondren Road | 15" Arizona Ash  | Not Protected |             | Fence                                  |
|     | 9100 Fondren Road | 10" Arizona Ash  | Not Protected |             | Fence                                  |
|     | 9100 Fondren Road | 7" Arizona Ash   | Not Protected |             | Fence                                  |
|     | 9100 Fondren Road | 8" Arizona Ash   | Not Protected |             | Fence                                  |
|     |                   | 6" Arizona Ash   | Not Protected |             | Fence                                  |
|     | 9100 Fondren Road |                  |               |             |  |
|     | 9100 Fondren Road | 5" Arizona Ash   | Not Protected |             | Fence                                  |
|     | 9100 Fondren Road | 17" Arizona Ash  | Not Protected |             | Remove tree, No replacement required   |
| 120 | 9100 Fondren Road | 9" Arizona Ash   | Not Protected |             | Remove tree, No replacement required   |



210 Stone Bush Ct. • Katy, Texas 77493 281-391-0022 ckoehl@koehlurbanforestry.com

APPROVED:

15021 KATY FREEWAY, STE. 500 HOUSTON, TX. 77094 281-945-0069 TX FIRM NUMBER: F-6932 SURVEYED BY: LANDTECH, INC. FB NO. P-6331

# CITY OF HOUSTON HOUSTON PUBLIC WORKS

SHARPSTOWN AREA DETENTION POND A

TREE PROTECTION PLAN

SHEET 2 OF 3

|                      | 311LL1 2 01 0  |
|----------------------|--|
| WBS NUMBER           | FOR CITY OF HOUSTON USE ONLY   |
| M-410040-001A-3      |  |
| DRAWING SCALE        |  |
| AS NOTED             |  |
| CITY OF HOUSTON PM   |  |
| SUPUN ILANGAMUDALIGE |  |
| SHEET NO. 30 OF 42   |  |
|                      | M-410040-001A-3  DRAWING SCALE  AS NOTED  CITY OF HOUSTON PM  SUPUN ILANGAMUDALIGE |

| ree No. 🗆 | Location          | Description                           | Replacement requiremen |
|-----------|-------------------|---------------------------------------|------------------------|
|           | 9100 Fondren Road | 22" Arizona Ash                       | 0                      |
|           | 9100 Fondren Road | 15" Bradford Pear                     | 0                      |
|           | 9100 Fondren Road | 10" Holly                             | 0                      |
|           | 9100 Fondren Road | 9" Holly                              | 0                      |
|           | 9100 Fondren Road | 8" Arizona Ash                        | 0                      |
|           | 9100 Fondren Road | 21" Cedar Elm                         |                        |
|           | 9100 Fondren Road | 25" Arizona Ash                       | 0                      |
|           |                   |                                       | 0                      |
|           | 9100 Fondren Road | 12" Arizona Ash                       | 0                      |
|           | 9100 Fondren Road | 39" Arizona Ash                       | 0                      |
|           | 9100 Fondren Road | 24" Arizona Ash                       | 0                      |
| 33        | 9100 Fondren Road | 21" Cedar Elm                         | 0                      |
|           | 9100 Fondren Road | 34" Live Oak                          | 0                      |
|           | 9100 Fondren Road | 14" Crepe Myrtle                      | 0                      |
|           | 9100 Fondren Road | 14" Crepe Myrtle                      |                        |
|           | 9100 Fondren Road | 14" Crepe Myrtle                      | 0                      |
|           |                   | , , , , , , , , , , , , , , , , , , , | 0                      |
|           | 9100 Fondren Road | 17" Water Oak                         | 0                      |
|           | 9100 Fondren Road | 28" Live Oak                          | 0                      |
|           | 9100 Fondren Road | 21" Arizona Ash                       | 0                      |
| 41        | 9100 Fondren Road | 13" Cedar Elm                         | 0                      |
|           | 9100 Fondren Road | 31" Live Oak                          | 0                      |
|           | 9100 Fondren Road | 21" Live Oak                          | 0                      |
|           | 9100 Fondren Road | 39" Live Oak                          |                        |
|           |                   |                                       | 0                      |
|           | 9100 Fondren Road | 21" Arizona Ash                       | 0                      |
|           | 9100 Fondren Road | 28" Live Oak                          | 0                      |
|           | 9100 Fondren Road | 43" Live Oak                          | 0                      |
|           | 9100 Fondren Road | 38" Live Oak                          | 0                      |
| 52        | 9100 Fondren Road | 27" Live Oak                          | 0                      |
| 53        | 9100 Fondren Road | 34" Live Oak                          | 0                      |
|           | 9100 Fondren Road | 38" Cottonwood                        | 0                      |
|           | 9100 Fondren Road | 24" Live Oak                          |                        |
|           | 9100 Fondren Road | 20" Green Ash                         | 0                      |
| · -       |                   |                                       | 0                      |
|           | 9100 Fondren Road | 25" Green Ash                         | 0                      |
|           | 9100 Fondren Road | 25" Arizona Ash                       | 0                      |
| 75        | 9100 Fondren Road | 34" Arizona Ash                       | 0                      |
| 76        | 9100 Fondren Road | 23" Arizona Ash                       | 0                      |
|           | 9100 Fondren Road | 25" Green Ash                         | 0                      |
|           | 9100 Fondren Road | 24" Arizona Ash                       | 0                      |
|           | 9100 Fondren Road | 28" Arizona Ash                       | ·                      |
|           |                   |                                       | 0                      |
|           | 9100 Fondren Road | 32" Arizona Ash                       | 0                      |
|           | 9100 Fondren Road | 33" Live Oak                          | 0                      |
| • .       | 9100 Fondren Road | 23" Arizona Ash                       | 0                      |
| 85        | 9100 Fondren Road | 31" Arizona Ash                       | 0                      |
|           | 9100 Fondren Road | 35" Arizona Ash                       | 0                      |
|           | 9100 Fondren Road | 22" Arizona Ash                       | 0                      |
|           | 9100 Fondren Road | 14" Cedar Elm                         | 0                      |
|           | 9100 Fondren Road | 31" Willow Oak                        |                        |
|           |                   |                                       | 0                      |
|           | 9100 Fondren Road | 22" Live Oak                          | 0                      |
|           | 9100 Fondren Road | 9" Cedar Elm                          | 0                      |
|           | 9100 Fondren Road | 25" Live Oak                          | 0                      |
|           | 9100 Fondren Road | 11" Cedar Elm                         | 0                      |
| 94        | 9100 Fondren Road | 16" Sugarberry                        | 0                      |
| • .       | 9100 Fondren Road | 13" Sugarberry                        | 0                      |
|           | 9100 Fondren Road | 11" Sugarberry                        | 0                      |
|           | 9100 Fondren Road | 18" Sugarberry                        |                        |
|           |                   |                                       | 0                      |
|           | 9100 Fondren Road | 9" Sugarberry                         | 0                      |
|           | 9100 Fondren Road | 17" Arizona Ash                       | 0                      |
|           | 9100 Fondren Road | 14" Arizona Ash                       | 0                      |
|           | 9100 Fondren Road | 13" Arizona Ash                       | 0                      |
|           | 9100 Fondren Road | 18" Arizona Ash                       | 0                      |
|           | 9100 Fondren Road | 12" Sugarberry                        | 0                      |
|           | 9100 Fondren Road | 11" Sugarberry                        |                        |
|           | 9100 Fondren Road | 17" Arizona Ash                       | 0                      |
|           |                   |                                       | 0                      |
|           | 9100 Fondren Road | 9" Arizona Ash                        | 0                      |
|           | 9100 Fondren Road | 11" Arizona Ash                       | 0                      |

#### TOTAL REPLACEMENT INCHES REQUIRED

|          |                  | Tree Replacement List |                           |
|----------|------------------|-----------------------|---------------------------|
| Quantity | Caliper Size     | Species               | Container/Tree Spade size |
|          |                  |                       |                           |
|          | TOTAL REPLACEMEN | 0                     |                           |

NOTE: Tree replacement locations are not shown on plans. Contractor must coordinate with City of Houston Urban Forestry and Houston Public Works prior to PURCHASING trees. This project may not have adequate room for all required replacement trees without creating regulatory sign or traffic/pedestrian visibility issues. Number of trees and planting locations will be determined by City of Houston Urban Forestry in construction phase. Trees that are planted are to be maintained and watered for 2 years following planting per standard spec 02915. Timing of planting may be delayed in periods of drought with mandatory water restrictions in place-timing to be coordinated with City of Houston Urban Forestry. Trees in esplanade groupings to be planted in common bed with 4" of hardwood mulch between trees.

Trees are to be maintained and watered for 2 years following planting per standard spec 02915. Timing of planting may be delayed in periods of drought with mandatory water restrictions in place-timing to be coordinated with City of Houston Forestry.

Tree replacement locations shall comply with Houston Public Works spec sections 02811, 02911, 02912, 02915, 02921 & 02922. In general trees along sides of street right of ways shall be no closer than 3' to back of curb or 20' from another tree. Trees in medians shall be no closer than 6' back of curb, 75' from an intersection, 50' to a median cut, or 20' from another tree. Contractor to coordinate locations with City Forestry and HPW prior to PURCHASING trees. All replacement trees called out on plans may not be planted on project relative to coordination with listed parties.


## Cash Allowance Due Parks from HPW for Balance of Mitigation Not **Planted on Project**

|          | Required Mitigation total | Mitigation rate/inch          |      |
|----------|---------------------------|-------------------------------|------|
| 0-5.99"  |                           | \$ 297.98                     | \$ - |
| 6-11.99" |                           | 496.64                        | \$ - |
| 12" +    |                           | 662.19                        | \$ - |
|          |                           | TOTAL REQUIRED MITIGATION FEE | -    |


| ree No. | Location          | Description     |
|---------|-------------------|-----------------|
| 5       | 9100 Fondren Road | 37" Arizona Ash |
| 19      | 9100 Fondren Road | 37" Live Oak    |
| 29      | 9100 Fondren Road | 25" Arizona Ash |
| 31      | 9100 Fondren Road | 39" Arizona Ash |
| 32      | 9100 Fondren Road | 24" Arizona Ash |
| 34      | 9100 Fondren Road | 34" Live Oak    |
| 39      | 9100 Fondren Road | 28" Live Oak    |
| 42      | 9100 Fondren Road | 31" Live Oak    |
| 44      | 9100 Fondren Road | 26" Live Oak    |
| 47      | 9100 Fondren Road | 39" Live Oak    |
| 49      | 9100 Fondren Road | 28" Live Oak    |
| 50      | 9100 Fondren Road | 43" Live Oak    |
| 51      | 9100 Fondren Road | 38" Live Oak    |
| 52      | 9100 Fondren Road | 27" Live Oak    |
| 53      | 9100 Fondren Road | 34" Live Oak    |
| 54      | 9100 Fondren Road | 38" Cottonwood  |
| 55      | 9100 Fondren Road | 24" Live Oak    |
| 59      | 9100 Fondren Road | 25" Live Oak    |
| 60      | 9100 Fondren Road | 26" Live Oak    |
| 62      | 9100 Fondren Road | 28" Arizona Ash |
| 63      | 9100 Fondren Road | 28" Arizona Ash |
| 73      | 9100 Fondren Road | 25" Green Ash   |
| 74      | 9100 Fondren Road | 25" Arizona Ash |
|         | 9100 Fondren Road | 34" Arizona Ash |
| 77      | 9100 Fondren Road | 25" Green Ash   |
| 78      | 9100 Fondren Road | 24" Arizona Ash |
| 79      | 9100 Fondren Road | 28" Arizona Ash |
| 80      | 9100 Fondren Road | 32" Arizona Ash |
| 81      | 9100 Fondren Road | 33" Live Oak    |
| 82      | 9100 Fondren Road | 27" Live Oak    |
| 83      | 9100 Fondren Road | 25" Live Oak    |
| 85      | 9100 Fondren Road | 31" Arizona Ash |
| 86      | 9100 Fondren Road | 35" Arizona Ash |
| 89      | 9100 Fondren Road | 31" Willow Oak  |
| 92      | 9100 Fondren Road | 25" Live Oak    |
|         | İ                 |                 |

as Arboriculturally Significant are identified here and/or in treatment schedule included on TPP sheets. Arboriculturally Significant trees are to be pruned under direct supervision of City of Houston Forestry. Minimal pruning will be allowed for construction equipment access, and in some cases no pruning will be allowed. Contractor must review conditions around and/or under the canopy of Arboriculturally Significant trees and consider restrictions when preparing cost estimate and planning construction equipment that will be necessary to

ROOT PRUNE FOR DITCH DETAIL

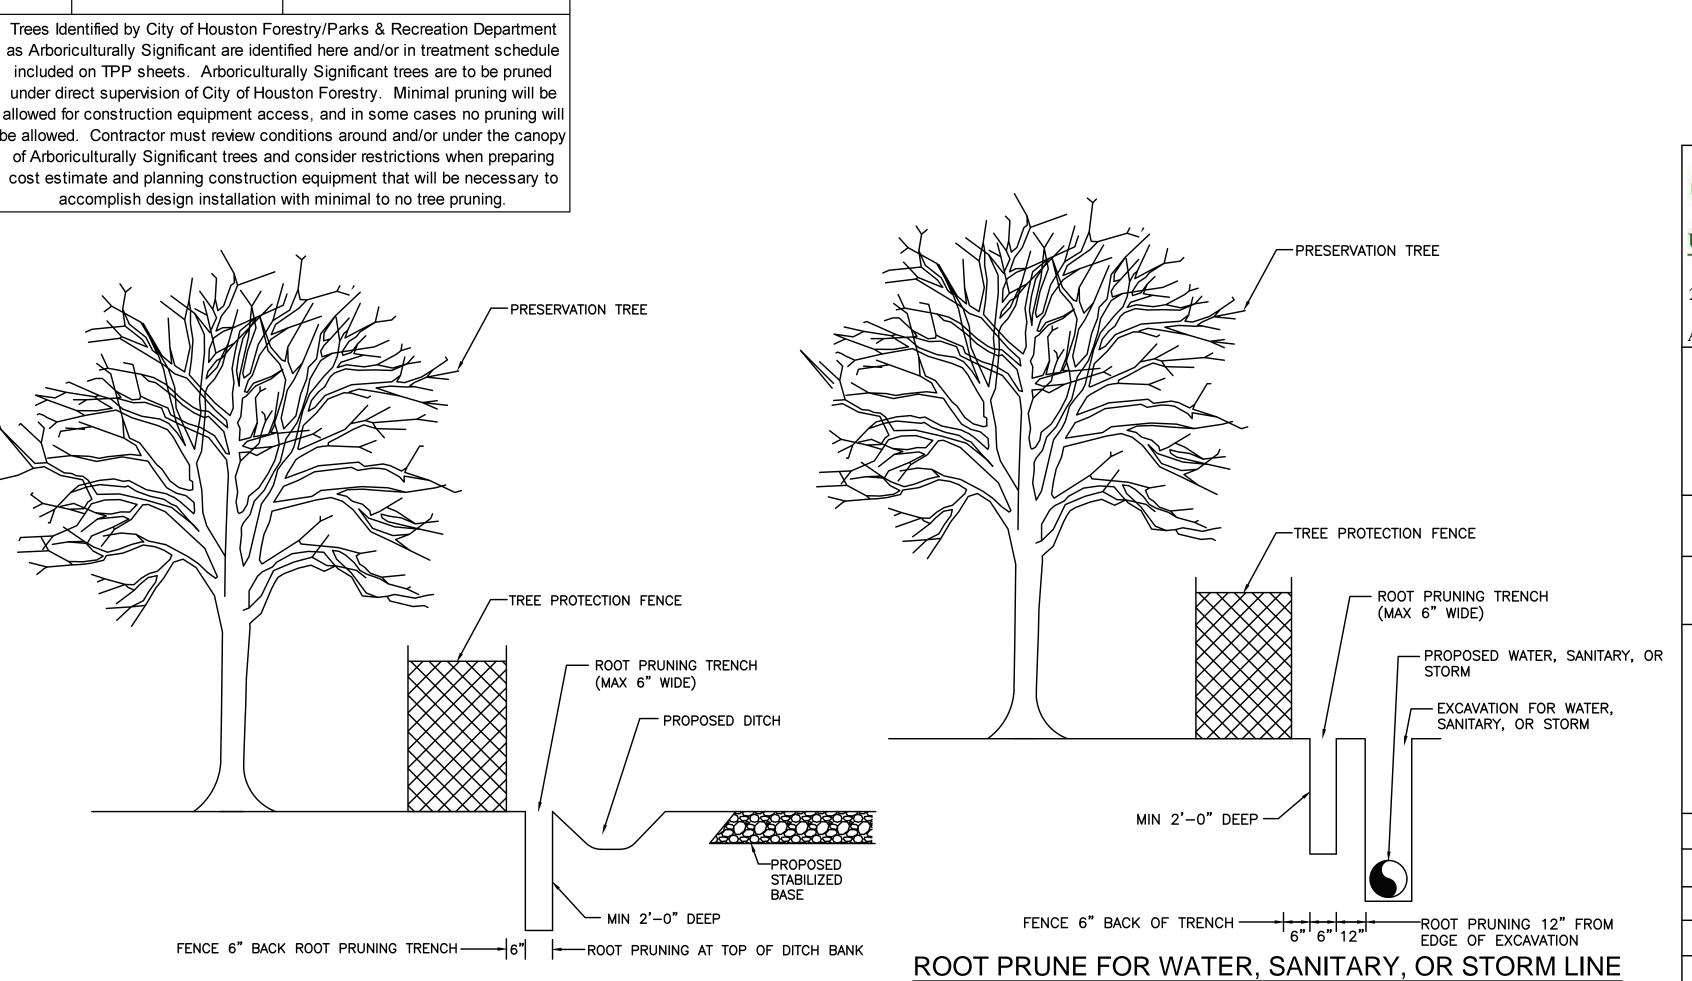

NOT TO SCALE

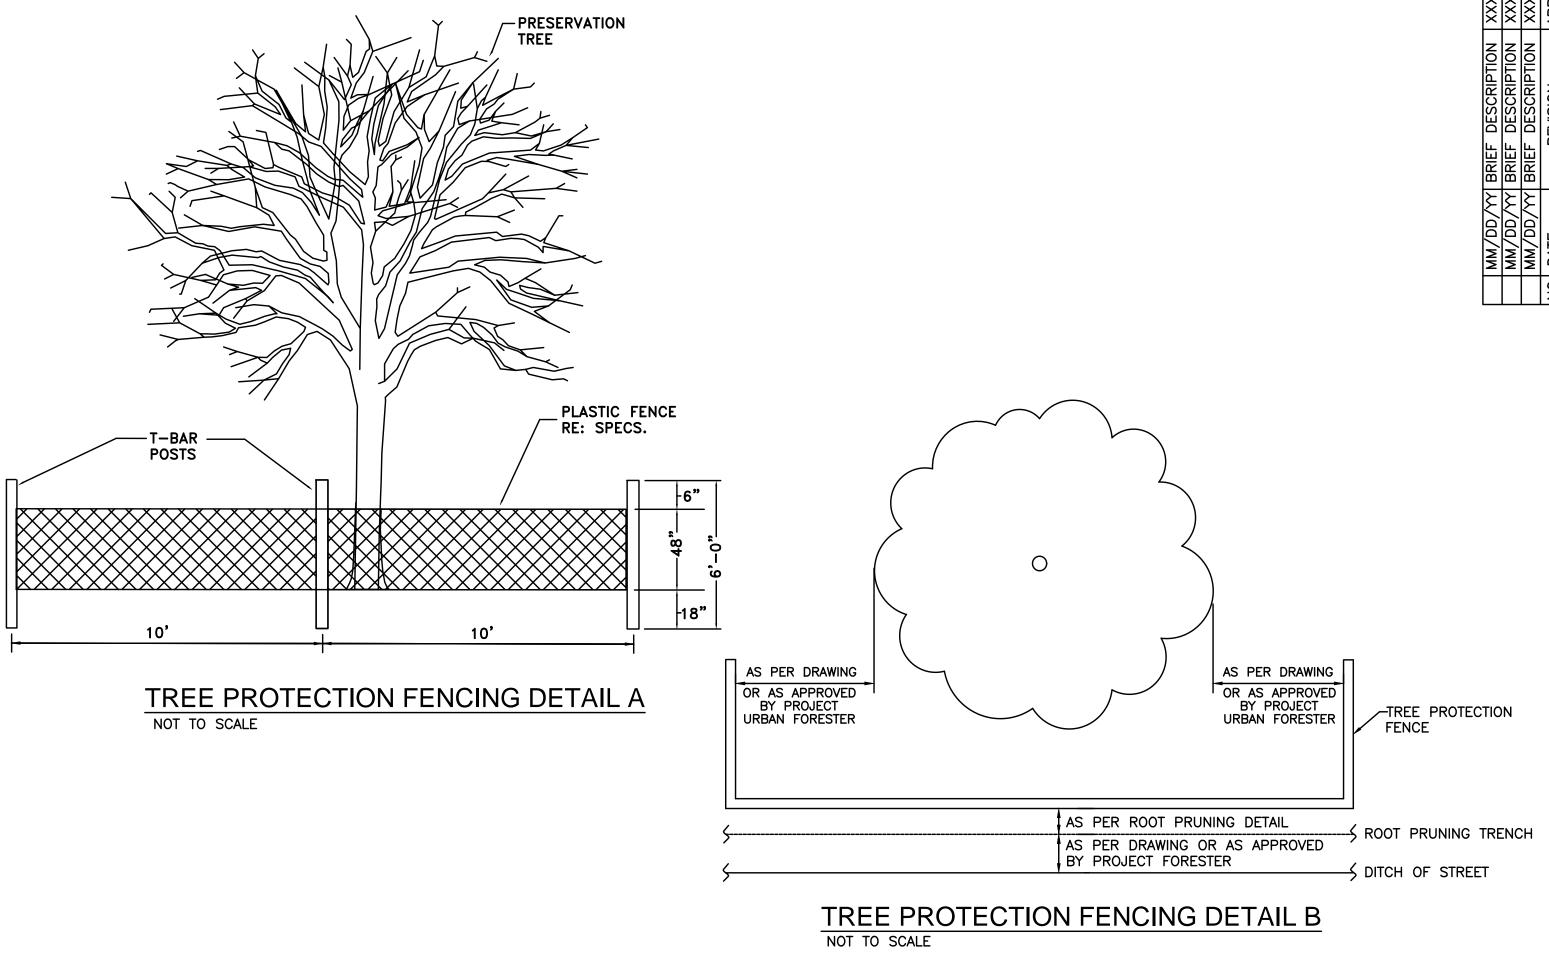



15021 KATY FREEWAY, STE. 500 HOUSTON, TX. 77094 281-945-0069 TX FIRM NUMBER: F-6932 SURVEYED BY: LANDTECH, INC. FB NO. P-6331


## CITY OF HOUSTON HOUSTON PUBLIC WORKS

SHARPSTOWN AREA DETENTION POND A

TREE PROTECTION PLAN

|   | S  | HEET   | 3 | 01  | F 3 |
|---|----|--------|---|-----|-----|
| Y | OF | HOUSTO | N | USE | ONL |

|                      | 011221 0 01 0                |
|----------------------|------------------------------|
| WBS NUMBER           | FOR CITY OF HOUSTON USE ONLY |
| M-410040-001A-3      |                              |
| DRAWING SCALE        |                              |
| AS NOTED             |                              |
| CITY OF HOUSTON PM   |                              |
| SUPUN ILANGAMUDALIGE |                              |
| SHEET NO. 31 OF 42   |                              |

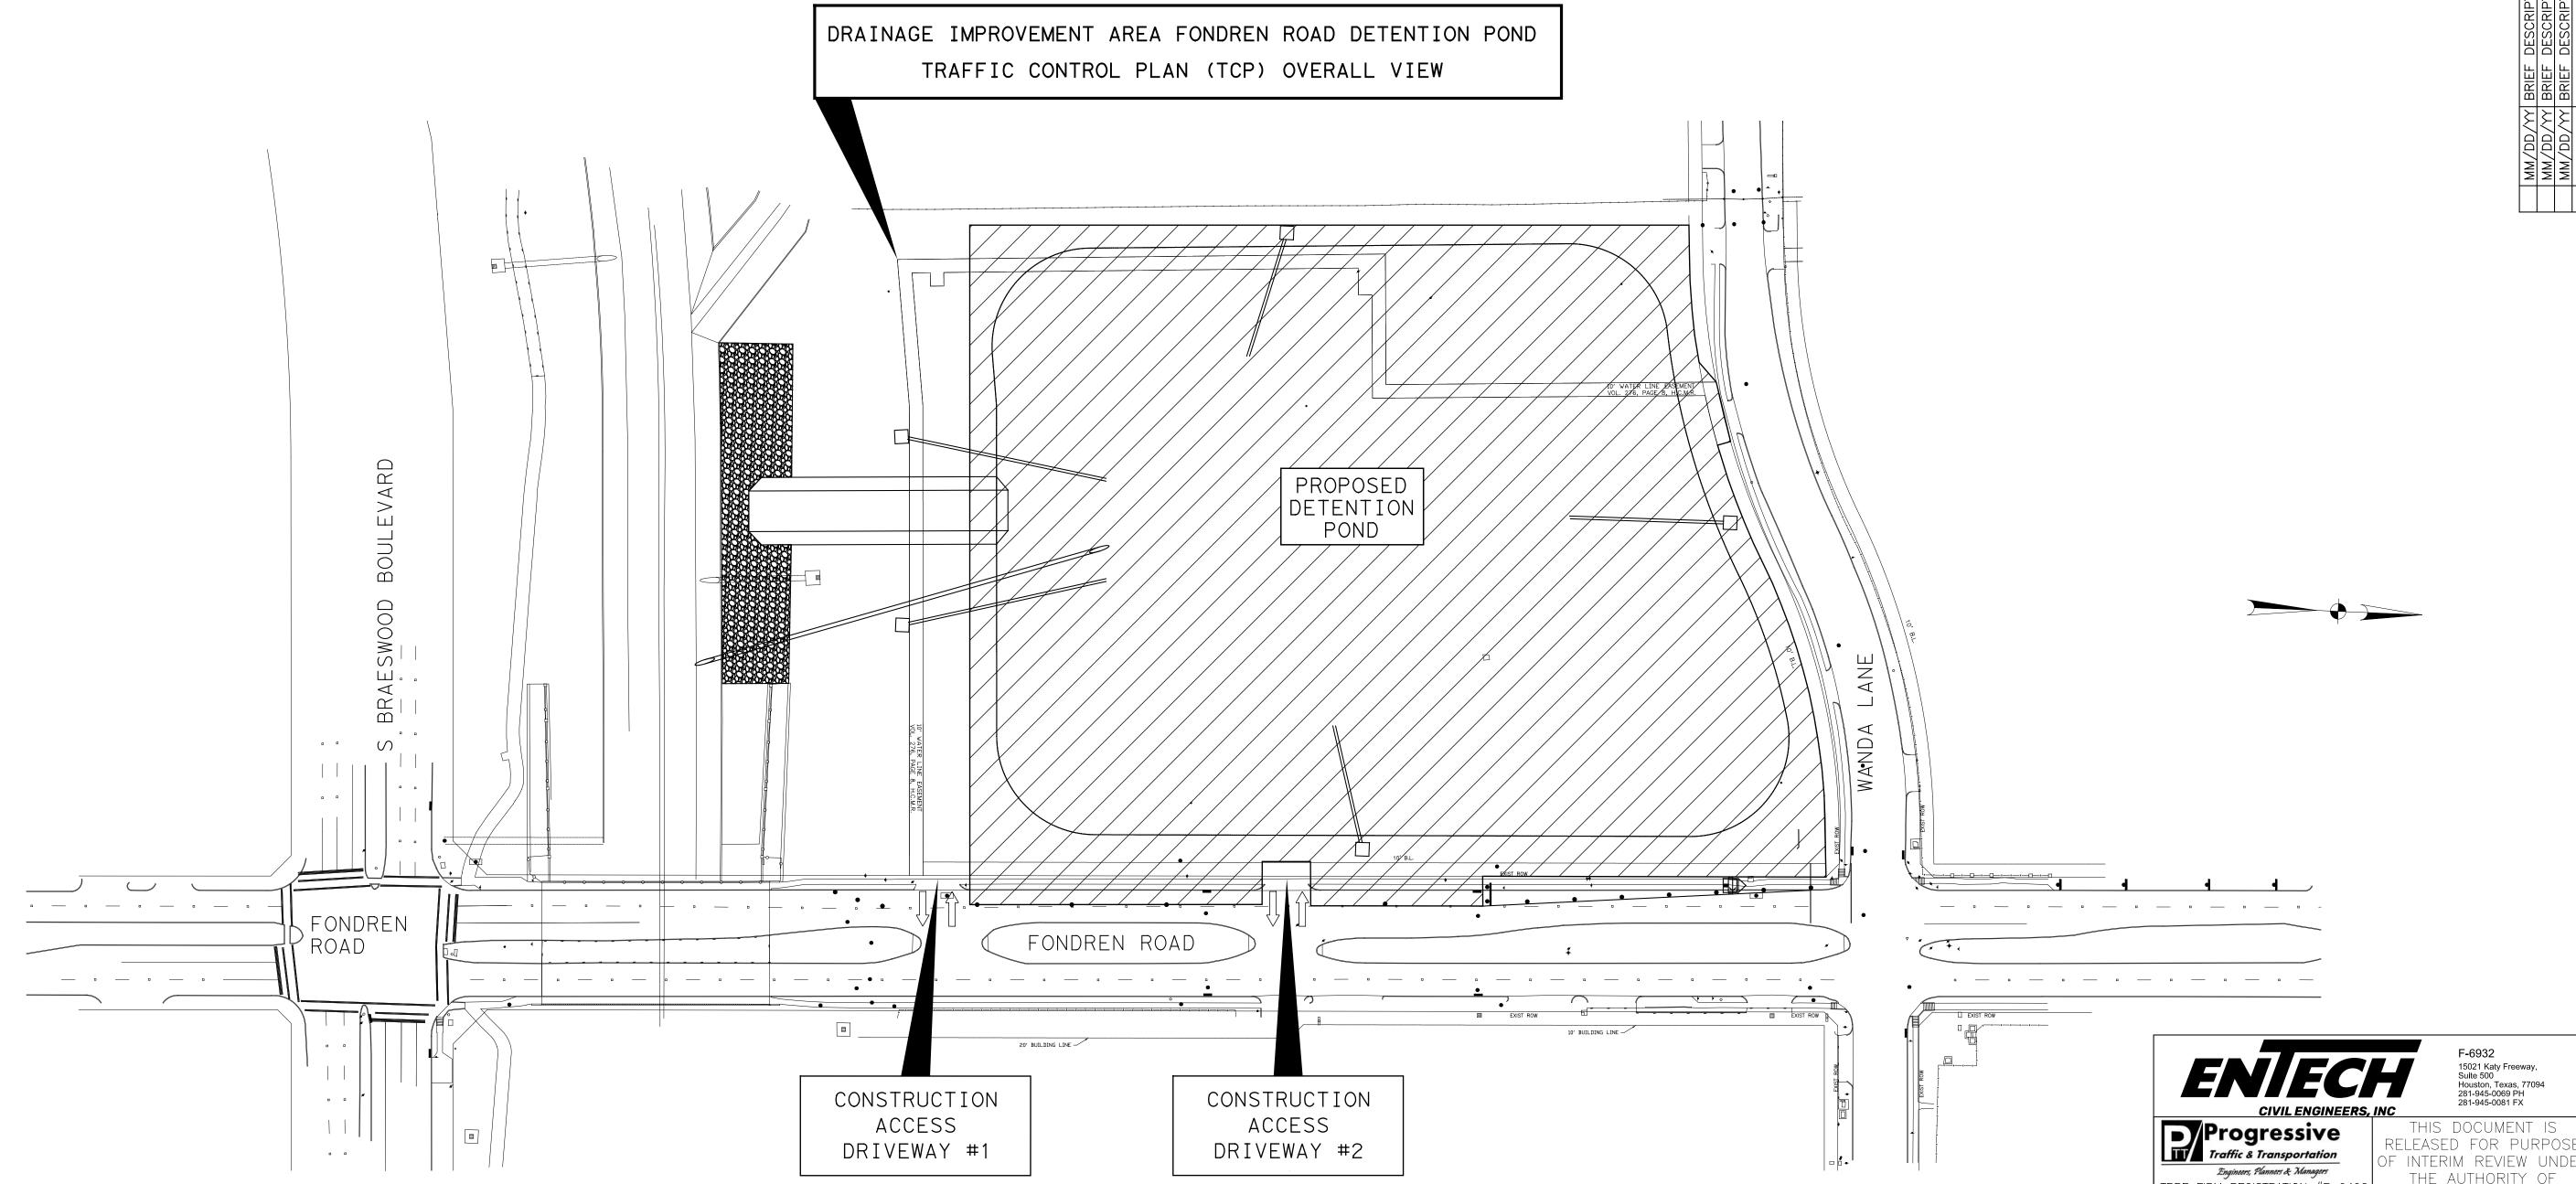

#### TCP GENERAL NOTES:

- 1. THE CONTRACTOR SHALL INSTALL TRAFFIC CONTROL DEVICES IN CONFORMANCE WITH PART VI OF THE CURRENT TEXAS MANUAL ON UNIFORM TRAFFIC CONTROL DEVICES (TMUTCD).
- 2. NO CONSTRUCTION IS ALLOWED BETWEEN 4PM AND 9AM MONDAY THROUGH SUNDAY.
- 3. THE CONTRACTOR SHALL MAINTAIN ALL BUSINESS & RESIDENTIAL DRIVEWAYS, TRAFFIC CONTROL DEVICES, STREET NAME SIGNS, STOP SIGNS, WARNING SIGNS, TEMPORARY AND EXISTING SIGNS DURING THE ENTIRE PERIOD OF CONSTRUCTION. EXISTING SIGN OR STRIPING IN CONFLICT WITH TEMPORARY TRAFFIC CONTROL SIGNS SHALL BE COVERED OR REMOVED.
- 4. CONTRACTOR TO ENSURE PROPER DRAINAGE TO EXISTING DRAINAGE DITCHES AT ALL TIMES.
- 5. WHERE PROJECT REQUIREMENTS ARE NOT FULLY SATISFIED BY THE DETAILS SHOWN HEREIN, THE TEXAS MANUAL ON UNIFORM TRAFFIC CONTROL DEVICES (THE MOST RECENT EDITION) SHALL GOVERN.
- 6. ALL TEMPORARY SIGNS AND PAVEMENT MARKINGS INSTALLED DURING CONSTRUCTION SHALL BE IN ACCORDANCE WITH THE REQUIREMENTS OF THE T.M.U.T.C.D., UNLESS SPECIFICALLY DIRECTED BY THE CITY AUTHORIZED OFFICIAL/ENGINEER.
- 7. THE CONTRACTOR SHALL PROVIDE CERTIFIED FLAGGERS OR AN OFF DUTY POLICE OFFICER TO DIRECT TRAFFIC. THIS DOES NOT RELIEVE THE CONTRACTOR OF RESPONSIBILITY FOR TAKING ANY ADDITIONAL MEASURES OR PROVIDING PERSONNEL NECESSARY TO PROTECT THE WORK AND THE PUBLIC.

- 8. CONTRACTOR SHALL ENSURE THAT ALL BARRICADES, SIGNS, CHANNELIZING DEVICES, WARNING LIGHTS, AND TRAFFIC CONTROL DEVICES ARE MAINTAINED IN A CLEAN FUNCTIONAL CONDITION AT ALL TIMES.
- 9. ALL SIGNS, WARNING DEVICES, AND BARRICADES ARE THE SOLE RESPONSIBILITY OF THE CONTRACTOR, INCLUDING ACTS OF VANDALISM OR ACCIDENTS.
- 10. THE CONTRACTOR SHALL MAINTAIN ALL TEMPORARY AND EXISTING PAVEMENT MARKINGS IN GOOD CONDITION THROUGHOUT THE DURATION OF THE CONTRACT.
- 11. THE CONTRACTOR SHALL MAINTAIN BARRICADES AND SAFETY FENCES AT EACH SITE WHERE PEDESTRIAN TRAFFIC IS EVIDENT.
- 12. THE CONTRACTOR SHALL CONDUCT HIS OPERATION IN A MANNER SUCH THAT TRUCKS AND OTHER CONSTRUCTION VEHICLES DO NOT CREATE A DIRT NUISANCE OR SAFETY HAZARD IN ANY PUBLIC OR PRIVATE STREET.
- 13. ALL BARRICADES, SIGNS, STRIPING, CHANNELIZING DEVICES, AND ALL EQUIPMENT INCIDENTALS, AND ALL LABOR REQUIRED FOR TRAFFIC CONTROL SHALL BE INCLUDED IN THE LUMP SUM PRICE BID FOR TRAFFIC HANDLING.
- 14. THE CONTRACTOR IS RESONSIBLE FOR MAINTAING THE EXISTING SIDEWALK AND/OR PROVIDING A TEMPORARY SIDEWALK.

#### CONSTRUCTION SEQUENCE:

#### PROPOSED DETENTION POND CONSTRUCTION ALONG FONDREN ROAD

- 1. INSTALL THE PROPOSED ADVANCE CONSTRUCTION WARNING SIGNS AS SHOWN ON THE TRAFFIC CONTROL PLAN (TCP) SHEETS.
- 2. THE PROJECT STARTS AT APROXIMATELY 340-FT NORTH OF THE SIGNALIZED INTERSECTION OF FONDREN ROAD AT S BRAESWOOD BOULEVARD AND IS ACTIVE THROUGH THE INTERSECTION OF FONDREN ROAD AT WANDA LANE.
- 3. CONTRACTOR SHALL BLOCK THE OUTSIDE LANE ALONG THE SOUTHBOUND FONDREN ROAD AND ALLOW THE INSIDE LANE FOR SOUTHBOUND FONDREN ROAD THROUGH TRAFFIC.
- 4. THE CONSTRUCTION WORK ZONE WILL OCCUPY THE OUTSIDE SOUTHBOUND OF FONDREN ROAD. CONSTRUCTION VEHICLES AND EQUIPMENT SHALL ACCESS THE WORK ZONE VIA THE EXISTING ACCESS DRIVEWAYS ALONG SOUTHBOUND FONDREN ROAD, IDENTIFIED AS CONSTRUCTION ACCESS DRIVEWAY #1 AND #2 RESPECTIVELY ON SHEET 2 OF 2.
- 5. THE CONTRACTOR IS RESPONSIBLE FOR MAINTAINING COORDINATION WITH THE HOUSTON METRO FOR ALL AFFECTED BUS ROUTES THROUGH ALL PHASES OF CONSTRUCTION.

FB NO. P-6331

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HOUSTON


SHARPSTOWN AREA DETENTION POND A

HOUSTON PUBLIC WORKS

TRAFFIC CONTROL PLAN (TCP) FONDREN ROAD OVERALL PLAN VIEW

CHEET 1 OF 1

|                      | SHEEL LOF L                  |
|----------------------|------------------------------|
| WBS NUMBER           | FOR CITY OF HOUSTON USE ONLY |
| M-410040-001A-3      |                              |
| DRAWING SCALE        |                              |
| AS NOTED             |                              |
| CITY OF HOUSTON PM   |                              |
| SUPUN ILANGAMUDALIGE |                              |
| SHEET NO. 32 OF 42   |                              |

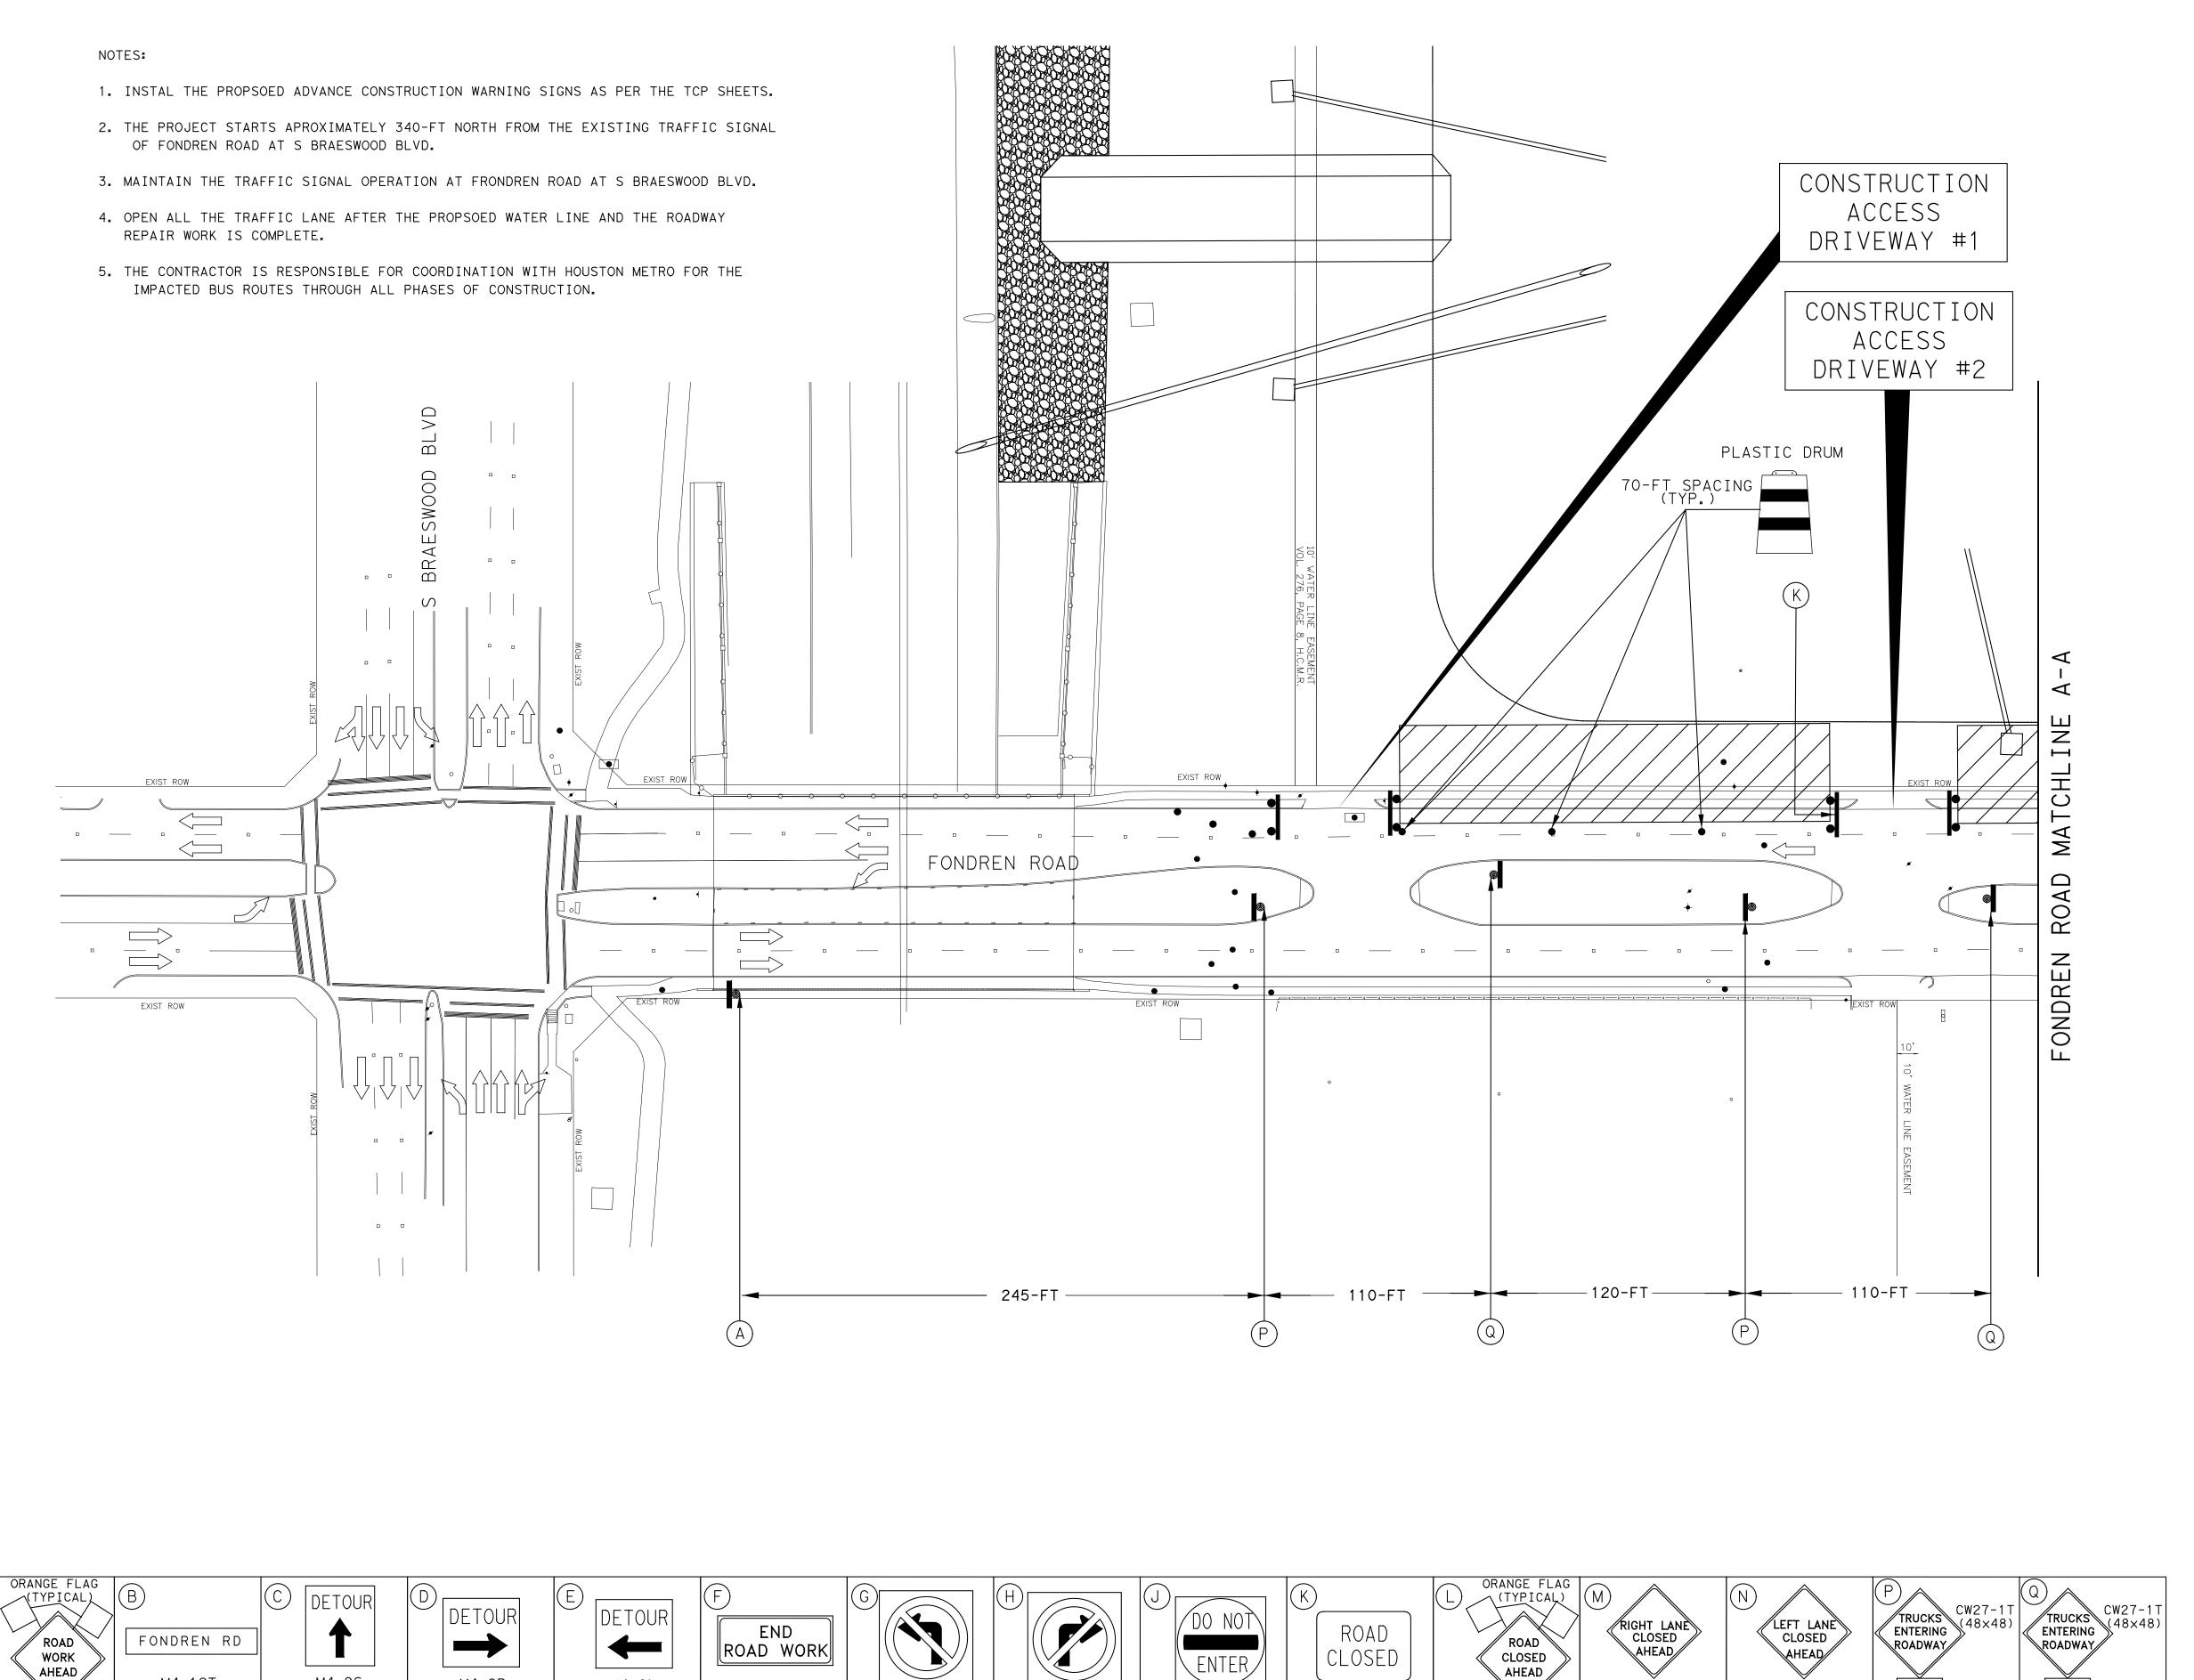

R5-1

(30×30)

R3-1

(24×24)

(24×24)

R11-2

(48×30)

(36×36)

M4-9S

(30×24)

M4-9R

(30×24)

M4-9L

(30×24)

G20-2a

(36 X 18)

M4-12T

(VAR X 12)

CW20-1D

(36×36)

TCP LEGEND:

CONSTRUCTION AREA



TY III TRAFFIC BARRIER



TEMP. GROUND MOUNTED SIGNS



PLASTIC DRUM




36-INCH TRAFFIC CONTROL DELLINEATOR



FLASHING ARROW PANEL



CERTIFIED FLAGGER/

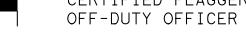

DIRECTION OF TRAVEL

| TYPICAL SIGN SPACING & TAPER LENGTH |                        |               |                   |               |  |
|-------------------------------------|------------------------|---------------|-------------------|---------------|--|
| Fondren<br>Road                     | Sign                   |               | n. Desi<br>Length |               |  |
| Posted<br>Speed<br>(mph)            | Sign<br>Spacing<br>(X) | 10'<br>Offset | 11'<br>Offset     | 12'<br>Offset |  |
| 35                                  | 160′                   | 205′          | 225′              | 245′          |  |





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## Progressive Traffic & Transportation Engineers, Planners & Managers

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SHEET NO. 33 OF 42

CW16-5PR (24×18)

CW16-5PL

(24×18)

CW20-5DL

(36×36)

CW20-5DR

(36×36)

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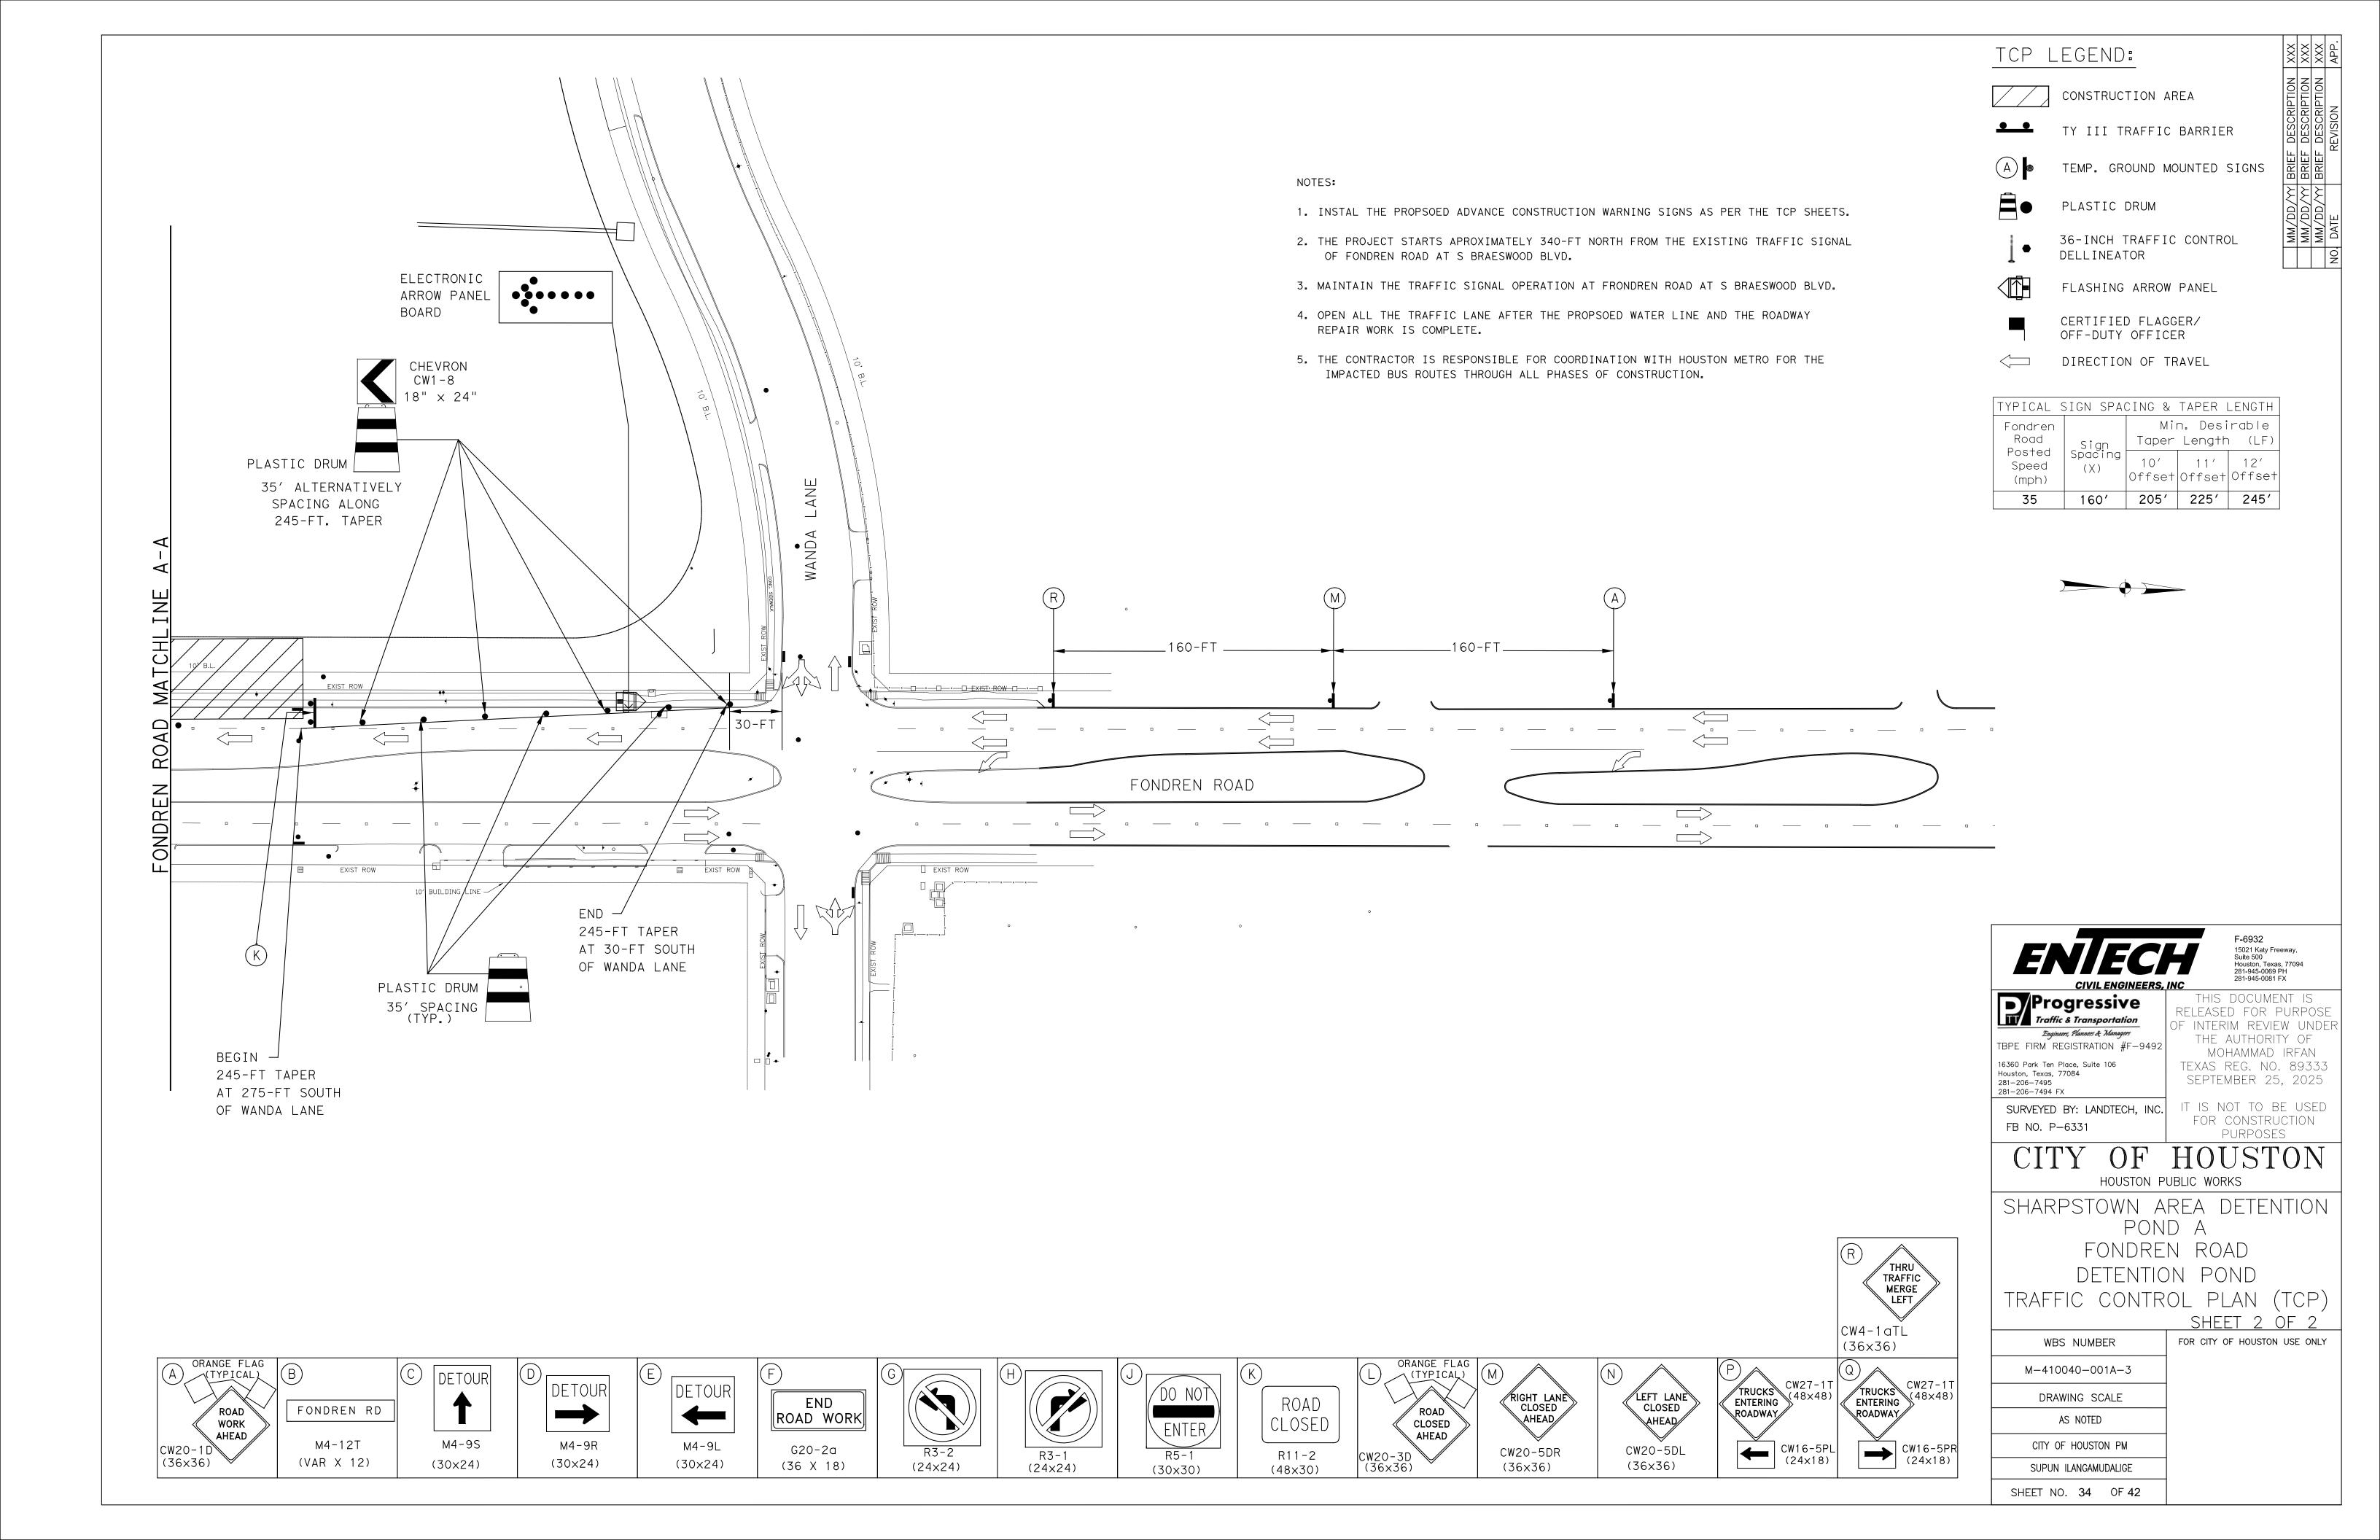
HOUSTON PUBLIC WORKS

SHARPSTOWN AREA DETENTION POND A

DETENTION POND TRAFFIC CONTROL PLAN (TCP)

SHEET 1 OF 2

FOR CITY OF HOUSTON USE ONLY WBS NUMBER M-410040-001A-3 DRAWING SCALE AS NOTED CITY OF HOUSTON PM SUPUN ILANGAMUDALIGE



#### **GENERAL NOTES**

- THE CONTRACTOR SHALL PROVIDE AND INSTALL TRAFFIC CONTROL DEVICES IN CONFORMANCE WITH PART VI OF THE TEXAS MANUAL ON UNIFORM TRAFFIC CONTROL DEVICES (TMUTCD) LATEST EDITION WITH REVISIONS DURING THE ENTIRE CONSTRUCTION PERIOD.
- ALL SIGNS AND TRAFFIC CONTROL DEVICES SHALL CONFORM THE LATEST VERSION OF THE
- . NO LANES SHALL BE CLOSED DURING THE HOURS OF 7:00 AM TO 9:00 AM AND 4:00 PM TO 6:00 PM MONDAY THRU FRIDAY WITHOUT APPROVAL OF THE CITY TRAFFIC ENGINEER.
- . NO WORK SHALL BE PERFORMED IN RESIDENTIAL AREAS FROM 7:00 PM TO 7:00 AM.
- CONTRACTOR SHALL MAINTAIN APPROVED NUMBER OF THROUGH LANES OF TRAFFIC IN EACH DIRECTION DURING CONSTRUCTION WORKING HOURS. TRAFFIC CONTROL PLANS SHALL INCLUDE ONE-WAY AND/OR DETOUR PLANS. CONTRACTOR SHALL MAINTAIN ADA COMPLIANT PEDESTRIAN ACCESS TO BUS STOPS AND ADEQUATE BUS ACCESS TO ALL THE BUS STOPS.
- S. CONTRACTOR SHALL MAINTAIN TRAFFIC LANES AND DETOURS ACCORDING TO TRAFFIC CONTROL
- CONTRACTOR SHALL COVER OPEN PAVEMENT EXCAVATIONS FOR MINOR UTILITY WORK WITH ANCHORED STEEL PLATES DURING NON-WORKING HOURS, AND OPEN LANES FOR NORMAL TRAFFIC
- 3. IF THE CONTRACTOR CHOOSES TO USE A DIFFERENT METHOD OF "TRAFFIC CONTROL PLANS" DURING THE CONSTRUCTION THAN WHAT IS OUTLINED IN THE CONTRACT DRAWINGS, THE CONTRACTOR SHALL BE RESPONSIBLE TO PREPARE AND SUBMIT AN ALTERNATE SET OF TRAFFIC CONTROL PLANS TO THE CITY OF HOUSTON PROJECT MANAGER FOR APPROVAL TEN WORKING DAYS PRIOR TO IMPLEMENTATION. THESE PLANS SHALL BE DRAWN TO SCALE ON REPRODUCIBLE MYLARS AND SHALL BE SEALED BY A LICENSED ENGINEER IN THE STATE OF TEXAS. OFFICE OF CITY ENGINEER, MOBILITY PERMITS SECTION REPRESENTATIVE APPROVAL IS REQUIRED TO ACCEPT
- CONTRACTOR SHALL SECURE LANE/SIDEWALK/BICYCLE FACILITY CLOSURE PERMITS FROM OFFICE OF CITY ENGINEER (MOBILITY PERMIT SECTION AT <a href="https://geohub.houstontx.gov">https://geohub.houstontx.gov</a>) BEFORE IMPLEMENTING THE TRAFFIC CONTROL PLAN. THE APPLICATION MUST BE SUBMITTED AT LEAST TEN DAYS PRIOR TO THE IMPLEMENTATION OF THE TRAFFIC CONTROL PLAN AND/OR BEGINNING CONSTRUCTION WORK. THE CONTRACTOR SHALL PROVIDE TRAFFIC CONTROL PLANS, CONSTRUCTION SEQUENCING, AND CONSTRUCTION SCHEDULE WITH THE APPLICATION.
- 10. CONTRACTOR SHALL HAVE APPROVED TRAFFIC CONTRCL PLAN AND PERMIT AT THE JOB SITE FOR INSPECTION AT ALL TIMES.
- 11. DURING PAVEMENT SURFACE RESTORATION PROJECTS; THE CONTRACTOR SHALL NOT OPEN CLOSED LANES UNTIL THE PAVEMENT SURFACE HAS CURED ENOUGH TO ALLOW VEHICULAR TRAFFIC ACCORDING TO CITY OF HOUSTON STANDARD SPECIFICATIONS.
- 12. THE CONTRACTOR IS RESPONSIBLE FOR SCHEDULING AND COORDINATING ALL CONSTRUCTION ACTIVITIES WITH STAKE HOLDERS IN THE VICINITY INCLUDING EMERGENCY RESPONSE AGENCIES SUCH AS HOUSTON POLICE DEPARTMENT, HOUSTON FIRE DEPARTMENT, AND METROPOLITAN
- 13. CONTRACTOR SHALL BE RESPONSIBLE FOR ISSUING ALL WORK DIRECTIVES TO ALL SUB-CONTRACTORS, UTILITY COMPANIES, AND ALL OTHER ENTITIES PERFORMING CONSTRUCTION WORK ASSOCIATED WITH THE PROJECT.
- 14. NOTHING IN THESE NOTES OR PLANS SHALL RELIEVE THE CONTRACTOR OF THE RESPONSIBILITY FOR JOB SITE CONDITIONS DURING THE COURSE OF CONSTRUCTION OF THE PROJECT; INCLUDING SAFETY OF ALL MODES OF TRANSPORTATION, PERSONS, AND PROPERTY, AND THAT THIS REQUIREMENT SHALL APPLY CONTINUOUSLY AND NOT BE LIMITED TO WORKING HOURS.
- 15. THE OFFICE OF CITY ENGINEER (MOBILITY PERMITS GROUP) PER THE DIRECTION OF THE CITY TRAFFIC ENGINEER HAVE THE RIGHT TO DEMAND THE INSTALLATION OF ADDITIONAL TRAFFIC CONTROL DEVICES OR MODIFICATIONS OF THESE PLANS AND NOTES, AS DEEMED NECESSARY TO PROMOTE THE SAFE AND ORDERLY FLOW OF TRAFFIC, INCLUDING PEDESTRIANS AND BICYCLES, THROUGH THE CONSTRUCTION WORK ZONE. THE CONTRACTOR SHALL COMPLY WITH THESE ADDITIONAL REQUESTS OR MODIFICATIONS WITH DUE DILIGENCE.

16. ALL EXISTING TRAFFIC CONTROL SIGNS AND PAVEMENT MARKINGS SHALL BE MAINTAINED IN

- VISIBLE LOCATIONS DURING CONSTRUCTION UNLESS PRIOR WRITTEN APPROVAL IS OBTAINED FROM CITY OF HOUSTON PROJECT MANAGER. THE CONTRACTOR SHALL RESTORE OR REPLACE (AT THE DISCRETION OF THE CITY TRAFFIC ENGINEER) ANY PAVEMENT MARKING OR SIGNING DAMAGE DURING CONSTRUCTION OPERATIONS, INCLUDING RAISED PAVEMENT MARKERS (RPMS).
- 17. WHEN ENTERING OR LEAVING ROADWAYS CARRYING PUBLIC TRAFFIC, THE CONTRACTOR'S EQUIPMENT, WHETHER EMPTY OR LOADED SHALL IN ALL CASES YIELD TO PUBLIC TRAFFIC WITH THE ASSISTANCE OF CONTRACTOR PROVIDED CERTIFIED FLAGGER/PEACE OFFICER.
- 18. ACCESS TO DRIVEWAYS ADJACENT TO THE CONSTRUCTION WORK ZONE SHALL BE MAINTAINED AT ALL TIMES AS MUCH AS POSSIBLE. ADDITIONAL CONES AND/OR DELINEATORS MAY BE REQUIRED TO DELINEATE THE DRIVEWAY ACCESS ROUTE THROUGH THE CONSTRUCTION WORK ZONE. A MINIMUM OF ONE TRAVEL LANE SHALL BE MAINTAINED ACROSS THE DRIVEWAYS, UNLESS PRIOR WRITTEN APPROVAL IS OBTAINED FROM CITY OF HOUSTON PROJECT MANAGER.
- 19. SPILLAGE RESULTING FROM HAULING OPERATIONS ALONG OR ACROSS ANY PUBLIC TRAVELED WAY SHALL BE REMOVED IMMEDIATELY BY THE CONTRACTOR.
- 20. THE CONTRACTOR SHALL SUBMIT AN APPLICATION FOR TEMPORARY PARKING RESTRICTIONS IF THERE ARE PARKING METERS LOCATED AT THE PROPOSED LANE CLOSURES FROM PARKING MANAGEMENT DIVISION (832-393-8690) AT LEAST TEN BUSINESS DAYS BEFORE IMPLEMENTATION OF LANE CLOSURES. IN ADDITION, TEMPORARY NO PARKING SIGNS SHALL BE POSTED 24 HOURS PRIOR TO COMMENCEMENT OF WORK.
- 21. ADDITIONAL OFF DUTY OFFICERS/FLAGGERS MAY BE REQUESTED TO DIRECT TRAFFIC WHEN LANES ARE BLOCKED AT THE DISCRETION OF THE CITY PROJECT MANAGER EVEN IF THEY ARE NOT SPECIFICALLY IDENTIFIED ON THE PROJECT PLANS.
- 22. THE CONTRACTOR SHALL REPLACE WITHIN 72 HOURS, ALL TRAFFIC SIGNAL LOOP DETECTORS DAMAGED DURING CONSTRUCTION.
- 23. IN GENERAL, A SOLAR POWERED FLASHING ARROW BCARD SHALL BE REQUIRED ON ALL MAJOR THOROUGHFARE LANES CLOSURES. EXCEPTIONS TO FLASHING ARROW BOARDS AND/OR IMPLEMENTATION ON RESIDENTIAL LANE CLOSURES SHALL BE APPROVED BY CITY TRAFFIC
- 24. APPROVED TRAFFIC CONTROL PLAN SHALL BE IN PLACE BEFORE STARTING ANY EXCAVATION.
- 25. WATER FILLED BARRIERS CAN BE USED AS INSTRUCTED BY THE ENGINEER AND APPROVED BY THE CITY FOR PROJECTS WHERE SPACE IS LIMITED AND HEAVY EQUIPMENT TO PLACE CONCRETE BARRIERS IS NOT FEASIBLE. WATER FILLED BARRIERS SHALL NOT BE USED ON ROADWAYS WITH A POSTED SPEED LIMIT MORE THAN 45 MPH.
- 26. WATER FILLED BARRIERS MUST BE INSTALLED AND MAINTAINED PER THE MANUFACTURER'S REQUIREMENTS AND ROUTINELY INSPECTED FOR DEFECTS.
- 27. IF WATER FILLED BARRIER IS PROVIDED, USE ENVIRONMENTALLY SAFE ANTI-FREEZING AGENT IN THE WATER WHEN IT IS APPLICABLE PER MANUFACTURER SPECIFICATIONS AND RECOVER AGENT WHEN THE BARRIER IS DRAINED.


- 28. DISPOSE OF WATER AND AGENT PROPERLY. DO NOT DRAIN WATER FILLED BARRIER INTO OR ACROSS AN EXISTING TRAVEL LANE.
- 29. PROVIDE BARRIER UNITS THAT ARE CAPABLE OF BEING LIFTED AND MOVED WHEN FILLED IF DRAINING IS NOT POSSIBLE.
- 30. PROVIDE WATER FILLED BARRIER THAT ACTS AS ITS OWN FREE STANDING, NON-REDIRECTIVE END
- 31. WHEN WATER FILLED BARRIERS ARE USED TO CHANNELIZE PEDESTRIANS, THEY MUST HAVE A CONTINUOUS DETECTABLE BOTTOM FOR USERS OF LONG CANES AND THE TOP OF THE UNIT SHALL NCT BE LESS THAN 32 INCHES IN HEIGHT.
- 32. ANY CLOSURE OF A PEDESTRIAN OR BICYCLE FACILITY SHALL REQUIRE THE SHORTEST DETOUR THAT MAINTAINS THE SAFETY OF PEDESTRIAN AND/OR BICYCLISTS.


#### SPACING FOR CHANNELIZING DEVICES

- A. PLASTIC DRUMS ON MERGING TAPER @ 30' C C WITH CHEVRON SIGN @ 60' C C AND WARNING LIGHTS FOR OVERNIGHT CLOSURE.
- B. PLASTIC DRUMS ON DOWNSTREAM TAPER @ 30' C C (RETURN TAPER AND BARRICADE ARE OPTIONAL AND DIVIDED ROADWAY SECTION)
- C. PLASTIC DRUMS ON RADII @ 35' C -C.
- D. PLASTIC DRUMS ON TANGENT @ 35' C C WITH VERTICAL PANEL AT 70' C C AND APPROVED WARNING LIGHT @ 70' C - C (FOR OVERNIGHT CLOSURE).
- E. PLASTIC DRUMS IN FRONT OF CONSTRUCTION ZONE @ 20' C C WITH VERTICAL PANEL AT 40' C -C AND APPROVED WARNING LIGHT @ 40' C - C (FOR OVERNIGHT CLOSURE).
- F. CONCRETE TRAFFIC BARRIER (CTB) OR LOW PROFILE CONCRETE TRAFFIC BARRIER (LPCTB) WITH APPROVED REFLECTORS @ 10' C - C IF PAVEMENT DROP IS GREATER THAN 1 FOOT.
- G. PLASTIC DRUMS W/GUARD RAIL MOUNTED.
- H. SELF- RIGHTING VERTICAL PANEL SPACING.
- 4 LANES TO 2 LANES UNDIVIDED ROADWAY SECTION @ 20' C C. - 4 LANES DIVIDED ROADWAY TO ONE SIDE TWO WAY ROADWAY @ 20' C - C.
- LEFT LANE AND RIGHT LANE STORAGE BAYS @ 15' C − C.
- I. SPACING SHOWN ON TRAFFIC CONTROL SHALL SUPERSEDE THE ABOVE SPACING.
- J. SPACING MAY BE ADJUSTED TO PROVIDE DRIVEWAYS, INTERSECTIONS AND /OR MEDIAN OPENINGS.

|   |                 | E C3 — T<br>NGTHS, A<br>CHAN | ND SL         | JGGES                |               | ACINO         |                             |
|---|-----------------|------------------------------|---------------|----------------------|---------------|---------------|-----------------------------|
|   | POSTED<br>SPEED | SIGN<br>SPACING "X"          | 14/800000     | N. DESIRA<br>ER LENG |               |               | STED MAXIMU<br>IG OF DEVICE |
|   | (MPH)           | (FEET)                       | 10'<br>OFFSET | 11'<br>OFFSET        | 12'<br>OFFSET | ON A<br>TAPER | ON A<br>TANGENT             |
| ĺ | 30              | 120'                         | 150'          | 165'                 | 180'          | 30'           | 60'-75'                     |
|   | 35              | 160'                         | 205'          | 225'                 | 245'          | 35'           | 70'-90'                     |
|   | 40              | 240'                         | 265'          | 295'                 | 320'          | 40'           | 80'-100'                    |
|   | 45              | 320'                         | 450'          | 495'                 | 540'          | 45'           | 90'-110'                    |
|   | 50              | 400'                         | 500'          | 550'                 | 600'          | 50'           | 100'-125'                   |
|   | 55              | 500'                         | 550'          | 605'                 | 660'          | 55'           | 110'-140'                   |
|   |                 |                              |               |                      |               |               |                             |

| 8                  |                        |  |
|--------------------|------------------------|--|
| TABLE              | C4 -                   |  |
| STOPPIN            | NG SIGHT               |  |
| DISTANCE AS A      |                        |  |
| <b>FUNCTION</b>    | OF SPEED               |  |
| POSTED SPEED (MPH) | DISTANCE "D"<br>(FEET) |  |
| 30                 | 200                    |  |
| 35                 | 250                    |  |
| 40                 | 305                    |  |
| 45                 | 360                    |  |
| 50                 | 425                    |  |
| 55                 | 495                    |  |

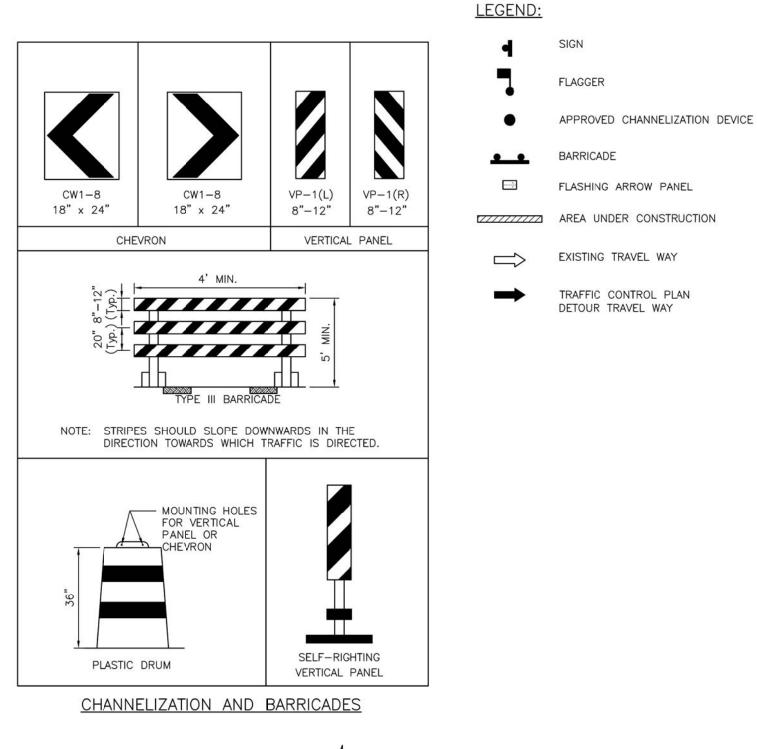

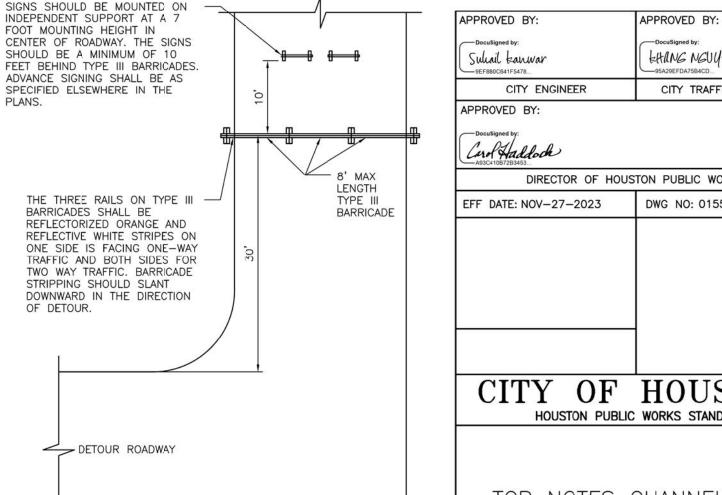

PLAN VIEW TYPE III BARRICADE (POST AND SKID) TYPICAL APPLICATION

EHANG NGUYEN CITY TRAFFIC ENGINEER DIRECTOR OF HOUSTON PUBLIC WORKS DWG NO: 01555-01 CITY OF HOUSTON TCP NOTES CHANNELIZING DEVICES AND BARRICADES FOR CITY OF HOUSTON USE ONLY DRAWING SCALE NOT TO SCALE

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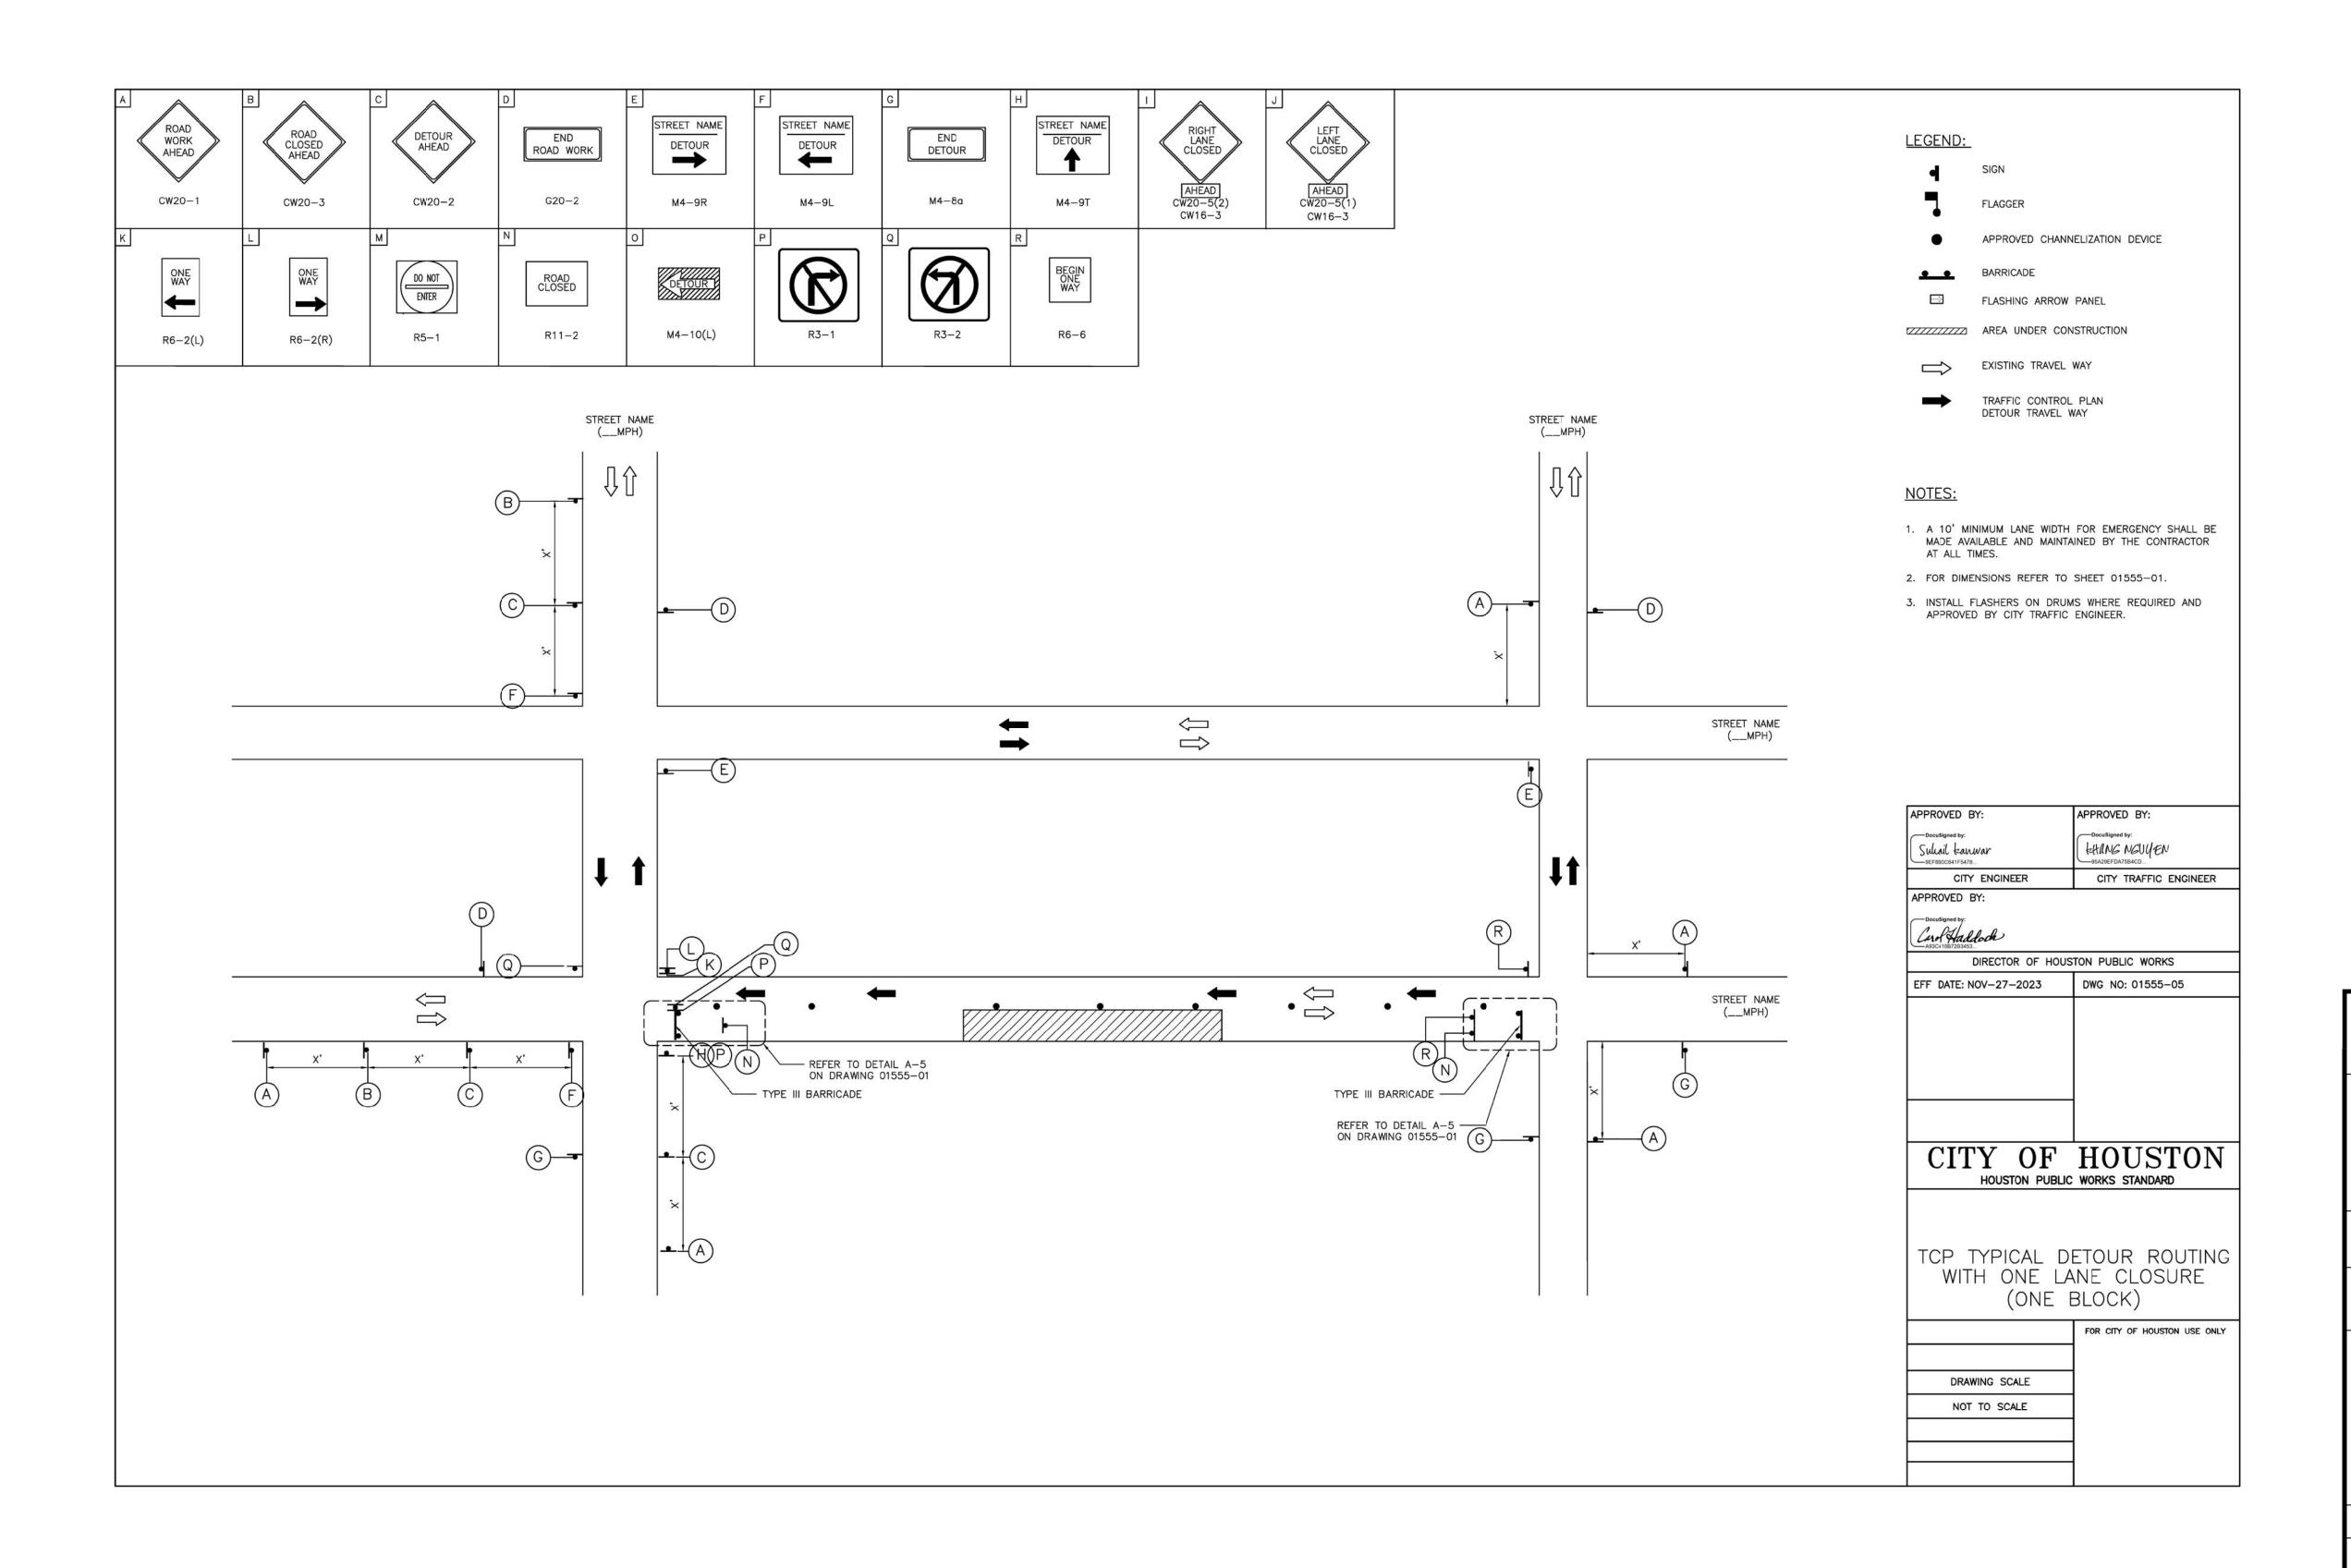
## CITY OF HOUSTON

HOUSTON PUBLIC WORKS

SHARPSTOWN AREA DETENTION POND A

> TRAFFIC CONTROL PLAN STANDARD DETAILS

SHEET 1 OF 3 FOR CITY OF HOUSTON USE ONLY WBS NUMBER M-410040-001A-3DRAWING SCALE AS NOTED CITY OF HOUSTON PM SUPUN ILANGAMUDALIGE SHEET NO. **35** OF **42** 





F-6932 15021 Katy Freeway, Suite 500 Houston, Texas, 77094 281-945-0069 PH 281-945-0081 FX

Progressive
Traffic & Transportation
Engineers, Planners & Managers
TBPE FIRM REGISTRATION #F-9492

16360 Park Jen Place, Suite 106

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## CITY OF HOUSTON

HOUSTON PUBLIC WORKS

SHARPSTOWN AREA DETENTION POND A

TRAFFIC CONTROL PLAN
STANDARD DETAILS

SHEET 2 OF 3

FOR CITY OF HOUSTON USE ONLY

M-410040-001A-3

DRAWING SCALE

AS NOTED


CITY OF HOUSTON PM

SUPUN ILANGAMUDALIGE

SHEET NO. 36 OF 42


WBS NUMBER



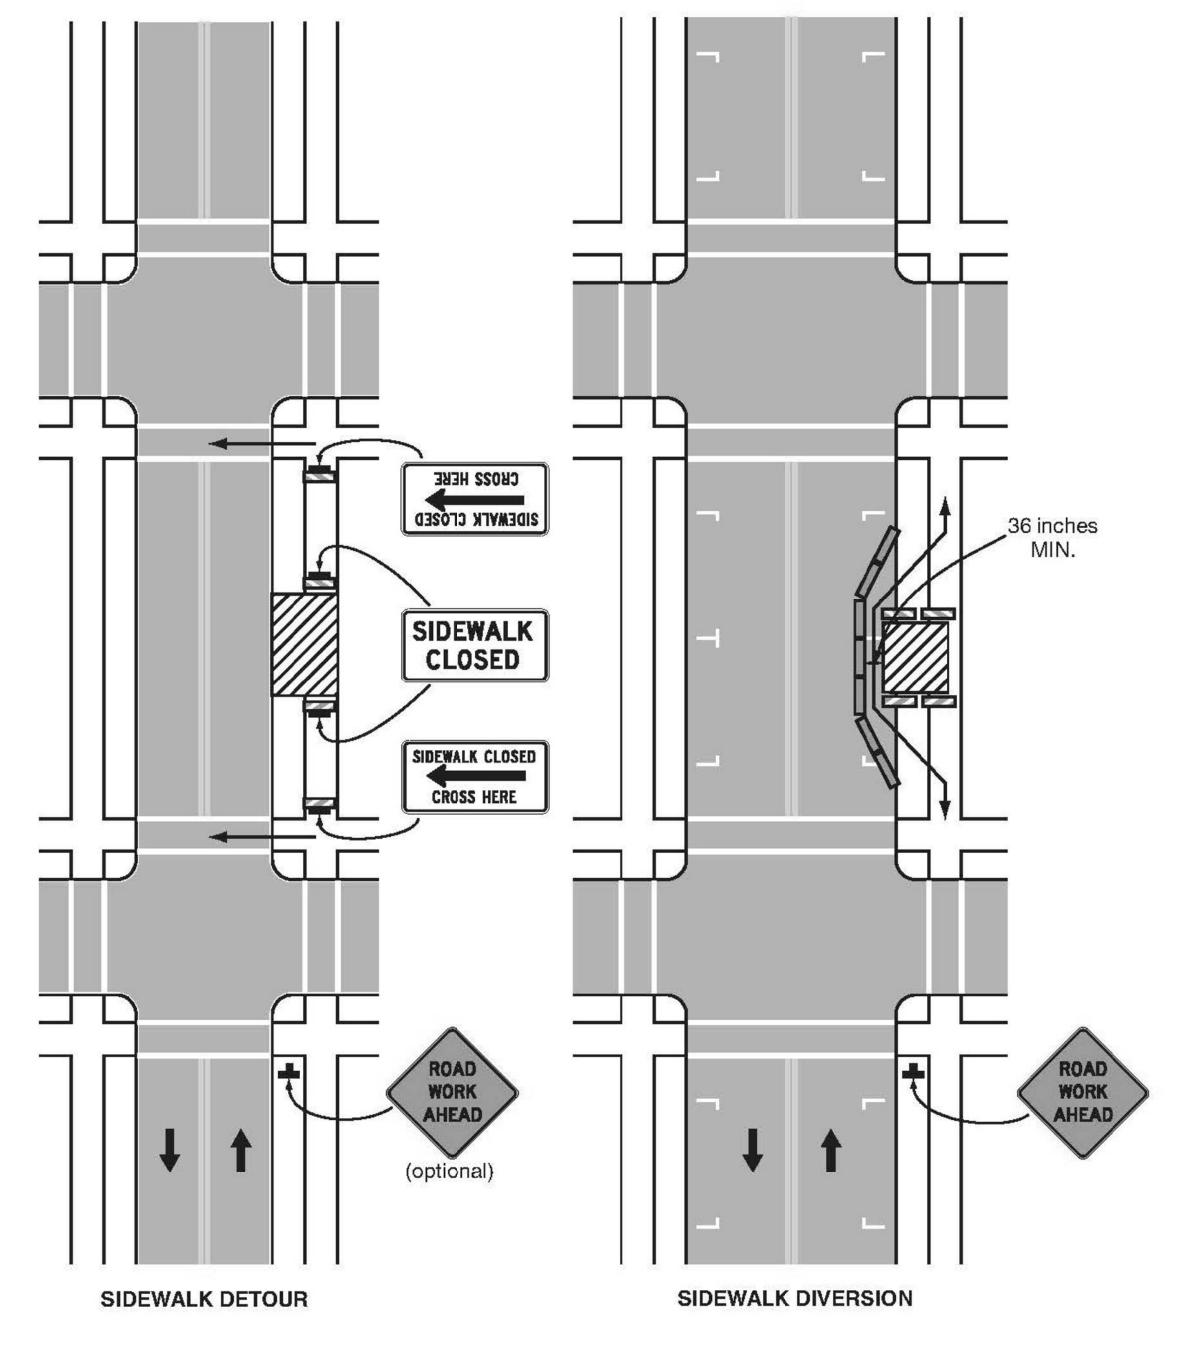

**Typical Application 28** 

Figure 6H-29. Crosswalk Closures and Pedestrian Detours (TA-29)

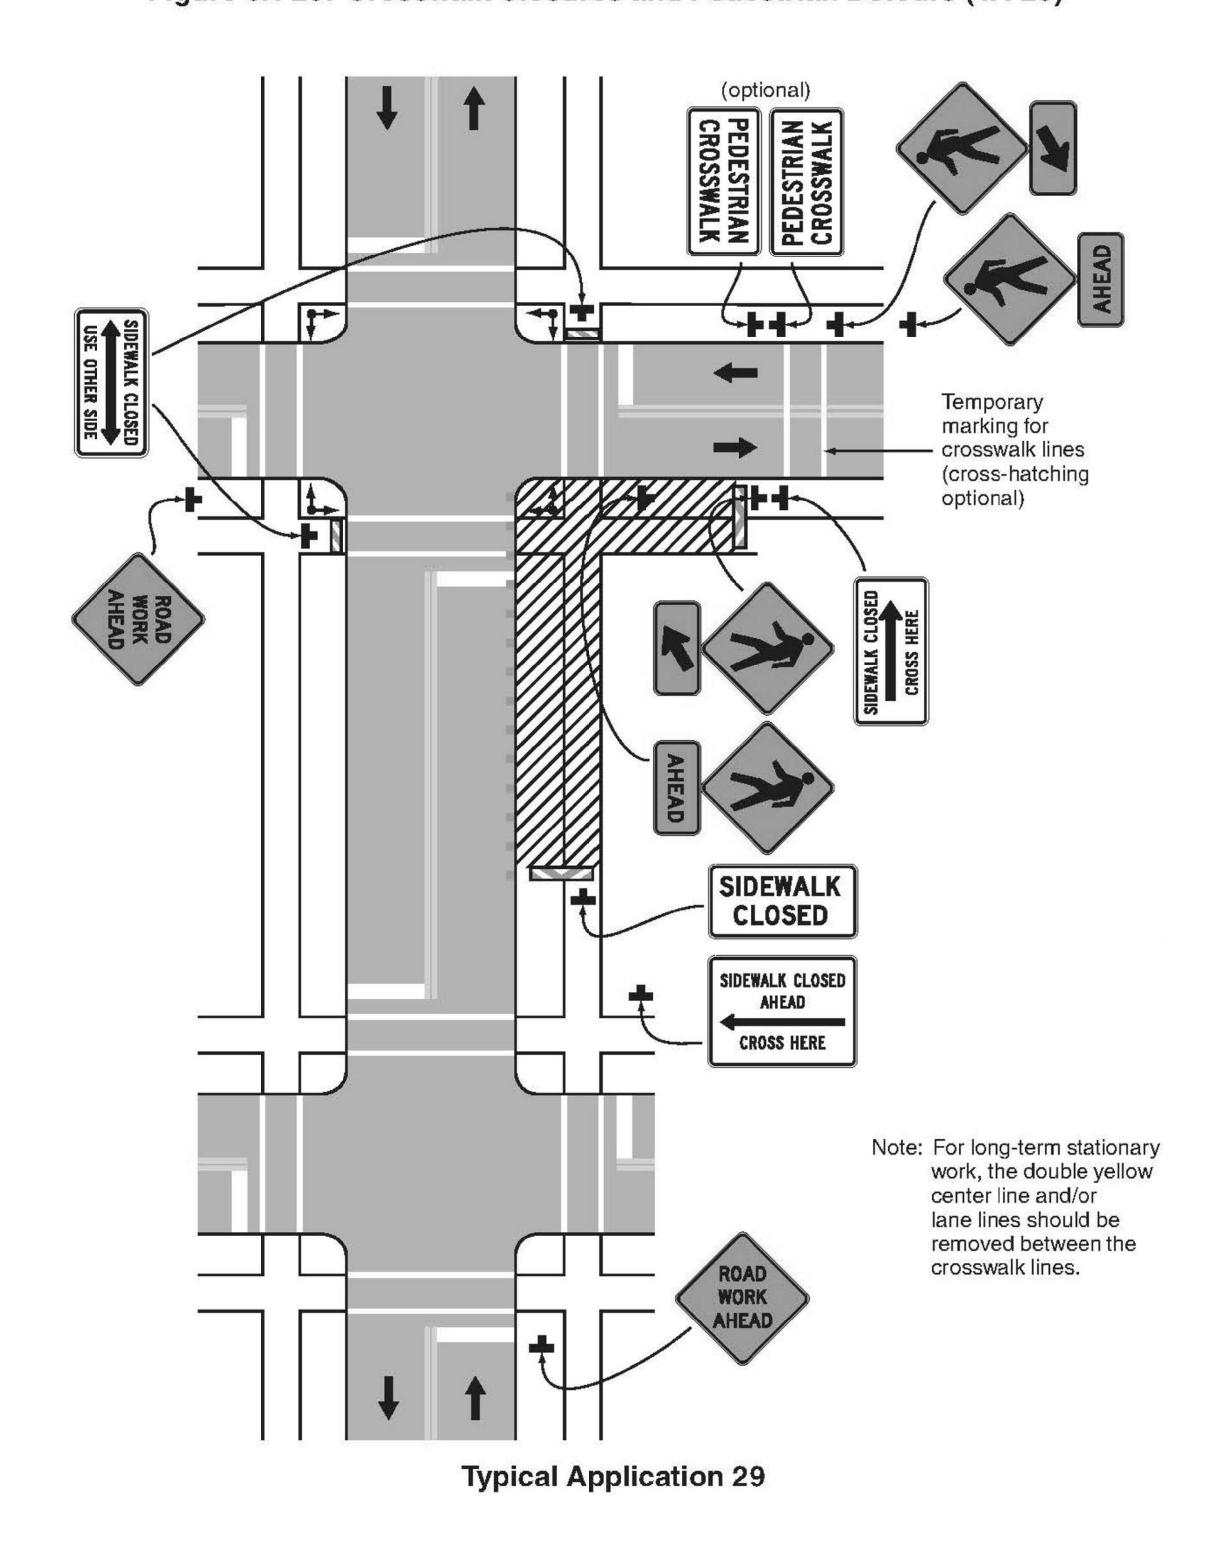



F-6932 15021 Katy Freeway, Suite 500 Houston, Texas, 77094 281-945-0069 PH 281-945-0081 FX

Progressive
Traffic & Transportation Engineers, Planners & Managers

TBPE FIRM REGISTRATION #F—9492

16360 Park Ten Place, Suite 106 Houston, Texas, 77084 281-206-7495 281-206-7494 FX

FB NO. P-6331

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## OF HOUSTON

HOUSTON PUBLIC WORKS


SHARPSTOWN AREA DETENTION POND A

> TRAFFIC CONTROL PLAN STANDARD DETAILS

SHEET 3 OF 3 FOR CITY OF HOUSTON USE ONLY WBS NUMBER M-410040-001A-3

DRAWING SCALE AS NOTED CITY OF HOUSTON PM SUPUN ILANGAMUDALIGE

SHEET NO. 37 OF 42

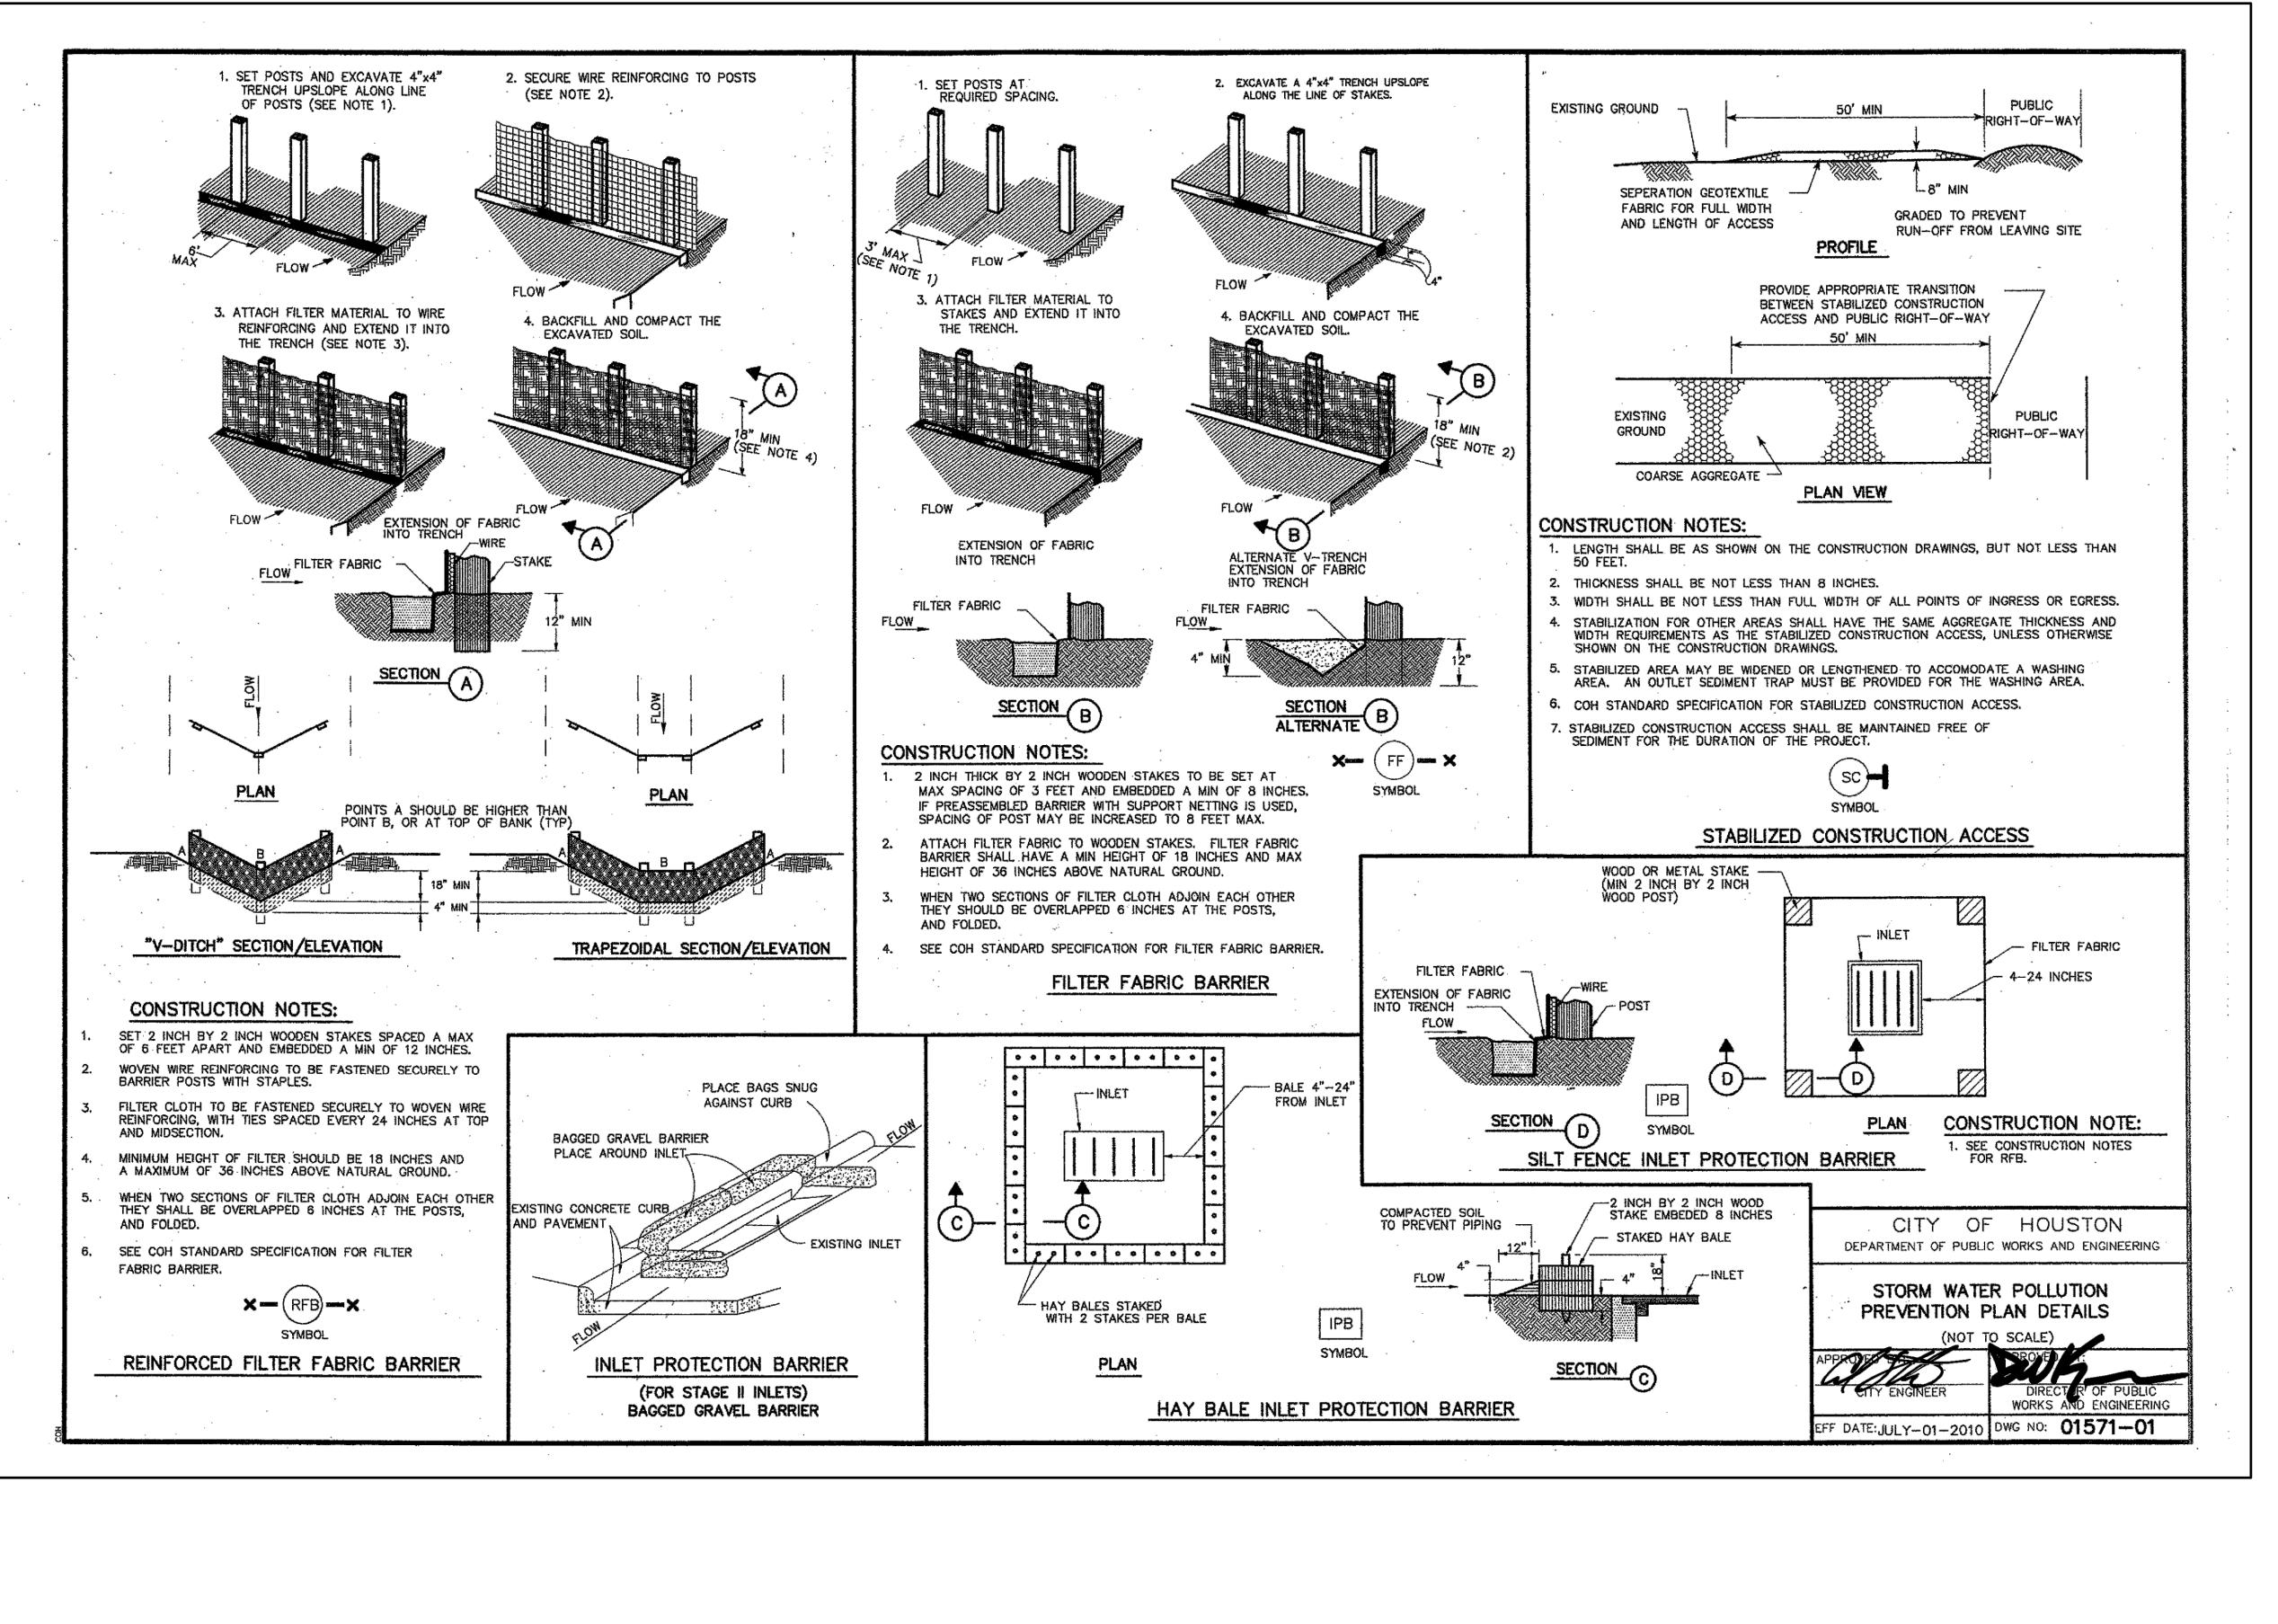

ISANI

civil \ design \ engineers 10448 Westoffice Drive Houston, Texas 77042 P 713 747 2399 F 713 748 3748 TBPE Firm Reg. #4575

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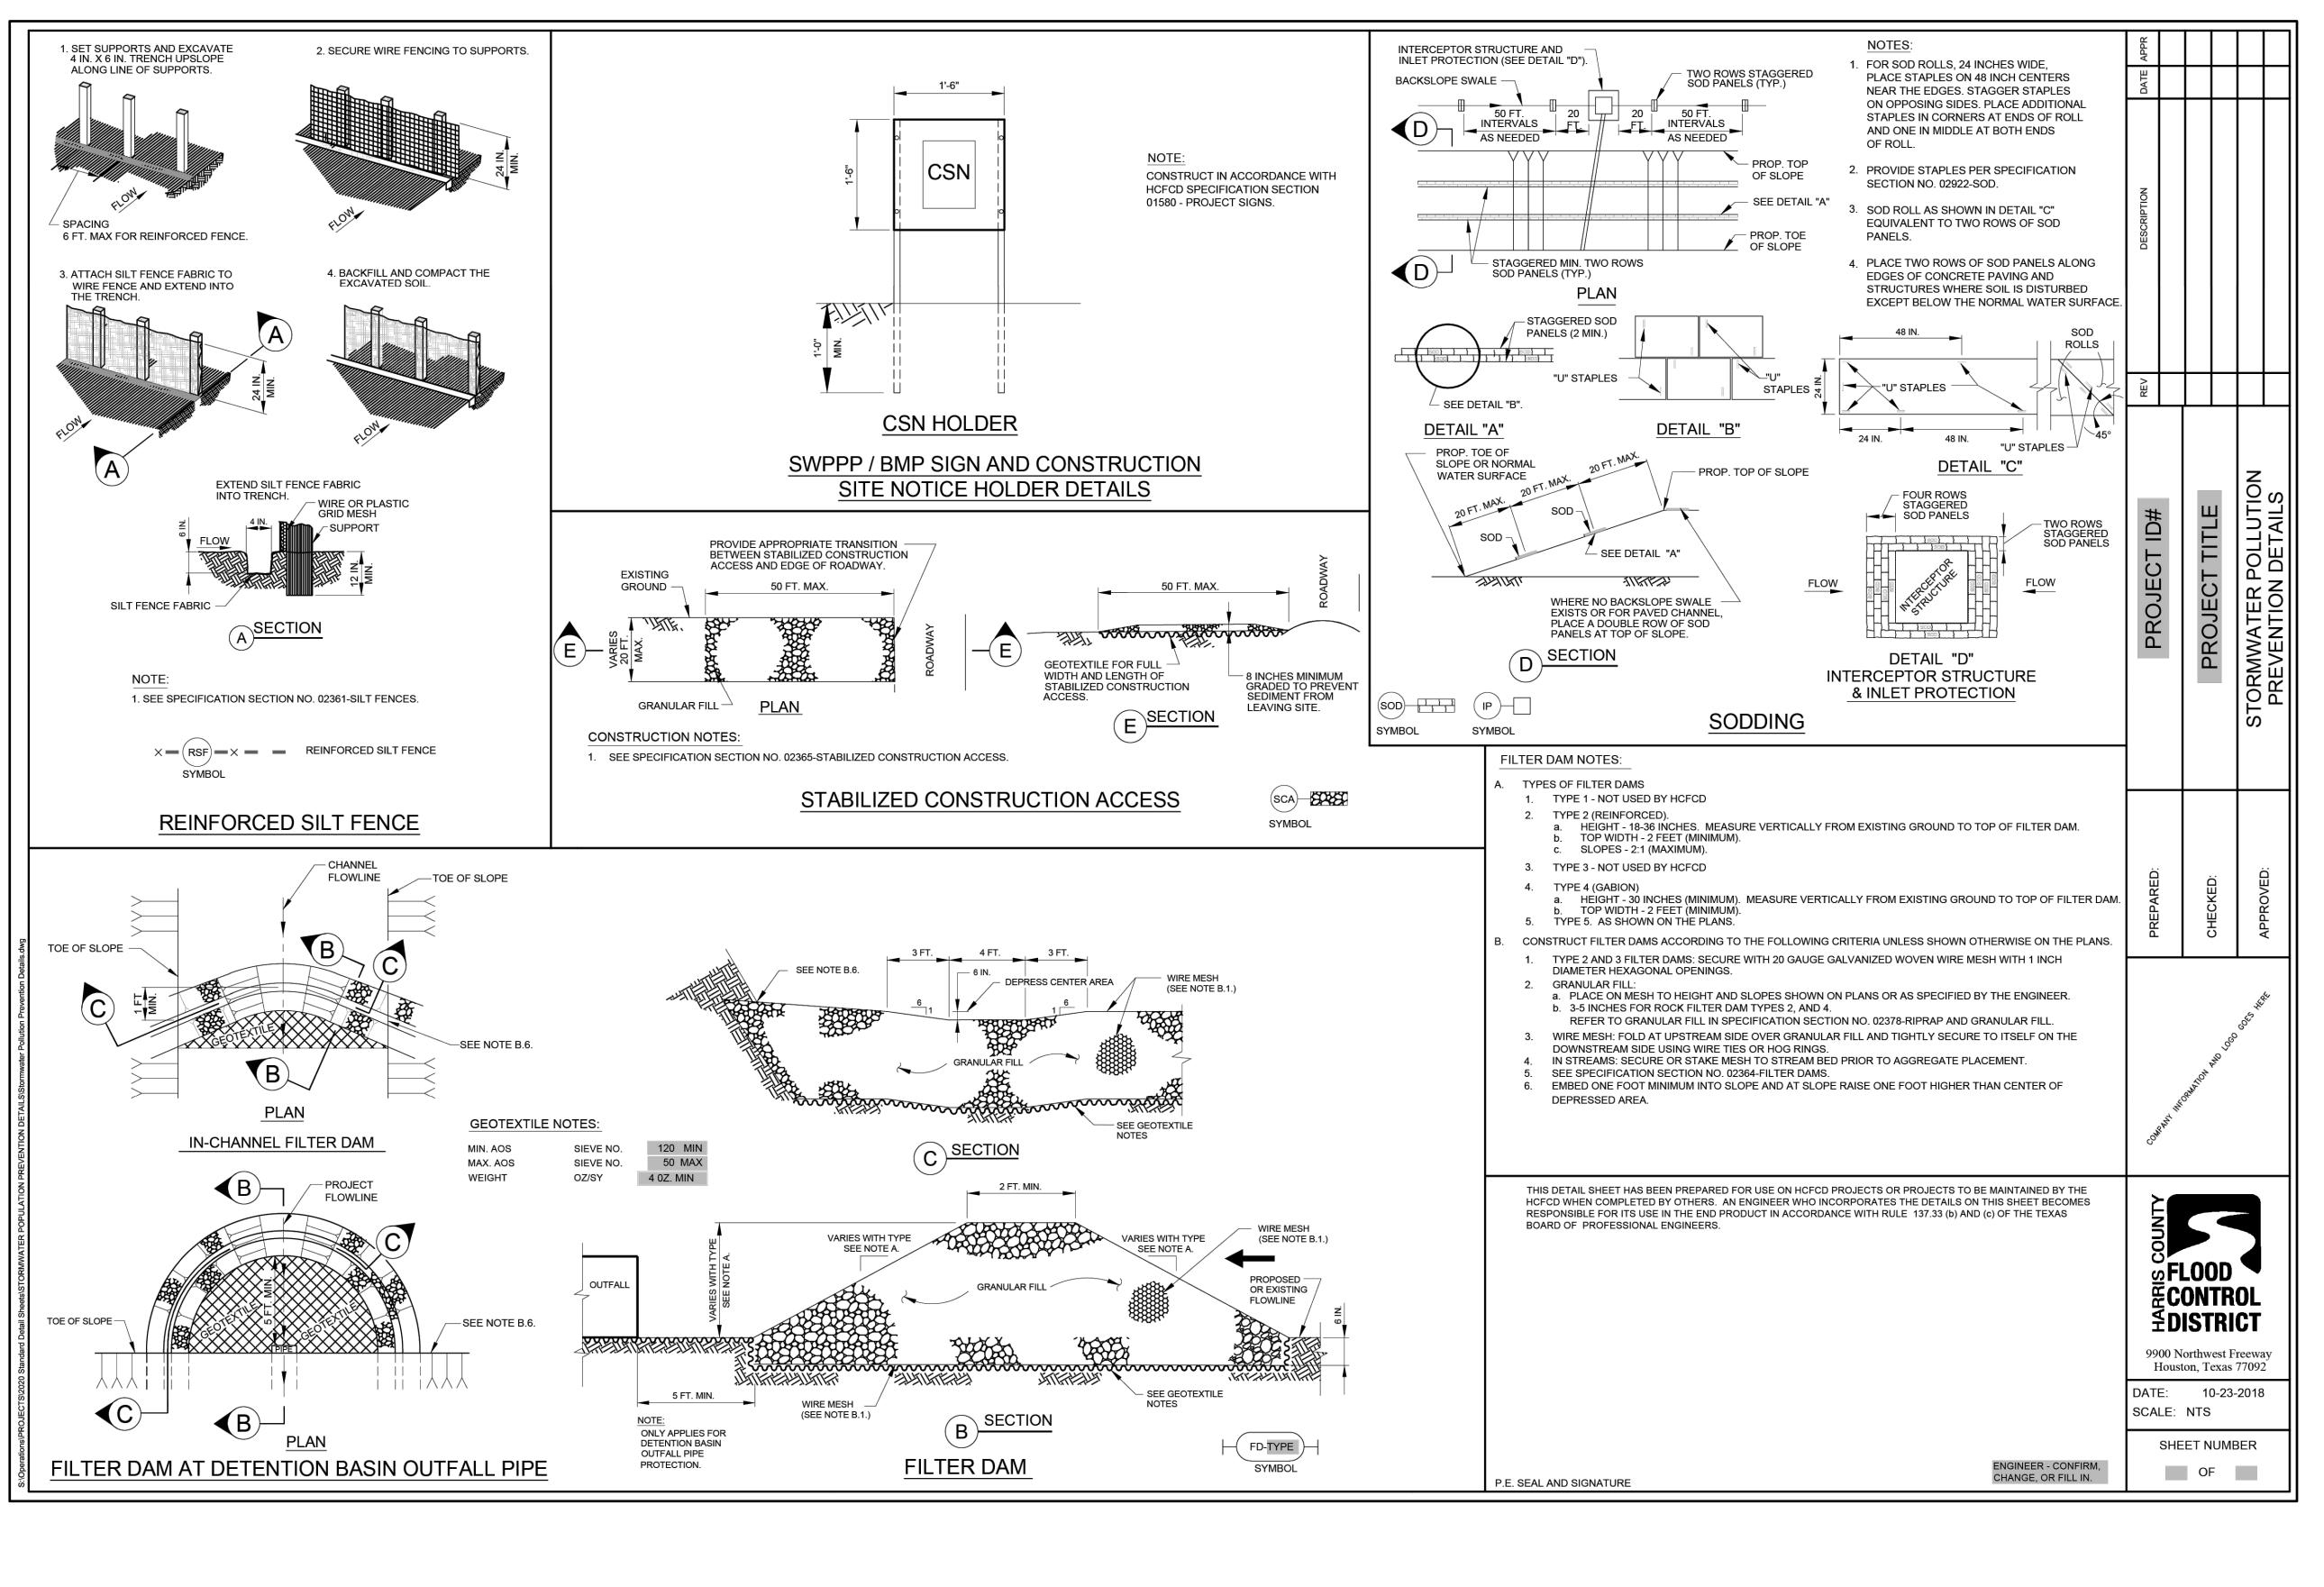
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ENGINEER: RAHUL B MENON, P.E
P.E. Reg No: 130533
DATE: JUNE 2025

CITY OF HOUSTON
HOUSTON PUBLIC WORKS

# SHARPSTOWN AREA DETENTION POND A

STORMWATER POLLUTION PREVENTION PLAN DETAILS CITY OF HOUSTON

| WBS NUMBER           | FOR CITY OF HOUSTON USE ONLY |
|----------------------|------------------------------|
| M-410040-001A-3      |                              |
| DRAWING SCALE        |                              |
| NTS                  |                              |
| CITY OF HOUSTON PM   |                              |
| SUPUN ILANGAMUDALIGE |                              |
| SHEET NO. 38 OF 42   |                              |



10448 Westoffice Drive Houston, Texas 77042 P 713 747 2399 F 713 748 3748

TBPE Firm Reg. #4575 SURVEYED BY: LANDTECH, INC. FB NO. P-6331

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NOT INTENDED FOR PERMIT BIDDING OR CONSTRUCTION ENGINEER: RAHUL B MENON, P.E. P.E. Reg No: 130533

DATE: JUNE 2025

CITY OF HOUSTON HOUSTON PUBLIC WORKS

## SHARPSTOWN AREA DETENTION POND A

STORMWATER POLLUTION PREVENTION PLAN DETAILS HARRIS COUNTY FLOOD CONTROL DISTRICT

| WBS NUMBER           | FOR CITY OF HOUSTON USE ONLY |
|----------------------|------------------------------|
| M-410040-001A-3      |                              |
| DRAWING SCALE        |                              |
| NTS                  |                              |
| CITY OF HOUSTON PM   |                              |
| SUPUN ILANGAMUDALIGE |                              |
| SHEET NO. 39 OF 42   |                              |

PLAN VIEW - INSTALLATION FOR PILE WORK

#### **NOTES:**

1. Select a floating turbidity curtain type to suit the site conditions and meet erosion control and water quality requirements. Submit details and specifications of the selected curtain type for approval prior to installation.

PROJECT

SHEET NUMBER

- 2. Install floating turbidity curtains before the start of any construction activities that could impact the area of concern.
- 3. Install floating turbidity curtains parallel to the direction of flow of a moving water body. Do not install curtains across the main flow of a significant moving water body. Do not install curtains where the flow of water will remove accumulated sediment or significantly move the curtain.
- 4. Install floating turbidity curtain stakes in a vertical position unless otherwise directed. Install anchors and stakes at no more than 100-foot spacing.
- 5. For Type 1 floating turbidity curtains, install anchors made of wooden stakes (2- by 4-inch rectangular or  $2\frac{1}{2}$ -inch minimum diameter) or metal stakes  $(1\frac{1}{3})$  pounds per linear foot). For Type 2 and 3 curtains, install anchors that are either weighted or that dig into the channel bottom.
- 6. Extend the ends of floating turbidity curtains well up into the shoreline as approved, especially if high water conditions are expected. Secure the ends firmly to the shoreline (preferably to rigid bodies such as trees or piles) to fully enclose the area where sediment may enter into the water body.
- 7. Provide minimum  $\frac{1}{2}$ -inch nylon rope for adjustment line for mooring system. Ensure the mooring line is securely attached and is sufficiently buoyant to remain afloat under normal load conditions.
- 8. For Type 1 and 2 floating turbidity curtains, extend the nylon reinforced vinyl fabric through the entire depth of the water (to the channel bottom) unless tidal actions are present.
- 9. In areas subject to wind and wave actions or where tidal actions are present, use Type 3 floating turbidity curtains as directed. Install Type 3 curtains according to the manufacturer's recommendations and as approved.
- 10. Remove captured sediment behind floating turbidity curtains prior to removing the curtains. Do not disperse sediment into adjacent water body.

U.S. DEPARTMENT OF TRANSPORTATION, FHWA OFFICE OF FEDERAL LANDS HIGHWAY

**FLOATING TURBIDITY CURTAINS** 

E157-11 SPECIFICATION FP-24, FP-14 APPROVED FOR USE 05/2024

**EFLHD DETAIL** 

HOUSTON, TX. 77094 281-945-0069 TX FIRM NUMBER: F-6932

FB NO. P-6331

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HOUSTON

### SHARPSTOWN AREA DETENTION POND A

STORMWATER POLLUTION PREVENTION PLAN DETAILS

| WBS NUMBER           | FOR CITY OF HOUSTON USE ONLY |
|----------------------|------------------------------|
| M-410040-001A-3      |                              |
| DRAWING SCALE        |                              |
| NTS                  |                              |
| CITY OF HOUSTON PM   |                              |
| SUPUN ILANGAMUDALIGE |                              |
| SHEET NO. 40 OF 42   |                              |
|                      |                              |

NO SCALE

**USAGE CHART** MAXIMUM CURRENT ADDITIONAL CONDITIONS (FT/S) 0.0

3.5

5.0

TYPE

No Wave/Wind/Tidal Action Moving Water (One Direction) Tidal Action or Subject to Wind and Wave Actions

15021 KATY FREEWAY, STE. 500

OF INTERIM REVIEW UNDER THE AUTHORITY OF RODRIGO GUADARRAMA TEXAS REG. NO. 111437

PURPOSES

HOUSTON PUBLIC WORKS

FLOATING TURBIDITY CURTAIN

| \ Camanal Ham  |  | Summary of Quantities  |                                     |   |
|--|--|--|-------------------------------------|---|
| A. General Iter Item No.   | ms<br>Spec. Ref                                      | Item Description   | Unit of Measure                     | Estimated Quant                                 |
| 1  | 01502  | Mobilization   | LS                                  | 1   |
| 2  | 01555  | Traffic Control and Regulation   | LS                                  | 1   |
| 3  | 01555  | Flagmen-Uniformed Police Officers  | LS                                  | 1   |
| 4  | 01562  | Tree Mitigation (Cash Allowance due Parks - 6" to 11.99" on ROW)   | INCH                                | 30  |
| 5  | 01562  | Tree Mitigation (Cash Allowance due Parks - 12" and Larger in ROW)   | INCH                                | 969   |
| 6  | 01578  | Ground Water Control for Detention Pond and Open-Cut Construction  | LS                                  | 1   |
| 7  | 01570  | Filter Fabric Fence  | LF                                  | 2,378   |
| 8  | 01570  | Reinforced Filter Fabric Barrier   | LF                                  | 250   |
| 9  | 01570  | Bagged Gravel Barrier  | LF                                  | 500   |
| 10   | 01570  | Inlet Protection Barrier - Type II   | LF                                  | 632   |
| 11   | 01575  | Stabilized Construction Entrance/Exit  | SY                                  | 1,000   |
| 12   | 02260  | Trench Safety System for Storm Sewer ( Open -Cuts)   | LF                                  | 17,418  |
| 13   | 02921  | Hydro Mulch Seeding  | AC                                  | 4   |
| 14   | 02922  | Sodding  | SY                                  | 3,600   |
| 15   | HCFCD 2399-02  | Floating Turbidity Curtains  | LF                                  | 90  |
| 16   | HCFCD 2399-03  | Rock Filter Dam - Type 2   | LF                                  | 70  |
| 3. Storm Sewei   |  |  |                                     |   |
| Item No.   | Spec. Ref  | Item Description   | Unit of Measure                     | Estimated Quan                                  |
| 1  | 02631  | 4FT x 4FT Precast Box Manhole  | EA                                  | 1   |
| 2  | 02631  | 18-Inch Diameter RCP Arch-Pipe Storm Sewers (Trenchless)   | LF                                  | 418   |
| 3  | 02631  | 24-Inch RCP Storm Pipe (Open-Cut) (All Depths)   | LF                                  | 125   |
| 4  | 02631  | Backslope Drainage Interceptor Pipe, 24-Inch CMP   | LF                                  | 656   |
| 5  | 2633   | Backslope Drainage Interceptor Structure, COH TYPE ' A" Inlets   | EA                                  | 6   |
| 6  | SPEC REF   | Proposed 24-Inch Diameter Flap Gate  | EA                                  | 1   |
| 7  | 02221  | Remove/ Dispose Storm Pipe 48-Inch Diameter  | LF                                  | 120   |
| 8  | 02221  | Cut Plug and Abandon existing 18-inch Storm  | EA                                  | 4   |
| 9  | 02221  | Cut Plug and Abandon existing 24-Inch Storm Sewers   | EA                                  | 4   |
| 10   | 02221  | Cut Plug and Abandon existing 48-Inch Storm Sewers   | EA                                  | 2   |
| 11   | 02631  | 15-inch Brick Plugs  | EA                                  | 3   |
| 12   | 02631  | 18-inch Brick Plugs  | EA                                  | 3   |
| 13   | 02631  | 24-inch Brick Plugs  | EA                                  | 19  |
| 14   | 02631  | 48-inch Brick Plugs  | EA                                  | 2   |
| C. Water Items   |  |  |                                     |   |
| Item No.   | Spec. Ref  | Item Description   | Unit of Measure                     | Estimated Quan                                  |
| 1  | 02511  | 8-Inch Water Line Adjustment (including , cutting , installing new restrained joint pvc pipe, and  | EA                                  | 5   |
|  | 02311  | removal of old pipe  | LA LA                               | 3   |
| 2  | 02516  | Cut ,Plug and Abandon Existing 8-Inch Water Lines  | EA                                  | 5   |
| D. Detention Po  | ond A  |  |                                     |   |
| Item No.   | Spec. Ref  | Item Description   | Unit of Measure                     | Estimated Quan                                  |
| 1  | SP   | Demolition (Excluding Trees)   | LS                                  | 1   |
| 2  | SP   | Pond Excavation and Disposal   | CY                                  | 106,390   |
| 3  | SP   | 8-Inch Thick Concrete Weir   | SY                                  | 1,018   |
| 4  | SP   | 18-Inch Thick Riprap   | SY                                  | 1,300   |
| 5  | SP   | 2-Feet Thick Clay Liner  | CY                                  | 9,353   |
| 6  | SP   | Perimeter Backslope Drainage Swale   | LF                                  | 1,767   |
| 7  | HCFCD 2832   | Pilot Channel Concrete Swale (Complete in Place)   | LF                                  | 790   |
| 8  | SP   | 12-Inch Concrete Slope Paving  | CY                                  | 605   |
|  | SP   | 12-Inch Cement Stablized Sand (Beneath Spillway)   | CY                                  | 320   |
| 9  |  | 12 Inch Crovel Fill (Penceth Spillwey)   | CY                                  | 195   |
|  | SP   | 12-Inch Gravel Fill (Beneath Spillway)   |                                     |   |
| 9  | SP<br>01578  | Ground Water Control   | LS                                  | 1   |
| 9  |  |  |                                     | 1   |
| 9<br>10<br>11  |  |  |                                     |   |
| 9<br>10<br>11<br>E. Tree Items   | 01578  | Ground Water Control   | LS                                  |   |
| 9<br>10<br>11<br>E. Tree Items<br>Item No.                               | 01578<br>Spec. Ref                                   | Ground Water Control  Item Description   | LS Unit of Measure                  | Estimated Quan                                  |
| 9<br>10<br>11<br>E. Tree Items<br>Item No.                               | 01578<br>Spec. Ref<br>01562                          | Ground Water Control  Item Description  Remove Tree 0" to 11.99" (or Palm Tree)  | Unit of Measure                     | Estimated Quan                                  |
| 9<br>10<br>11<br>E. Tree Items<br>Item No.<br>1                          | 01578  Spec. Ref 01562 01563                         | Ground Water Control  Item Description  Remove Tree 0" to 11.99" (or Palm Tree)  Remove Teee 12" to 29.99"   | Unit of Measure EA EA               | Estimated Quan                                  |
| 9 10 11 E. Tree Items Item No. 1 2 3                                     | 01578  Spec. Ref 01562 01563 01564                   | Ground Water Control  Item Description  Remove Tree 0" to 11.99" (or Palm Tree)  Remove Teee 12" to 29.99"  Remove Tree 30" to 45"   | Unit of Measure  EA  EA  EA         | Estimated Quan                                  |
| 9<br>10<br>11<br>E. Tree Items<br>Item No.<br>1<br>2<br>3<br>4           | 01578  Spec. Ref 01562 01563 01564 01565             | Ground Water Control  Item Description  Remove Tree 0" to 11.99" (or Palm Tree)  Remove Teee 12" to 29.99"  Remove Tree 30" to 45"  Clearance Prune Trees  | Unit of Measure  EA  EA  EA  EA  EA | Estimated Quan  11  40  13  7                   |
| 9<br>10<br>11<br>E. Tree Items<br>Item No.<br>1<br>2<br>3<br>4<br>5<br>6 | 01578  Spec. Ref 01562 01563 01564 01565 01566 01567 | Ground Water Control  Item Description  Remove Tree 0" to 11.99" (or Palm Tree)  Remove Teee 12" to 29.99"  Remove Tree 30" to 45"  Clearance Prune Trees  Install Tree Protection Fence (up to 5000 ft)   | Unit of Measure  EA  EA  EA  EA  LF | Estimated Quan  11  40  13  7  2,560            |
| 9 10 11 E. Tree Items Item No. 1 2 3 4 5 6                               | 01578  Spec. Ref 01562 01563 01564 01565 01566 01567 | Ground Water Control  Item Description  Remove Tree 0" to 11.99" (or Palm Tree)  Remove Teee 12" to 29.99"  Remove Tree 30" to 45"  Clearance Prune Trees  Install Tree Protection Fence (up to 5000 ft)  Install Tree Protection Fence (beyond 5000 ft) | Unit of Measure  EA  EA  EA  LF  LF | Estimated Quan  11  40  13  7  2,560  675       |
| 9<br>10<br>11<br>E. Tree Items<br>Item No.<br>1<br>2<br>3<br>4<br>5      | 01578  Spec. Ref 01562 01563 01564 01565 01566 01567 | Ground Water Control  Item Description  Remove Tree 0" to 11.99" (or Palm Tree)  Remove Teee 12" to 29.99"  Remove Tree 30" to 45"  Clearance Prune Trees  Install Tree Protection Fence (up to 5000 ft)   | Unit of Measure  EA  EA  EA  EA  LF | Estimated Quant<br>11<br>40<br>13<br>7<br>2,560 |

Remove Sign with Pole, with/or without Foundation

CITY OF HOUSTON PROJECT SIGN

EΑ

EA

20

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FB NO. P-6331

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TEXAS REG. NO. 111437
OCTOBER 15, 2025

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# CITY OF HOUSTON HOUSTON PUBLIC WORKS

SHARPSTOWN AREA DETENTION POND A

SUMMARY OF QUANTITIES

|    | WBS NUMBER                | FOR CITY OF HOUSTON USE ONL           |
|----|---------------------------|---------------------------------------|
|    | M-410040-001A-4           |                                       |
|    | DRAWING SCALE             |                                       |
|    | AS NOTED                  |                                       |
|    | CITY OF HOUSTON PM        |                                       |
|    | SUPUN ILANGAMUDALIGE P.E. |                                       |
| 20 | SHEET NO. 41 OF 42        |                                       |
|    |                           | · · · · · · · · · · · · · · · · · · · |

HCFCD

HDPE

HGL

| ABBREVIATIONS:   |   |  |  |  |
|--|---|--|--|--|
|  |   |  |  |  |
| &:  @ AB AC AI/VR APPROX ASPH AVE  | AND AT ALL BELL ACRE / ASBESTOS CEMENT AIR INLET / VACUUM RELIEF APPROXIMATELY ASPHALT AVENUE   |  |  |  |
| BE<br>B/B<br>BC<br>BFV<br>BL<br>BLDG<br>BLVD                                     | BASELINE BACK TO BACK BACK OF CURB BUTTERFLY VALVE BUILDING LINE BUILDING BOULEVARD   |  |  |  |
| ©C/C<br>CGMP<br>CMP<br>CIP<br>CLR<br>CO<br>COH<br>CONC<br>CONSTR<br>CPEE<br>CPEG | CENTER LINE CENTER TO CENTER CORRUGATED GALVANIZED METAL PIPE CORRUGATED METAL PIPE CAST IRON PIPE CLEARANCE CLEAN OUT CITY OF HOUSTON CONCRETE CONSTRUCTION CENTERPOINT ENERGY ELECTRIC CENTERPOINT ENERGY GAS |  |  |  |
| DIA<br>DIP<br>DR<br>DWG<br>DWY   | DIAMETER DUCTILE IRON PIPE DRIVE DRAWING DRIVEWAY   |  |  |  |
| E<br>EL<br>EP<br>E/R<br>ESMT<br>EXST   | EAST ELEVATION EDGE OF PAVEMENT END OF RADIUS EASEMENT EXISTING   |  |  |  |
| FC<br>F/F<br>FH<br>FL<br>FM<br>FT  | FACE OF CURB FACE TO FACE FIRE HYDRANT FLOW LINE FORCE MAIN FEET  |  |  |  |
| GPS<br>GV<br>GV&B  | GLOBAL POSITIONING SYSTEM<br>GATE VALVE<br>GATE VALVE AND BOX   |  |  |  |
| HCECD  | HADDIS COLINTY FLOOD CONTDOL DISTRICT   |  |  |  |

HARRIS COUNTY FLOOD CONTROL DISTRICT

HIGH-DENSITY POLYETHYLENE

HYDRAULIC GRADE LINE

INTERMEDIATE PRESSURE

HIGH PRESSURE

INVERT ELEVATION

IRON ROD

#### **ABBREVIATIONS:**

| J-BOX JT JOINT JUNCT JUNCTION  LF LINEAR FEET LN LANE LPT LOW POINT LT LEFT LS LIFT STATION  MAX MAXIMUM METRO METROPOLITAN TRANSIT AUTHORITY MH MANHOLE MIN MINIMUM MON MONUMENT  N NORTH NA NOT APPLICABLE |                    |
|--|--------------------|
| LF LINEAR FEET LN LANE LPT LOW POINT LT LEFT LS LIFT STATION  MAX MAXIMUM METRO METROPOLITAN TRANSIT AUTHORITY MH MANHOLE MIN MINIMUM MON MONUMENT  N NORTH NA NOT APPLICABLE                                |                    |
| LF LINEAR FEET LN LANE LPT LOW POINT LT LEFT LS LIFT STATION  MAX MAXIMUM METRO METROPOLITAN TRANSIT AUTHORITY MH MANHOLE MIN MINIMUM MON MONUMENT  N NORTH NA NOT APPLICABLE                                |                    |
| LN LANE LPT LOW POINT LT LEFT LS LIFT STATION  MAX MAXIMUM METRO METROPOLITAN TRANSIT AUTHORITY MH MANHOLE MIN MINIMUM MON MONUMENT  N NORTH NA NOT APPLICABLE   |                    |
| LN LANE LPT LOW POINT LT LEFT LS LIFT STATION  MAX MAXIMUM METRO METROPOLITAN TRANSIT AUTHORITY MH MANHOLE MIN MINIMUM MON MONUMENT  N NORTH NA NOT APPLICABLE   |                    |
| LPT LOW POINT LT LEFT LS LIFT STATION  MAX MAXIMUM METRO METROPOLITAN TRANSIT AUTHORITY MH MANHOLE MIN MINIMUM MON MONUMENT  N NORTH NA NOT APPLICABLE   |                    |
| LT LS LIFT STATION  MAX MAXIMUM METRO METROPOLITAN TRANSIT AUTHORITY MH MANHOLE MIN MINIMUM MON MONUMENT  N NORTH NA NOT APPLICABLE  |                    |
| LIFT STATION  MAX  MAXIMUM  METRO  METROPOLITAN TRANSIT AUTHORITY  MH  MANHOLE  MIN  MINIMUM  MON  MONUMENT  N  N  NORTH  NA  NOT APPLICABLE   |                    |
| MAX MAXIMUM METRO METROPOLITAN TRANSIT AUTHORITY MH MANHOLE MIN MINIMUM MON MONUMENT  N NORTH NA NOT APPLICABLE  |                    |
| METRO METROPOLITAN TRANSIT AUTHORITY MH MANHOLE MIN MINIMUM MON MONUMENT  N NORTH NA NOT APPLICABLE  |                    |
| METRO METROPOLITAN TRANSIT AUTHORITY MH MANHOLE MIN MINIMUM MON MONUMENT  N NORTH NA NOT APPLICABLE  |                    |
| MH MANHOLE MIN MINIMUM MON MONUMENT  N NORTH NA NOT APPLICABLE   |                    |
| MIN MINIMUM MON MONUMENT  N NORTH NA NOT APPLICABLE  |                    |
| MON MONUMENT  N NORTH NA NOT APPLICABLE  |                    |
| N NORTH NA NOT APPLICABLE  |                    |
| NA NOT APPLICABLE  |                    |
| NA NOT APPLICABLE  |                    |
|  |                    |
| NAVD NORTH AMERICAN VERTICAL DATUM   |                    |
| NG NATURAL GROUND  |                    |
| NO NUMBER  |                    |
| NTS NOT TO SCALE   |                    |
| NOT TO SOALL   |                    |
| OCC ZERO CURB CUT  |                    |
| OS OFFSET  |                    |
| OH OVERHEAD  |                    |
| PC POINT OF CURVE  |                    |
| PCC POINT OF COMPOUND CURVATURE  |                    |
| PCCP PRESTRESSED CONCRETE CYLINDER PIPE  | F                  |
| PERM PERMANENT   | L                  |
| PGL PROFILE GRADE LINE   |                    |
| PI POINT OF INTERSECTION   |                    |
| PL PROPERTY LINE   |                    |
| PNT POINT  |                    |
| PPCA POTENTIALLY PETROLEUM CONTAMINATED  | ADEA               |
| PRC POINT OF REVERSE   | ANLA               |
| PROP PROPOSED  |                    |
| PSI POUND PER SQUARE INCH  |                    |
| PT POINT OF TANGENCY   |                    |
|  | VEDTICAL OUDVATURE |
| PVC POLYVINYL CHLORIDE PIPE / POINT OF   | VERTICAL CURVATURE |
| PVMT PAVEMENT  |                    |
| PVI POINT OF VERTICAL INTERSECTION   |                    |
| PVT POINT OF VERTICAL TANGENCY   |                    |

RECORD DRAWING RCB RCP RD REINF REM REINFORCED CONCRETE BOX REINFORCED CONCRETE PIPE ROAD REINFORCED REMOVABLE RJ ROW RESTRAINED JOINT RIGHT OF WAY RAILROAD RRPM REFLECTIVE REMOVABLE PAVEMENT MARKERS SOUTH SANITARY

SAN SCHED SF SHT SSE ST SCHEDULE SQUARE FEET SHEET SANITARY SEWER EASEMENT STREET STATION

**ABBREVIATIONS:** 

STA STD STL STM SWBT STANDARD STEEL STORM SOUTHWESTERN BELL TELEPHONE

SWR SY SEWER SQUARE YARD

TAN
TBM
TEMP
TOB
TOC
TOP
TOS
TS&V **TANGENT** TEMPORARY BENCHMARK TEMPORARY TOP OF BANK TOP OF CURB TOP OF PAVEMENT TOP OF STACK

TAPPING SLEEVE AND VALVE TXDOT TYP TEXAS DEPARTMENT OF TRANSPORTATION TYPICAL

UE UGND UTILITY EASEMENT

UNDERGROUND

VC VERTICAL CURVE VERTICAL POINT OF INTERSECTION VPI

WEST WITH WATER LINE WLE WATER LINE EASEMENT WM WATER METER WOOD POLE

WSEL WATER SURFACE ELEVATION WATER VALVE WV WASTE WATER TREATMENT PLANT

> 15021 KATY FREEWAY, STE. 500 HOUSTON, TX. 77094 281-945-0069

TX FIRM NUMBER: F-6932 SURVEYED BY: LANDTECH, INC. FB NO. P-6331

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## CITY OF HOUSTON

HOUSTON PUBLIC WORKS

SHARPSTOWN AREA DETENTION POND A

LEGENDS & ABBREVIATIONS

|   | WBS NUMBER                | FOR CITY OF HOUSTON USE ONLY |
|---|---------------------------|------------------------------|
|   | M-410040-001A-4           |                              |
|   | DRAWING SCALE             |                              |
|   | AS NOTED                  |                              |
|   | CITY OF HOUSTON PM        |                              |
|   | SUPUN ILANGAMUDALIGE P.E. |                              |
| 0 | SHEET NO. 42 OF 42        |                              |