

CERTIFICATE OF APPROPRIATENESS

Reviewed by the Houston Archaeological and Historical Commission

Application Date: 12/01/2025 HPO File#: HP2025_0181 ITEM#: XX

Applicant: Enrique Sanchez, owner

Property: 7718 Glenbrae Street, Glenbrook Valley

Significance: Contributing (includes potentially contributing), Glenbrook Valley

Proposal: Alteration -

- Replace 3 tall narrow fixed windows, North Elevation Windows on West Elevation are not working properly and could be dangerous in case of a fire, they are not energy efficient, and I can paint them grayish to match the rest of them

- Replace 2 smaller windows 1-over-1 single hung (Aluminum Mill Finished), on West Elevation (Aluminum Mill Finish or Gray Vinyl)
- Replace 1 window 1-over-1 single hung (Aluminum Mill Finished), on West Elevation (Aluminum Mill Finish or Gray Vinyl)
 Existing windows tall, narrow, vertical, are broken.
- Repair/ Replace existing wood board and batten siding, on West Elevation, South Elevation, East Elevation, with wood or with cementitious boards (wood grain) to match existing board and batten appearance.
- Repair/ Replace existing wood trim with wood or cementitious board (wood grain)
- Replace existing composition shingle roofing with same material.

ALL NEW WINDOWS MUST BE INSET 13/4 Inches - See Attached Window Diagram

1-over-1 Windows Must Be Equally Horizontally Divided

ALL CEMENTITIOUS BOARD MUST BE SMOOTH

Public Comments			
- No Comments			

Civic Association			
- No Comments			

Recommendation: Approval With Conditions:

- Proposed Siding Must be Wood
- Retain Extension Wall from NE corner of House
- Remove Proposed NE Driveway

HAHC Action:

Basis for Issuance: HAHC Review



CERTIFICATE OF APPROPRIATENESS

Reviewed by the Houston Archaeological and Historical Commission

Date Effective:	

Note: All materials in exterior walls, including windows, siding, framing lumber, and interior shiplap must be retained except where removal or replacement has been explicitly approved by HAHC. Shiplap is an integral structural component of the exterior wall assembly in balloon framed structures and its removal can cause torqueing, twisting and collapse of exterior walls. Shiplap may be carefully shored and removed in small portions to insulate, run wire or plumbing, and should be replaced when the work is complete. Maintenance and minor in-kind repairs of exterior materials may be undertaken without HAHC approval, but if extensive damage of any exterior wall element is encountered during construction, contact staff before removing or replacing the materials. A revised COA may be required.

APPROVAL CRITERIA

ALTERATIONS, REHABILITATIONS, RESTORATIONS AND ADDITIONS

Sec. 33-241: HAHC shall issue a certificate of appropriateness for the alteration, rehabilitation, restoration or addition of an exterior feature of (i) any landmark, (ii) protected landmark, (iii) any building, structure or object that is part of an archaeological site, or (iv) contributing building in a historic district upon finding that the application satisfies the following criteria, as applicable:

Approval Criteria Status	Approval Criteria Description	
	(1) The proposed activity must retain and preserve the historical character of the property;	
	(2) The proposed activity must contribute to the continued availability of the property for a contemporary use;	


APPROAL CRITERIA


ALTERATIONS, REHABILITATIONS, RESTORATIONS AND ADDITIONS


Sec. 33-241: HAHC shall issue a certificate of appropriateness for the alteration, rehabilitation, restoration or addition of an exterior feature of (i) any landmark, (ii) protected landmark, (iii) any building, structure or object that is part of an archaeological site, or (iv) contributing building in a historic district upon finding that the application satisfies the following criteria, as applicable:

S	D	NA		S - satisfies D - does not satisfy NA - not applicable
\boxtimes			(1)	The proposed activity must retain and preserve the historical character of the property;
\boxtimes			(2)	The proposed activity must contribute to the continued availability of the property for a contemporary use;
			(3)	The proposed activity must recognize the building, structure, object or site as a product of its own time and avoid alterations that seek to create an earlier or later appearance;
\boxtimes			(4)	The proposed activity must preserve the distinguishing qualities or character of the building, structure, object or site and its environment;
\boxtimes			(5)	The proposed activity must maintain or replicate distinctive stylistic exterior features or examples of skilled craftsmanship that characterize the building, structure, object or site;
			(6)	New materials to be used for any exterior feature excluding what is visible from public alleys must be visually compatible with, but not necessarily the same as, the materials being replaced in form, design, texture, dimension and scale;
			(7)	The proposed replacement of exterior features, if any, should be based on an accurate duplication of features, substantiated by available historical, physical or pictorial evidence, where that evidence is available, rather than on conjectural designs or the availability of different architectural elements from other structures;
\boxtimes			(8)	Proposed additions or alterations must be done in a manner that, if removed in the future, would leave unimpaired the essential form and integrity of the building, structure, object or site;
			(9)	The proposed design for any exterior alterations or addition must not destroy significant historical, architectural, archaeological or cultural material, including but not limited to siding, windows, doors and porch elements;
\boxtimes			(10)	The proposed alteration or addition must be compatible with the massing, size, scale material and character of the property and the context area; and
\boxtimes			(11)	The distance from the property line to the front and side walls, porches, and exterior features of any proposed addition or alteration must be compatible with the distance to the property line of similar elements of existing contributing structures in the context area.



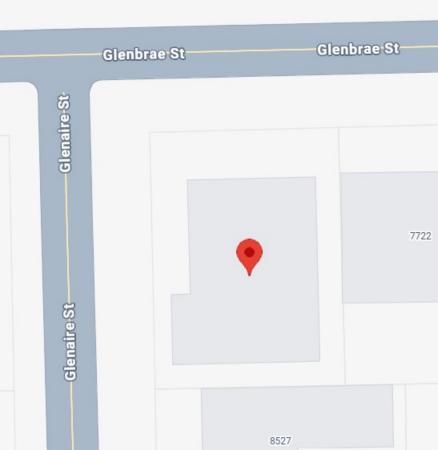

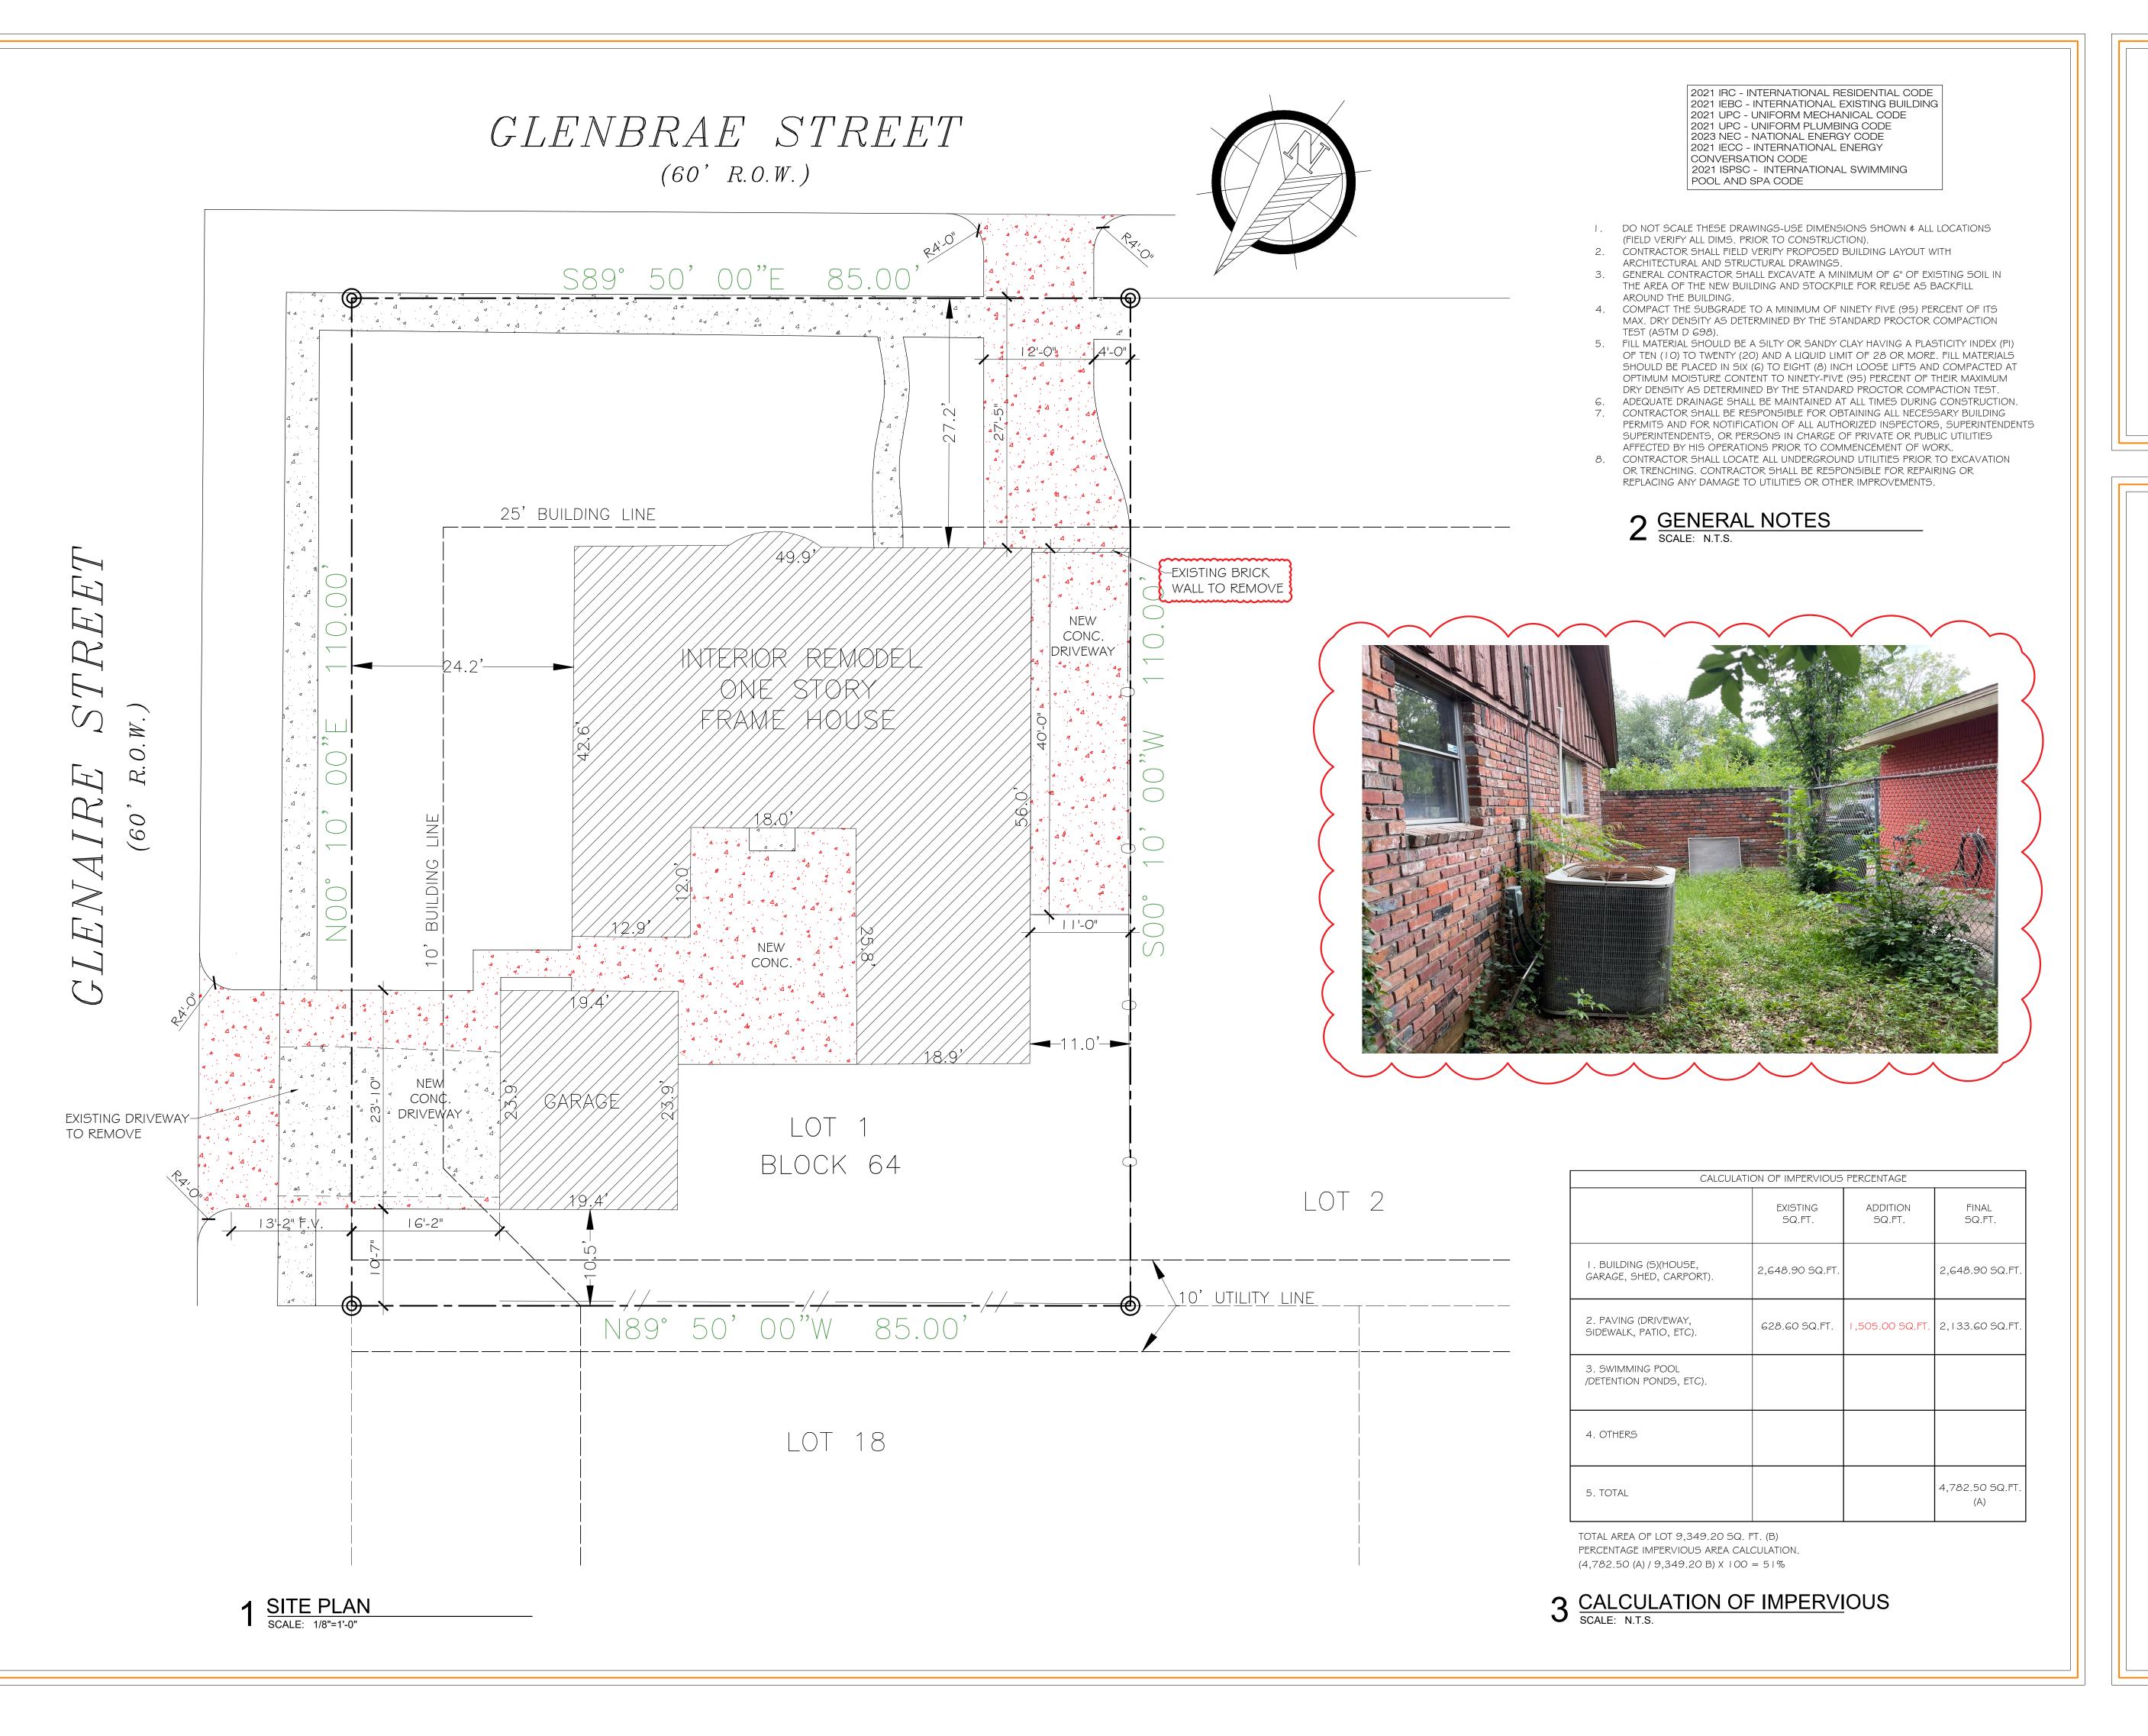

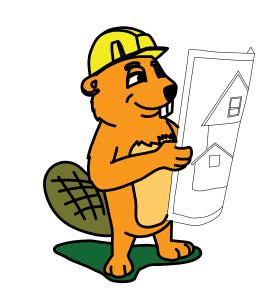

BEAVER'S DESIGN

(956) 662—3317 beavers.design@outlook.com

> INTERIOR REMODEL 7718 GLENBRAE STREET HOUSTON, TX 77061

ISSUE LOG			
	DATE	DESCRIPTION	
PRE			
РМТ			
Λ			
2			
3			

PROJECT NO:

CHECKED BY:


DATE OF ISSUE:

SHEET No.

SITE PLAN

SHEET No.

C1.0

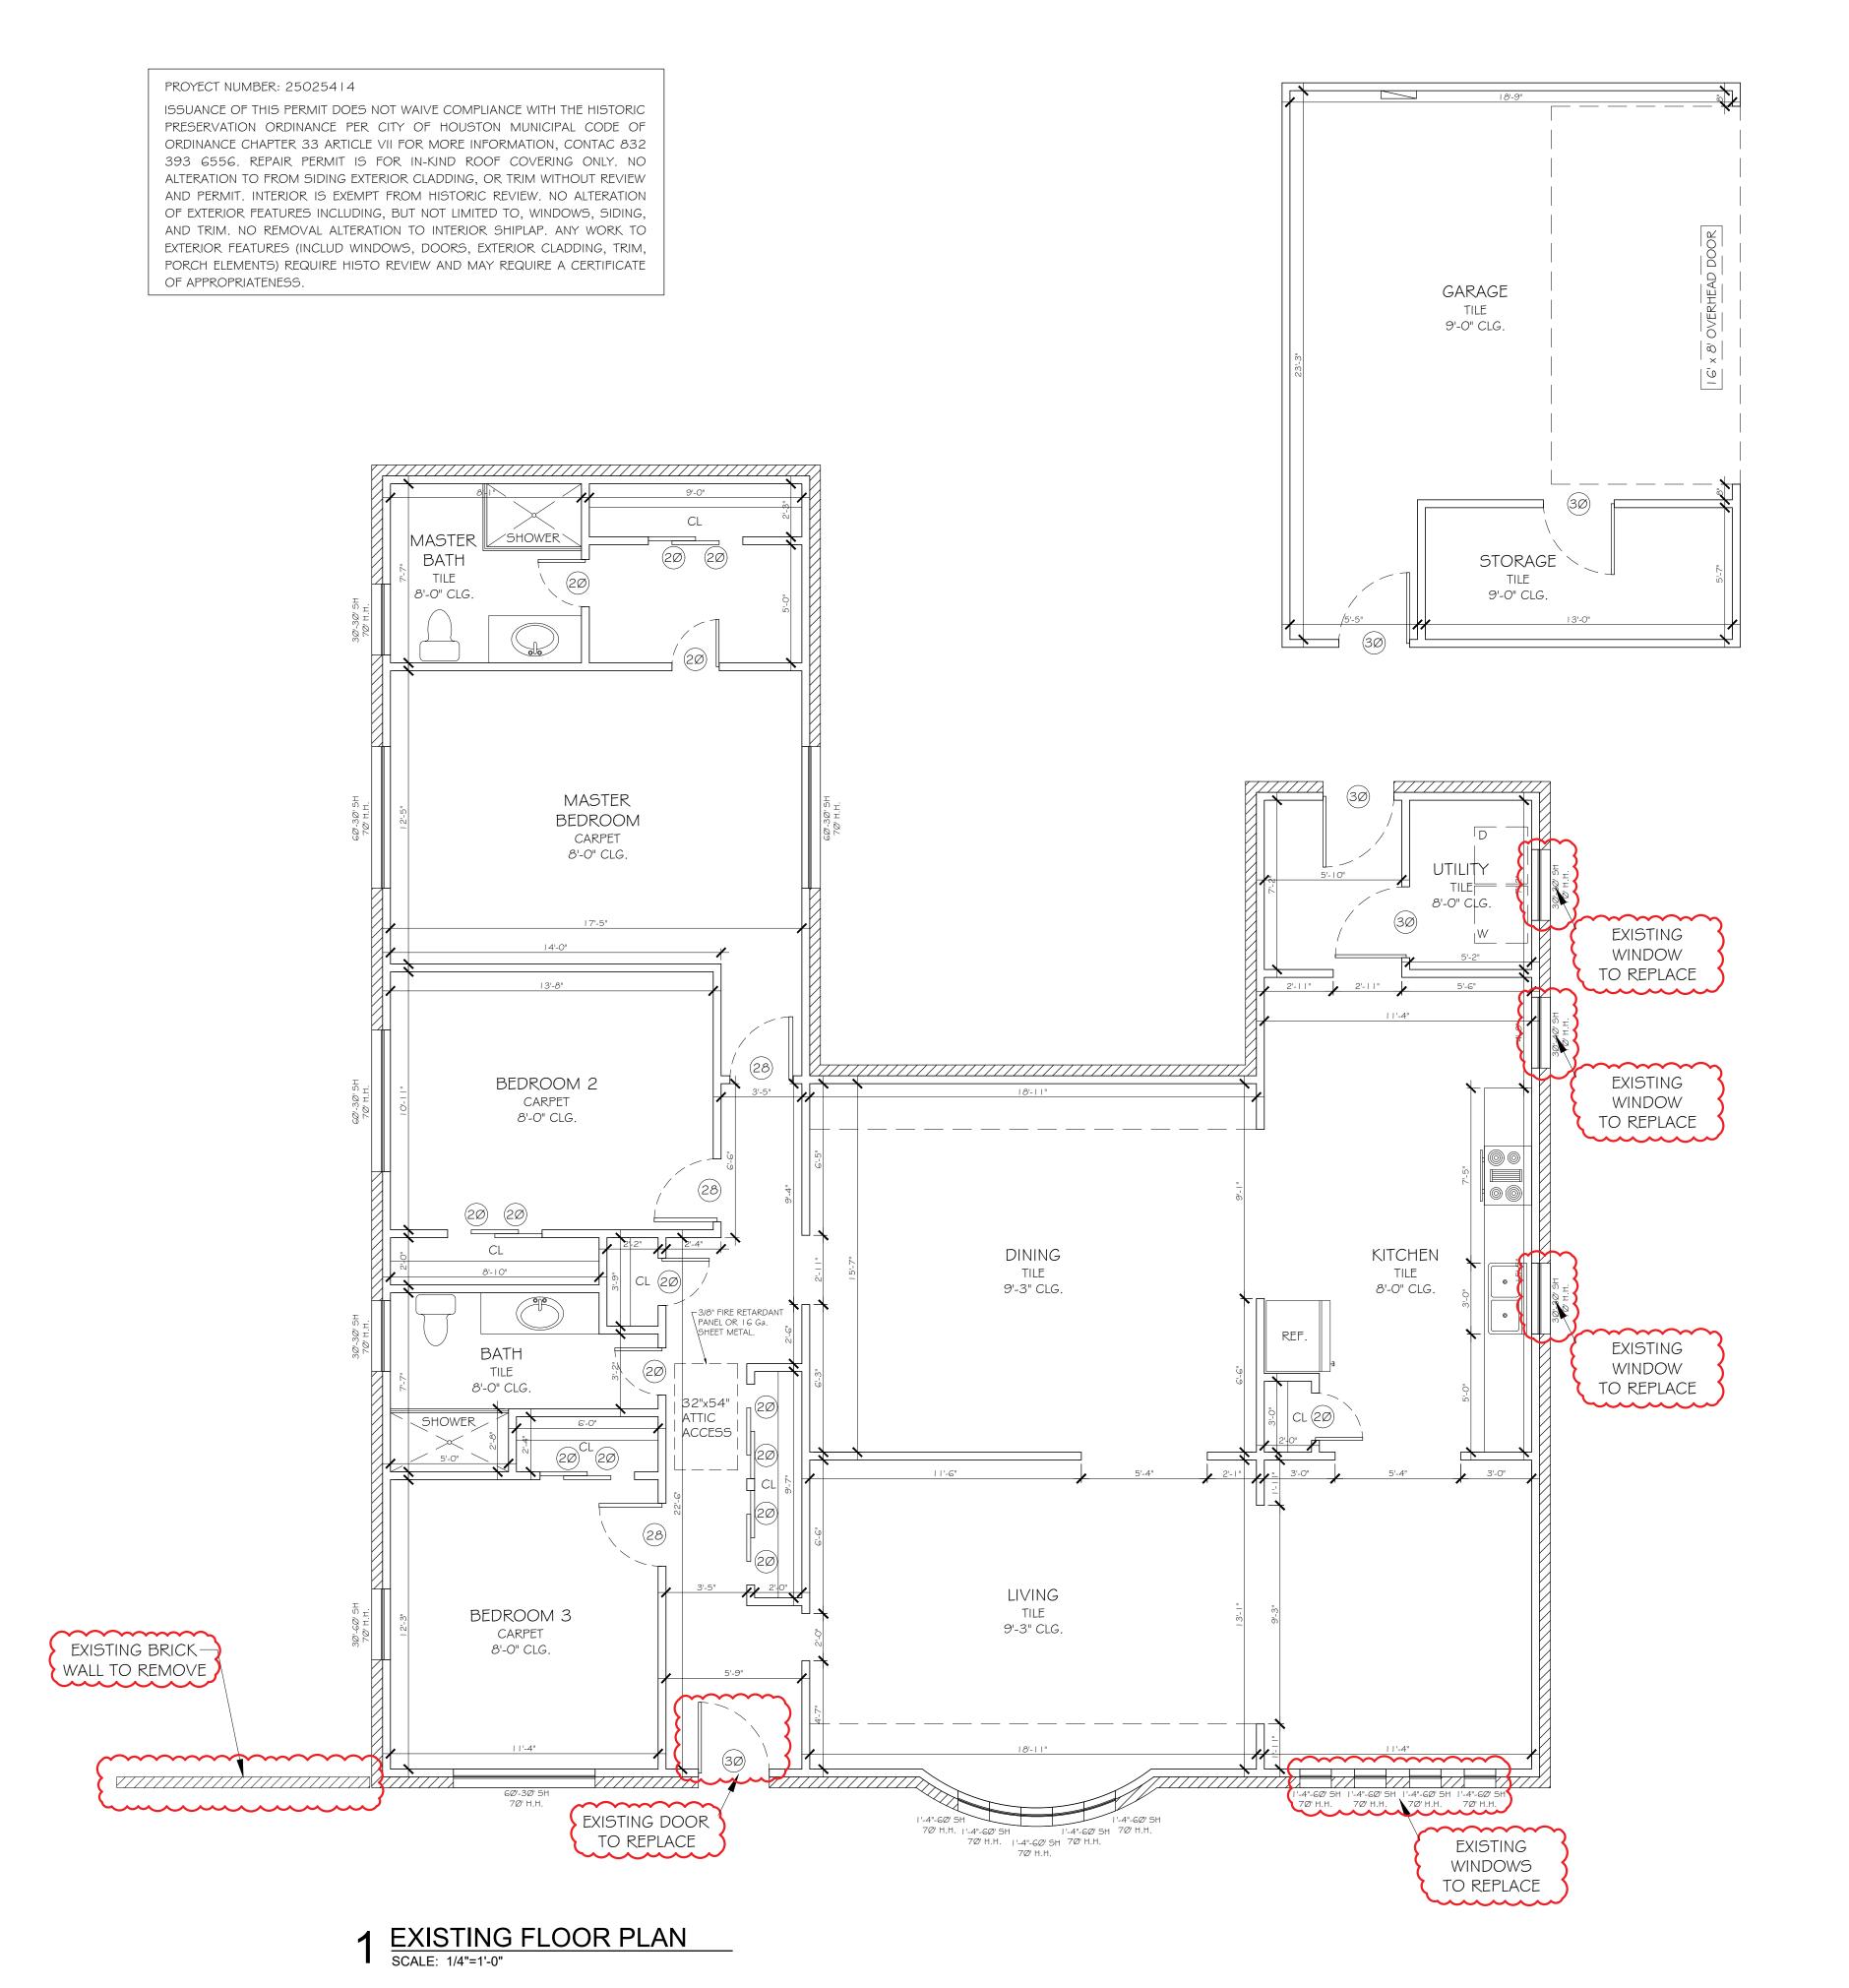

DO NOT SCALE-OFF DIRECTLY FROM DRAWING.
CONTRACTOR SHALL FIELD VERIFY DIMENSIONS.


- I. ALL CONSTRUCTION SHALL BE PERFORMED IN ACCORDANCE WITH APPLICABLE CODES, INCLUDING THE INTERNATIONAL BUILDING CODE AND CITY CODES. THE DRAWINGS AND SPECIFICATIONS ARE AN OUTLINE OF THE MINIMUM MATERIAL REQUIREMENTS AND THEIR APPLICATION.
- 2. BEFORE COMMENCING WORK, CONTRACTOR SHALL PERFORM A SURVEY OF EXISTING CONDITIONS IN ORDER TO VERIFY ACCURACY OF DIMENSIONS AND CONDITIONS SHOWN ON THE DRAWING WITH ACTUAL CONDITIONS. CONTRACTOR SHALL NOTIFY THE OWNER IMMEDIATELY OF ANY PROBLEMS FOUND THAT MAY AFFECT THE WORK. PROCEEDING WITH THE WORK SHALL CONSTITUTE ACCEPTANCE BY THE CONTRACTOR THAT CONDITIONS ARE CORRECT AND THE CONTRACTOR ASSUMES FULL RESPONSIBILITY FOR CONDITIONS.
- 3. ALL CONSTRUCTION SHALL BE COMPLETE, FINISHED, AND OF THE HIGHEST WORKMANSHIP. ALL CONSTRUCTION SHALL BE PERFORMED IN ACCORDANCE WITH THE REQUIREMENTS AND SPECIFICATIONS OF THE OWNER AND DESIGNER.
- 4. APPROVED PLANS AND SPECIFICATIONS SHALL NOT BE MODIFIED NOR CHANGED WITHOUT AUTHORIZATIONS FROM THE BUILDING OFFICIAL.
- I. THE CONSTRUCTION OF THIS DWELLING MUST COMPLY WITH INTERNATIONAL RESIDENTIAL CODE DO NOT SCALE-OFF DIRECTLY FROM DRAWING. CONTRACTOR SHALL VERIFY AND WORK WITH DIMENSIONS SHOWN. ALL DIMENSION SHALL BE VERIFY IN SITE.
- 2. SINGLE HUNG ALUMINUM WINDOWS UNO 8'-Ø" HEADER HT. AT IØ' Ø" PLATE 7'-8" HEADER HT. AT. 9' Ø" PLATE 6'-8" HEADER HT. AT 8' Ø" PLATE
- 3. CHIMNEYS TO BE 2'-Ø" (MIN.) ABV. ANY ROOF LINE WITHIN A I Ø'-Ø"
- 4. THE ATTIC ACCESS STAIRWAY SHALL COMPLY WITH SECTION M 1305.1.3
 AS AMENDED: ACCESS SHALL BE PROVIDED WITH A PULL DOWN STAIRWAY
 WITH A CLEAR OPENING NOT LESS THAN 22 INCHES IN WIDTH AND LOAD
 CAPACITY OF NOT LESS THAN 350 POUNDS. THE PASSAGEWAY SHALL
 HAVE CONTINUOUS SOLID FLOORING IN ACCORDANCE WITH CHAPTER 5
 OF THE IRC. AND NO LESS THAN 24 INCHES WIDE. A LEVEL SERVICE
 SPACE AT LEAST 30 INCHES DEEP AND 30 INCHES WIDE SHALL BE PRESENT
 ALONG ALL SIDE OF THE APPLIANCE WHERE ACCESS IS REQUIRED. THE
 CLEAR ACCESS OPENING DIMENSIONS SHALL BE MINIMUM OF 20 INCHES
 BY 30 INCHES, WHERE SUCH DIMENSIONS ARE LARGE ENOUGH TO ALLOW
 REMOVAL OF THE LARGEST APPLIANCE.
- 6'-8" INTERIOR DOORS AT FIRST FLOOR
 WHERE WOOD FRAMING IS EXPOSED TO WATER SPLASHING, PROVIDE WATERPROOF PAPER FLASHING AND COUNTER FLASHING.
 SEE OWNER/CONTRACTOR FOR WINDOW MANUFACTURER AND STYLES. WINDOW SUPPLIER TO LOCATE SAFETY GLASS AS REQUIRED & CERTIFY ALL WINDOW TO COMPLY WITH I.B.C. I.R.C. AND ENERGY CODE. PROVIDE MASTIC WRAP. WATERPROOFING AND CAULK SURROUND FLASHING ABOVE WINDOWS AND COUNTER-FLASH AS REQUIRED
- 8. ALL GLAZING LOCATED IN DOORS TO BE SAFETY GLAZING
 9. HOUSEHOLD VENTING SHALL BE OUTSIDE DWELLING. PROVIDE VENTILATION AT ALL BATHS AND UTILITY ROOMS VIA NATURAL OR MECHANICAL MEANS CAPABLE OF FIVE AIR CHANGES PER HOUR AND IS VENTED DIRECTLY OUTSIDE WITH A POINT OF DISCHARGE MIN.
- 10. HVAC INSTALLATION, SIZING, LOCATION IS THE RESPONSIBILITY OF A/C CONTRACTORS
- I I. ALL LAVATORIES 2'-8" HIGH U.N.O.I 2. ALL SHEETROCK CORNER TO BE ROUNDED, EXCLUDING CORNERS AT
- WINDOW.

 13. CROSS VENTILATION AT ENCLOSED ATTICS, SIZE PER CODE CALCULATION.
- 2 GENERAL NOTES
 SCALE: N.T.S.



THE DOOR WILL BE MADE OF ALUMINUM MILL-FINISH AND COLOR BLACK

3 NEW DOOR SCALE: N.T.S.

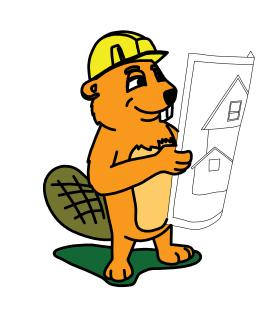

BEAVER'S DESIGN

(956) 662—3317 beavers.design@outlook.com

> INTERIOR REMODEL 718 GLENBRAE STREE HOUSTON, TX 77061

ISSUE LOG			
	DATE	DESCRIPTION	
PRE			
PMT			
\triangle			
2			
3			
	•		

PROJECT NO:

CHECKED BY:


DATE OF ISSUE:

SHEET No.

EXISTING FLOOR PLAN

SHEET No.

A1.0

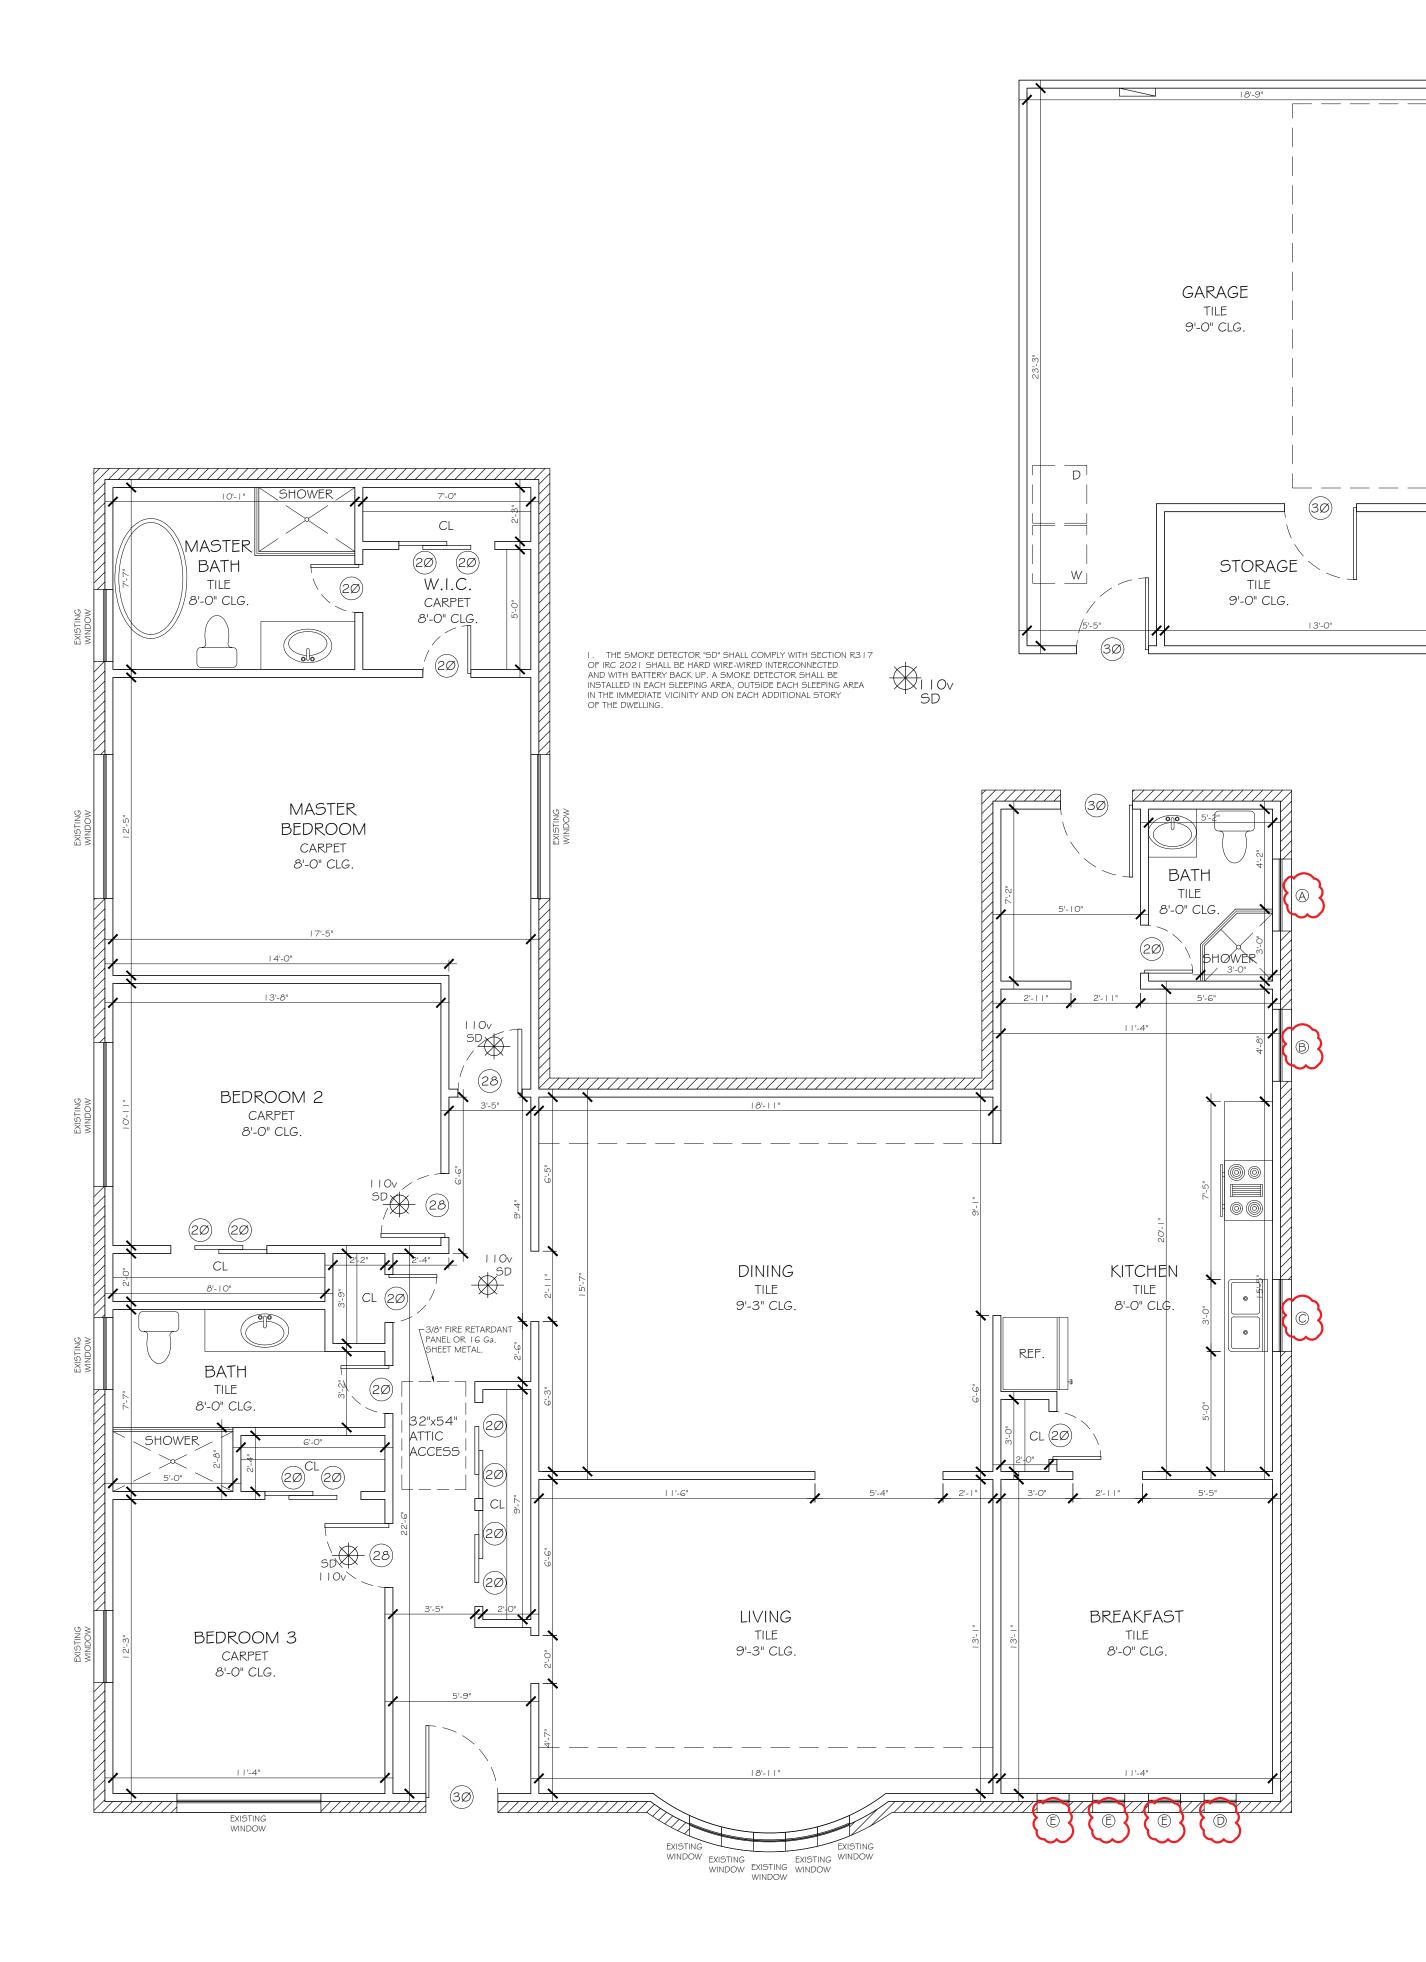

NOTE : DO NOT SCALE-OFF DIRECTLY FROM DRAWING. CONTRACTOR SHALL FIELD VERIFY DIMENSIONS.

- I. ALL CONSTRUCTION SHALL BE PERFORMED IN ACCORDANCE WITH APPLICABLE CODES, INCLUDING THE INTERNATIONAL BUILDING CODE AND CITY CODES. THE DRAWINGS AND SPECIFICATIONS ARE AN OUTLINE OF THE MINIMUM MATERIAL REQUIREMENTS AND THEIR APPLICATION.
- 2. BEFORE COMMENCING WORK, CONTRACTOR SHALL PERFORM A SURVEY OF EXISTING CONDITIONS IN ORDER TO VERIFY ACCURACY OF DIMENSIONS AND CONDITIONS SHOWN ON THE DRAWING WITH ACTUAL CONDITIONS. CONTRACTOR SHALL NOTIFY THE OWNER IMMEDIATELY OF ANY PROBLEMS FOUND THAT MAY AFFECT THE WORK. PROCEEDING WITH THE WORK SHALL CONSTITUTE ACCEPTANCE BY THE CONTRACTOR THAT CONDITIONS ARE CORRECT AND THE CONTRACTOR ASSUMES FULL RESPONSIBILITY FOR CONDITIONS.
- 3. ALL CONSTRUCTION SHALL BE COMPLETE, FINISHED, AND OF THE HIGHEST WORKMANSHIP. ALL CONSTRUCTION SHALL BE PERFORMED IN ACCORDANCE WITH THE REQUIREMENTS AND SPECIFICATIONS OF THE OWNER AND DESIGNER.
- 4. APPROVED PLANS AND SPECIFICATIONS SHALL NOT BE MODIFIED NOR CHANGED WITHOUT AUTHORIZATIONS FROM THE BUILDING OFFICIAL.
- I. THE CONSTRUCTION OF THIS DWELLING MUST COMPLY WITH INTERNATIONAL RESIDENTIAL CODE DO NOT SCALE-OFF DIRECTLY FROM DRAWING. CONTRACTOR SHALL VERIFY AND WORK WITH DIMENSIONS SHOWN. ALL DIMENSION SHALL BE VERIFY IN SITE.
- 2. SINGLE HUNG ALUMINUM WINDOWS UNO 8'-Ø" HEADER HT. AT IØ' Ø" PLATE 7'-8" HEADER HT. AT. 9' Ø" PLATE 6'-8" HEADER HT. AT 8' Ø" PLATE
- 3. CHIMNEYS TO BE 2'-Ø" (MIN.) ABV. ANY ROOF LINE WITHIN A 10/-0"
- 4. THE ATTIC ACCESS STAIRWAY SHALL COMPLY WITH SECTION M 1305.1.3
 AS AMENDED: ACCESS SHALL BE PROVIDED WITH A PULL DOWN STAIRWAY
 WITH A CLEAR OPENING NOT LESS THAN 22 INCHES IN WIDTH AND LOAD
 CAPACITY OF NOT LESS THAN 350 POUNDS. THE PASSAGEWAY SHALL
 HAVE CONTINUOUS SOLID FLOORING IN ACCORDANCE WITH CHAPTER 5
 OF THE IRC. AND NO LESS THAN 24 INCHES WIDE. A LEVEL SERVICE
 SPACE AT LEAST 30 INCHES DEEP AND 30 INCHES WIDE SHALL BE PRESENT
 ALONG ALL SIDE OF THE APPLIANCE WHERE ACCESS IS REQUIRED. THE
 CLEAR ACCESS OPENING DIMENSIONS SHALL BE MINIMUM OF 20 INCHES
 BY 30 INCHES, WHERE SUCH DIMENSIONS ARE LARGE ENOUGH TO ALLOW
 REMOVAL OF THE LARGEST APPLIANCE.
- 5. 6'-8" INTERIOR DOORS AT FIRST FLOOR6. WHERE WOOD FRAMING IS EXPOSED TO WATER SPLASHING, PROVIDE WATERPROOF PAPER FLASHING AND COUNTER FLASHING.
- 7. SEE OWNER/CONTRACTOR FOR WINDOW MANUFACTURER AND STYLES.
 WINDOW SUPPLIER TO LOCATE SAFETY GLASS AS REQUIRED & CERTIFY ALL
 WINDOW TO COMPLY WITH I.B.C. I.R.C. AND ENERGY CODE. PROVIDE
 MASTIC WRAP. WATERPROOFING AND CAULK SURROUND FLASHING ABOVE
 WINDOWS AND COUNTER-FLASH AS REQUIRED
- 8. ALL GLAZING LOCATED IN DOORS TO BE SAFETY GLAZING
 9. HOUSEHOLD VENTING SHALL BE OUTSIDE DWELLING. PROVIDE VENTILATION
 AT ALL BATHS AND UTILITY ROOMS VIA NATURAL OR MECHANICAL MEANS
 CAPABLE OF FIVE AIR CHANGES PER HOUR AND IS VENTED DIRECTLY
 OUTSIDE WITH A POINT OF DISCHARGE MIN.
- 10. HVAC INSTALLATION, SIZING, LOCATION IS THE RESPONSIBILITY OF A/C CONTRACTORS
- II. ALL LAVATORIES 2'-8" HIGH U.N.O.
 I2. ALL SHEETROCK CORNER TO BE ROUNDED, EXCLUDING CORNERS AT
- 13. CROSS VENTILATION AT ENCLOSED ATTICS, SIZE PER CODE CALCULATION.

2 GENERAL NOTES
SCALE: N.T.S.

PROYECT NUMBER: 25025414

ISSUANCE OF THIS PERMIT DOES NOT WAIVE COMPLIANCE WITH THE HISTORIC PRESERVATION ORDINANCE PER CITY OF HOUSTON MUNICIPAL CODE OF ORDINANCE CHAPTER 33 ARTICLE VII FOR MORE INFORMATION, CONTAC 832 393 G55G. REPAIR PERMIT IS FOR IN-KIND ROOF COVERING ONLY. NO ALTERATION TO FROM SIDING EXTERIOR CLADDING, OR TRIM WITHOUT REVIEW AND PERMIT. INTERIOR IS EXEMPT FROM HISTORIC REVIEW. NO ALTERATION OF EXTERIOR FEATURES INCLUDING, BUT NOT LIMITED TO, WINDOWS, SIDING, AND TRIM. NO REMOVAL ALTERATION TO INTERIOR SHIPLAP. ANY WORK TO EXTERIOR FEATURES (INCLUD WINDOWS, DOORS, EXTERIOR CLADDING, TRIM, PORCH ELEMENTS) REQUIRE HISTO REVIEW AND MAY REQUIRE A CERTIFICATE OF APPROPRIATENESS.

	REPLACE WINDOW			
QTY	ITEM CODE	DESCRIPTION	TYPE	
1	WINTOT	34 \(\frac{5}{8} \text{ X 35 SINGLE HUNG 1/1} \)	А	
1	WINTOI	34 § X 47 SINGLE HUNG 1/1	В	
1	WINTOI	34 § X 35 SINGLE HUNG 1/1	С	
1	WINTOI	$16\frac{3}{4}$ X 74 PICTURE WINDOW 1 LITE	D	
3	WINTOI	$16\frac{1}{2}X74$ PICTURE WINDOW 1LITE	E	

BEAVER'S DESIGN

(956) 662-3317 beavers.design@outlook.com

> INTERIOR REMODEL 7718 GLENBRAE STREET HOUSTON, TX 77061

ISSUE LOG		
	DATE	DESCRIPTION
PRE		
PMT		
Λ		
2		
3		
	ı	1

PROJECT NO:

CHECKED BY:

DATE OF ISSUE:

SHEET No.


PROPOSED FLOOR PLAN

SHEET No.


A1.2

1 PROPOSED FLOOR PLAN
SCALE: 1/4"=1'-0"



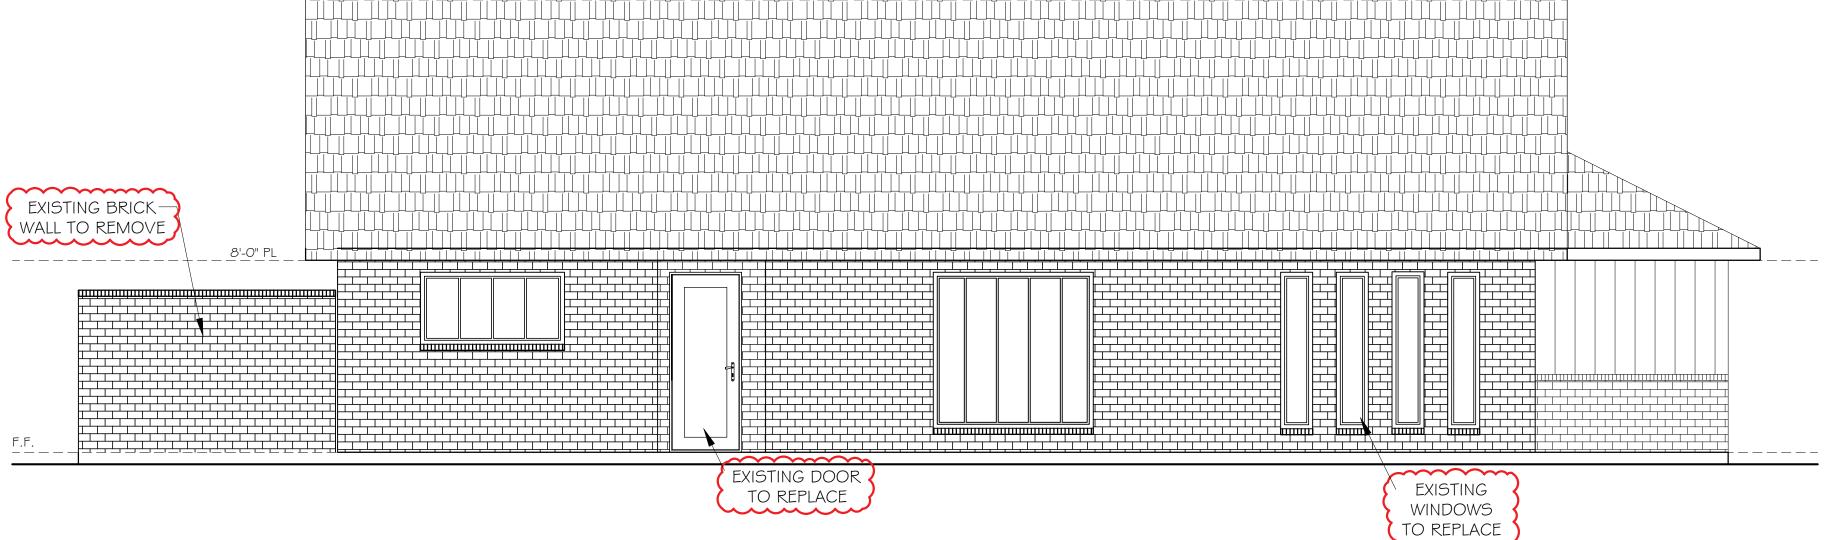

1 EXISTING FRONT ELEVATION SCALE: 1/4"=1'-0"

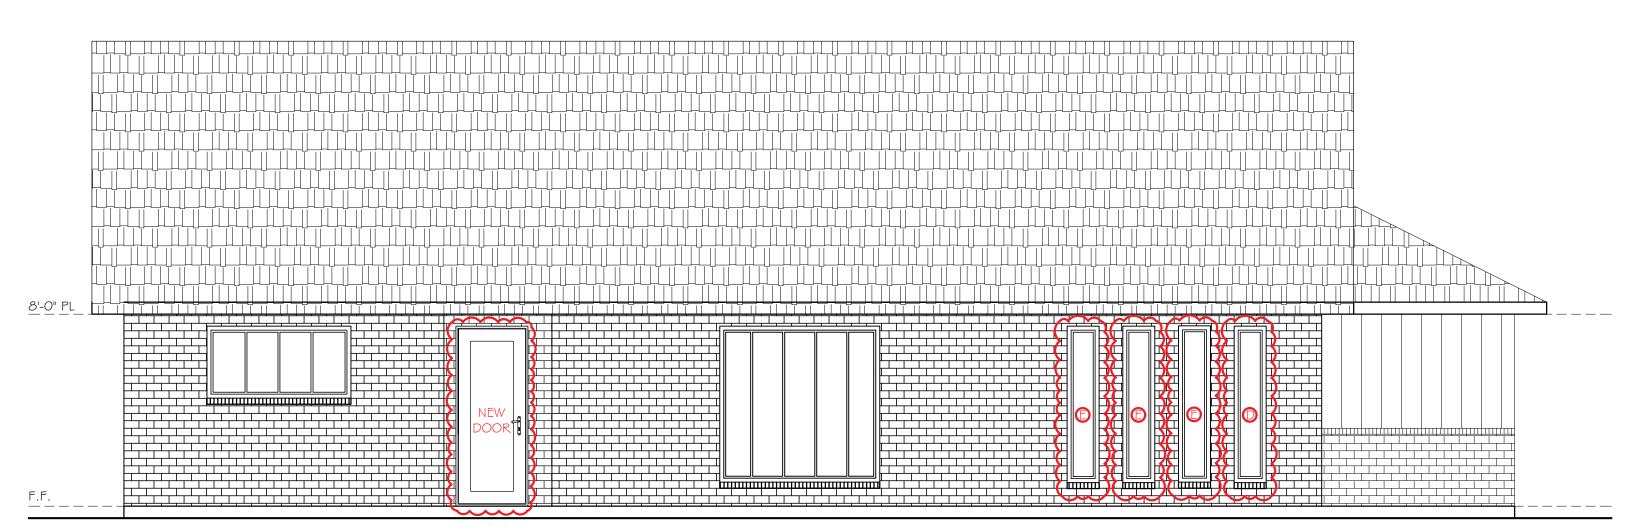

2 PROPOSED FRONT ELEVATION SCALE: 1/4"=1'-0"

- I. ALL EXTERIOR FINISHES, ROOFING, AND DETAILS SHALL BE INSTALLED PER MANUFACTURED SPECIFICATION AND COMPLY WITH U.L AND A.S.T.M. STANDARDS. BUILDERS/OWNERS WILL HIRE ONLY PROFESSIONAL CONTRACTORS TO PERFORM ANY CONSTRUCTION FOR THIS DWELLING. CONSTRUCTION WILL BE SUPERVISE BY THE BUILDER WHO WILL DETERMINE, GUIDE, REVIEW, INSPECT, APPROVE AND THEN CERTIFY ALL WORKMANSHIP OF SUBCONTRACTORS. DESIGNER IS NOT RESPONSIBLE FOR POOR, INCOMPLETE OR SUBSTANDARD WORKMANSHIP. ALL CONTRACTORS HIRED BY BUILDER MUST HAVE THE EXPERIENCE AND KNOWLEDGE TO PERFORM ACCORDING TO A.S.T.M. AND U.L. GENERAL INDUSTRY STANDARDS AND PRACTICES. WORK SHALL COMPLY WITH THE I.R.C. BOOK OF STANDARDS WHICH IS TO BE PROVIDED BY THE BUILDER TO SUBCONTRACTORS AND KEEP ON SITE THROUGH THE DURATION OF CONSTRUCTION. DESIGNER DOES NOT CERTIFY OR APPROVE THE QUALIFICATIONS OF ANY BUILDER, HIS ASSIGNS, OR SUBCONTRACTORS. ON SITE SUPERVISION IS NOT PART OF DESIGNER GENERAL SERVICES.
- 2. SEE ELEVATION AND DETAIL SHEET FOR TYPICAL FASCIA AND SOFFIT CORNICE DESIGN. REFER TO BUILDER FOR EXACT MATERIAL SPECIFICATION AND EXACT CONSTRUCTION ASSEMBLY
- 3. VERTICAL & HORIZONTAL EXPANSION JOINTS, WEEP HOLES, AND BRICK TIES AS REQ'D.-LOCATED BY BLDR./CONTRACTORS AS PER B.I.A. AND ASTM MASONRY
- 4. INSULATION PER OWNER/ BLDR.. SELECTION, MIN. R-13 WALL, R-19 SLOPE ROOF AND KNEE WALL, R-30 @ ATTIC
- 5. BUILDER WILL USE MINIMUM (CLASS B SHINGLES) WITH A 30 YR. MANUF. WARRANTY FOR COMPOSITION ROOF OVER 30 LB., FELT PAPER UNDERLAY, MINIMUM 7/16 OSB ROOF DECKING WITH TECH SHIELD IF REQUESTED. BUILDER SHALL INSTALL PASSIVE DESIGNED CONTINUOUS SOFFIT AND RIDGE VENTS PER MANUFACTURER SPECIFICATIONS AND A.S.T.M.
- STANDARDS. POWER VENTS IF REQUIRED.

 6. ALL STONE TO BE CULTURED UNLESS NOTED OTHERWISE
- 7. ALL CHIMNEY STACKS TO RISE MINIMUM 2'-O" ABOVE ANY ROOF OS STRUCTURED WITHIN A 10'-O" RADIUS AND BE FITTED WITH A U.L. APPROVE SPARK ARRESTOR IF REQUIRED. FLASH AND CRICKET AROUND CHIMNEY AS REQUIRED. ANY DECORATIVE CHIMNEY CAP OR COVERS TO BE FABRICATED FROM NON COMBUSTIBLE METAL MATERIAL, ALLOW FOR FULL UNOBSTRUCTED VENTILATION. SEE MANF. SHOP DRAWINGS FOR ALL DETAILS.
- 8. PLUMBER TO SIZE AND LOCATE VENT STACKS TO EXTEND THROUGH ROOF DECK AND TERMINATED MOT LESS THAN I 2" AWAY FROM ANY STRUCTURE. ALL PENETRATIONS TO BE SEALED AND FLASHED AS REQUIRED. LOCATE VENT STACKS ON REAR SIDE OF MAIN RIDGE IF POSSIBLE OR OUT OF VIEW FROM FRONT ELEVATION, PAINT STACKS TO MATCH ROOF COLOR.
- 9. ALL VENTING FOR APPLIANCE, MECHANICAL EQUIPMENT, OR COMBUSTION PRODUCING MACHINERY SHALL HAVE CONTINUOUS PIPING FROM SOURCE TO OUTSIDE. PIPES OR DUCTS SHALL BE FABRICATED FROM MATERIALS WITH SPECIFIC SIZE AND TERMINATED TO OUTSIDE AT A DISTANCE SPECIFIED BY MANUFACTURED. ALL OPENINGS OR PENETRATIONS FOR SUCH EQUIPMENT, A/C COILS, APPLIANCE, PLUMBING, AND ELECTRICAL SHALL HAVE GALV. METAL COVERS WILL BE SEALED TO PREVENT WATER OR MOISTER FROM ENTERING INTO WALL OR CEILING CAVITY. SEE MANUFACTURER SPECS. FOR DIRECT VENT AND GAS LOG FIRE BOX ASSEMBLY AND TERMINATION INCLUDING PROTECTIVE SAFETY SHIELD AND MINIMAL SURROUND CLEARANCE FOR HOT VENT PIPES. ALL SIZING FOR PIPES OR DUCTS TO BE DETERMINED BY MANUFACTURED AND SHALL COMPLY WITH U.L AND A.S.T.M. STANDARDS OR GUIDELINES. DUCTWORK SHALL INCLUDE DEVICE TO PREVENT BACK DRAFT AND EXHAUST FROM RE-ENTERING BUILDING. TERMINATION SHALL BE LOCATED NOT CLOSER THAN 36" MINIMUM FROM ANY OPENING SUCH AS A DOOR OR A WINDOW LEADING DIRECTLY INTO THE BUILDING. ABSOLUTELY NO VENTING OF ANY KIND INTO ATTIC, GARAGE, WALL, OR CEILING CAVITIES.
- I O. ALL A/C COILS & ELEC. PENETRATION TO BE PLACED THROUGH GALV. COUNTER
 FLASH DUCT AND SEALED W/ NON-COMBUSTIBLE PERM.FOAM INSULATION

 L.L. OWNER / BUILDER TO APPROVED AND LOCATE ALL CUTTERS AND DOWN SPOLITS.
- I I. OWNER / BUILDER TO APPROVED AND LOCATE ALL GUTTERS AND DOWN SPOUTS W/ CONTRACTOR AND TIE INTO LANDSCAPE DRAIN AS REQUIRED.
- I 2. TYPICAL VERTICAL ELEVATION DIMENSION TAKEN FROM TOP OF SLABS. ALL DIMENSION ARE NOMINAL NOT ACTUAL, ADJUST ACTUAL SIZES ACCORDINGLY.

3 GENERAL NOTES

	REPLACE WINDOW				
QTY	ITEM CODE	DESCRIPTION	TYPE		
1	WINIOI	$34\frac{5}{8}$ X 35 SINGLE HUNG 1/1	А		
1	WINIOI	$34\frac{5}{8}X47$ SINGLE HUNG 1/1	В		
1	WINIOI	$34\frac{5}{8}$ X 35 SINGLE HUNG 1/1	С		
1	WINTOI	$16\frac{3}{4}$ X 74 PICTURE WINDOW 1 LITE	D		
3	WINIOI	16½ X 74 PICTURE WINDOW 1 LITE	E		
3	WINTOT	16 ½ X /4 PICTURE WINDOW TLITE			



THE DOOR WILL BE MADE OF ALUMINUM MILL-FINISH AND COLOR BLACK

4 NEW DOOR SCALE: N.T.S.



BEAVER'S DESIGN

(956) 662—3317 beavers.design@outlook.com

> INTERIOR REMODEL 7718 GLENBRAE STREET HOUSTON, TX 77061

ISSUE LOG DATE DESCRIPTION PRE PMT A A A A A

PROJECT NO:

CHECKED BY:

DATE OF ISSUE:

SHEET No.

ELEVATIONS

SHEET No.


A2.0



	REPLACE WINDOW				
QTY	ITEM CODE	DESCRIPTION	TYPE		
1	WINTOT	34 ½ X 35 SINGLE HUNG 1/1	Α		
1	WINTOI	34 \frac{5}{8} X 47 SINGLE HUNG 1/1	В		
1	WINTOI	34 \frac{5}{8} X 35 SINGLE HUNG 1/1	С		
1	WINTOI	$16\frac{3}{4}$ X 74 PICTURE WINDOW 1 LITE	D		
3	WINTOI	16 ½ X 74 PICTURE WINDOW 1 LITE	E		

- I. ALL EXTERIOR FINISHES, ROOFING, AND DETAILS SHALL BE INSTALLED PER MANUFACTURED SPECIFICATION AND COMPLY WITH U.L AND A.S.T.M. STANDARDS. BUILDERS/OWNERS WILL HIRE ONLY PROFESSIONAL CONTRACTORS TO PERFORM ANY CONSTRUCTION FOR THIS DWELLING. CONSTRUCTION WILL BE SUPERVISE BY THE BUILDER WHO WILL DETERMINE, GUIDE, REVIEW, INSPECT, APPROVE AND THEN CERTIFY ALL WORKMANSHIP OF SUBCONTRACTORS. DESIGNER IS NOT RESPONSIBLE FOR POOR, INCOMPLETE OR SUBSTANDARD WORKMANSHIP. ALL CONTRACTORS HIRED BY BUILDER MUST HAVE THE EXPERIENCE AND KNOWLEDGE TO PERFORM ACCORDING TO A.S.T.M. AND U.L. GENERAL INDUSTRY STANDARDS AND PRACTICES. WORK SHALL COMPLY WITH THE I.R.C. BOOK OF STANDARDS WHICH IS TO BE PROVIDED BY THE BUILDER TO SUBCONTRACTORS AND KEEP ON SITE THROUGH THE DURATION OF CONSTRUCTION. DESIGNER DOES NOT CERTIFY OR APPROVE THE QUALIFICATIONS OF ANY BUILDER, HIS ASSIGNS, OR SUBCONTRACTORS. ON SITE SUPERVISION IS NOT PART OF DESIGNER GENERAL 2. SEE ELEVATION AND DETAIL SHEET FOR TYPICAL FASCIA AND SOFFIT CORNICE DESIGN. REFER TO BUILDER FOR EXACT MATERIAL SPECIFICATION AND EXACT CONSTRUCTION ASSEMBLY
- 3. VERTICAL # HORIZONTAL EXPANSION JOINTS, WEEP HOLES, AND BRICK TIES AS REQ'D.-LOCATED BY BLDR./CONTRACTORS AS PER B.I.A. AND ASTM MASONRY
- STANDARDS.
- 4. INSULATION PER OWNER/ BLDR.. SELECTION, MIN. R-13 WALL, R-19 SLOPE ROOF AND KNEE WALL, R-30 @ ATTIC
- 5. BUILDER WILL USE MINIMUM (CLASS B SHINGLES) WITH A 30 YR. MANUF. WARRANTY FOR COMPOSITION ROOF OVER 30 LB., FELT PAPER UNDERLAY, MINIMUM 7/16 OSB ROOF DECKING WITH TECH SHIELD IF REQUESTED. BUILDER SHALL INSTALL PASSIVE DESIGNED CONTINUOUS SOFFIT AND RIDGE VENTS PER MANUFACTURER SPECIFICATIONS AND A.S.T.M. STANDARDS. POWER VENTS IF REQUIRED.
- 6. ALL STONE TO BE CULTURED UNLESS NOTED OTHERWISE
- 7. ALL CHIMNEY STACKS TO RISE MINIMUM 2'-O" ABOVE ANY ROOF OS STRUCTURED WITHIN A 10'-0" RADIUS AND BE FITTED WITH A U.L. APPROVE SPARK ARRESTOR IF REQUIRED. FLASH AND CRICKET AROUND CHIMNEY AS REQUIRED. ANY DECORATIVE CHIMNEY CAP OR COVERS TO BE FABRICATED FROM NON COMBUSTIBLE METAL MATERIAL, ALLOW FOR FULL UNOBSTRUCTED VENTILATION. SEE MANF. SHOP
- DRAWINGS FOR ALL DETAILS. 8. PLUMBER TO SIZE AND LOCATE VENT STACKS TO EXTEND THROUGH ROOF DECK AND TERMINATED MOT LESS THAN 12" AWAY FROM ANY STRUCTURE. ALL PENETRATIONS TO BE SEALED AND FLASHED AS REQUIRED. LOCATE VENT STACKS ON REAR SIDE OF MAIN RIDGE IF POSSIBLE OR OUT OF VIEW FROM FRONT
- ELEVATION, PAINT STACKS TO MATCH ROOF COLOR. 9. ALL VENTING FOR APPLIANCE, MECHANICAL EQUIPMENT, OR COMBUSTION PRODUCING MACHINERY SHALL HAVE CONTINUOUS PIPING FROM SOURCE TO OUTSIDE. PIPES OR DUCTS SHALL BE FABRICATED FROM MATERIALS WITH SPECIFIC SIZE AND TERMINATED TO OUTSIDE AT A DISTANCE SPECIFIED BY MANUFACTURED. ALL OPENINGS OR PENETRATIONS FOR SUCH EQUIPMENT, A/C COILS, APPLIANCE, PLUMBING, AND ELECTRICAL SHALL HAVE GALV. METAL COVERS WILL BE SEALED TO PREVENT WATER OR MOISTER FROM ENTERING INTO WALL OR CEILING CAVITY. SEE MANUFACTURER SPECS. FOR DIRECT VENT AND GAS LOG FIRE BOX ASSEMBLY AND TERMINATION INCLUDING PROTECTIVE SAFETY SHIELD AND MINIMAL SURROUND CLEARANCE FOR HOT VENT PIPES. ALL SIZING FOR PIPES OR DUCTS TO BE DETERMINED BY MANUFACTURED AND SHALL COMPLY WITH U.L AND A.S.T.M. STANDARDS OR GUIDELINES. DUCTWORK SHALL INCLUDE DEVICE TO PREVENT BACK DRAFT AND EXHAUST FROM RE-ENTERING BUILDING. TERMINATION SHALL BE LOCATED NOT CLOSER THAN 36" MINIMUM FROM ANY OPENING SUCH AS A DOOR OR A WINDOW LEADING DIRECTLY INTO THE BUILDING. ABSOLUTELY NO VENTING OF ANY KIND INTO ATTIC, GARAGE, WALL, OR CEILING CAVITIES.
- IO. ALL A/C COILS # ELEC. PENETRATION TO BE PLACED THROUGH GALV. COUNTER FLASH DUCT AND SEALED W/ NON-COMBUSTIBLE PERM.FOAM INSULATION II. OWNER / BUILDER TO APPROVED AND LOCATE ALL GUTTERS AND DOWN SPOUTS W/ CONTRACTOR AND TIE INTO LANDSCAPE DRAIN AS REQUIRED.
- I 2. TYPICAL VERTICAL ELEVATION DIMENSION TAKEN FROM TOP OF SLABS. ALL DIMENSION ARE NOMINAL NOT ACTUAL, ADJUST ACTUAL SIZES ACCORDINGLY.

3 GENERAL NOTES
SCALE: N.T.S.

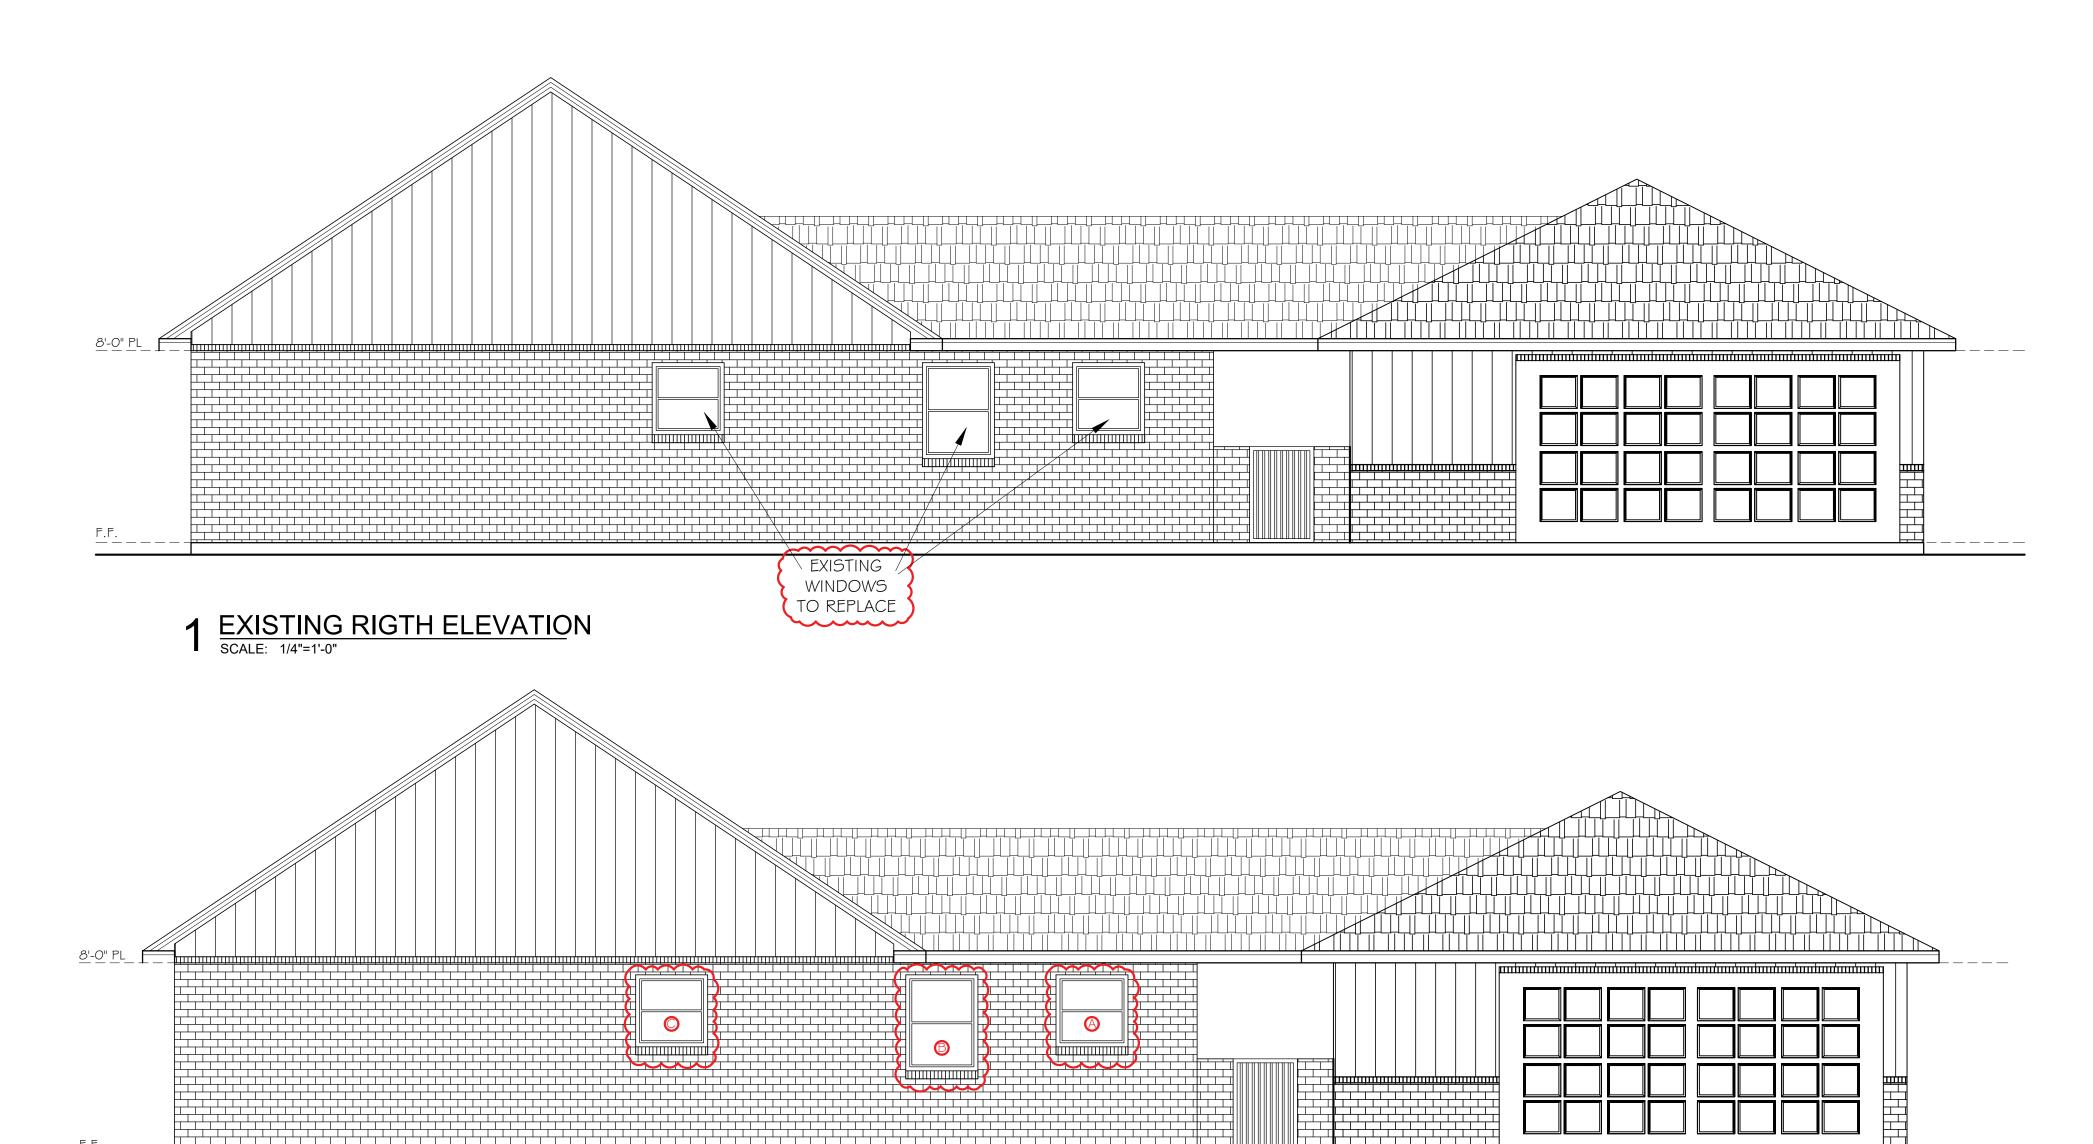

2 PROPOSED RIGTH ELEVATION SCALE: 1/4"=1'-0"



(956) 662-3317


beavers.design@outlook.com


	ISSUE LOG		
		DATE	DESCRIPTION
,	PRE		
	PMT		
•	2		
	3		

PROJECT NO: CHECKED BY: DATE OF ISSUE: SHEET No.

ELEVATIONS

SHEET No.

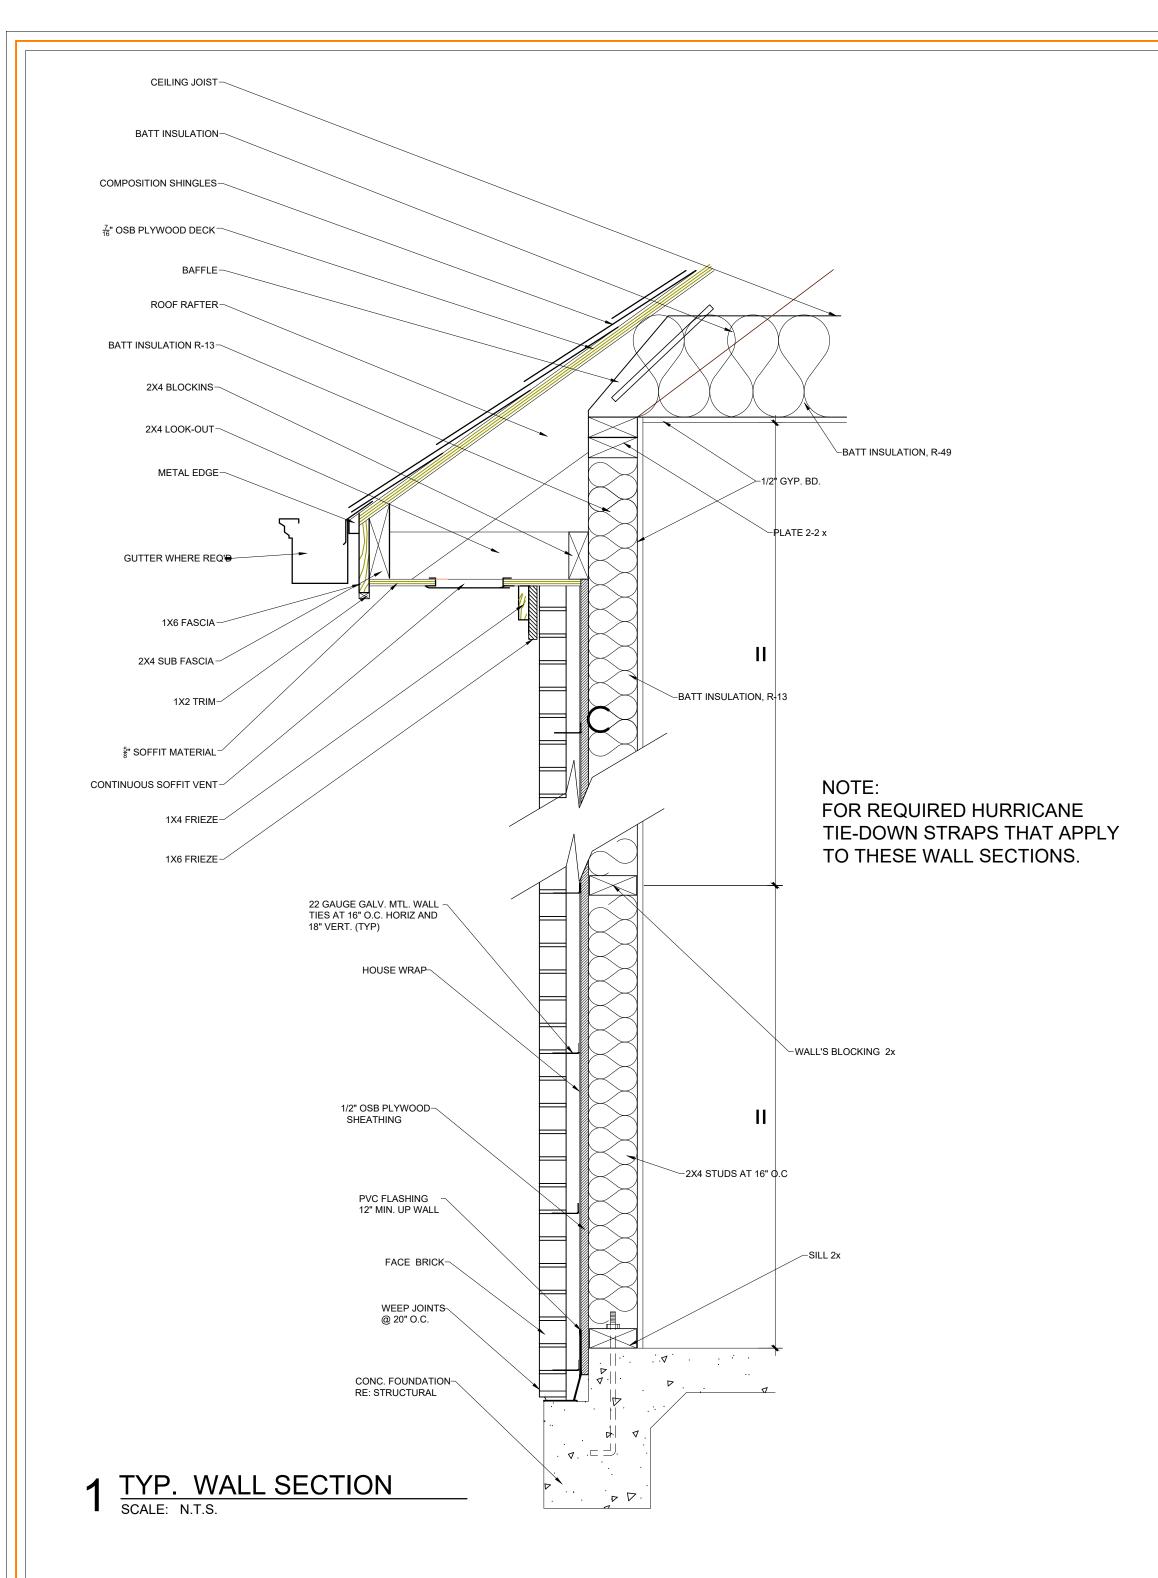

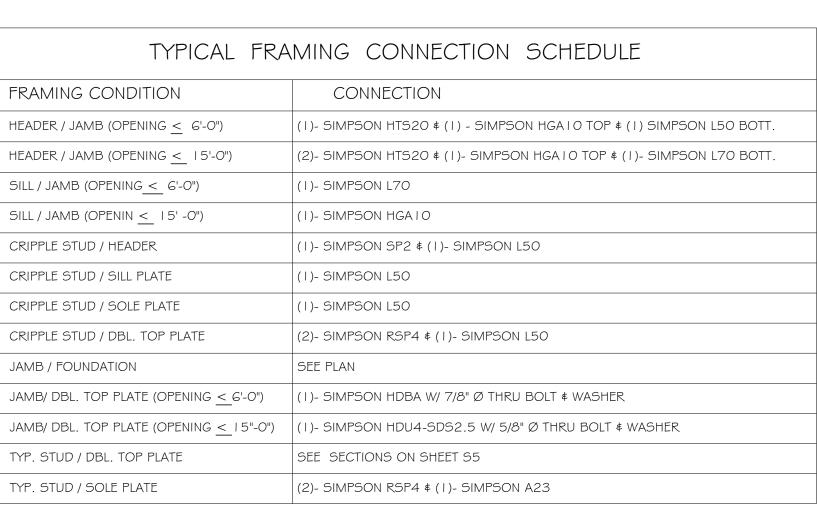




01/26/2024

Prescriptive Method: R-Value Computation

To show energy conservation compliance using the R-Value Computation Compliance Method (Table R402.1.3 of the 2021 IECC) specify the following required insulation and fenestration values for Climate Zone 2:

- Maximum Fenestration U-Factor: 0.40 (0.65 for Skylights*)
- Maximum Glazed Fenestration SHGC: 0.25
- Minimum Ceiling R-Value: 49
- Minimum Wall R-Value: 13
- Minimum Floor R-Value: 13
- Minimum Duct Insulation R-Value: 8 in attics
- Minimum Duct Insulation R-Value: 6 in other portions of home
- * Skylights may be excluded from glazed fenestration SHGC requirements in climate zones 1 through 3 where the SHGC for such skylights does not exceed 0.30

PO Box 1562 | Houston, Texas 77251-1562 | HoustonPublicWorks.org
Capital Projects | Customer Account Services | Houston Permitting Center | Houston Water | Transportation & Drainage Operations

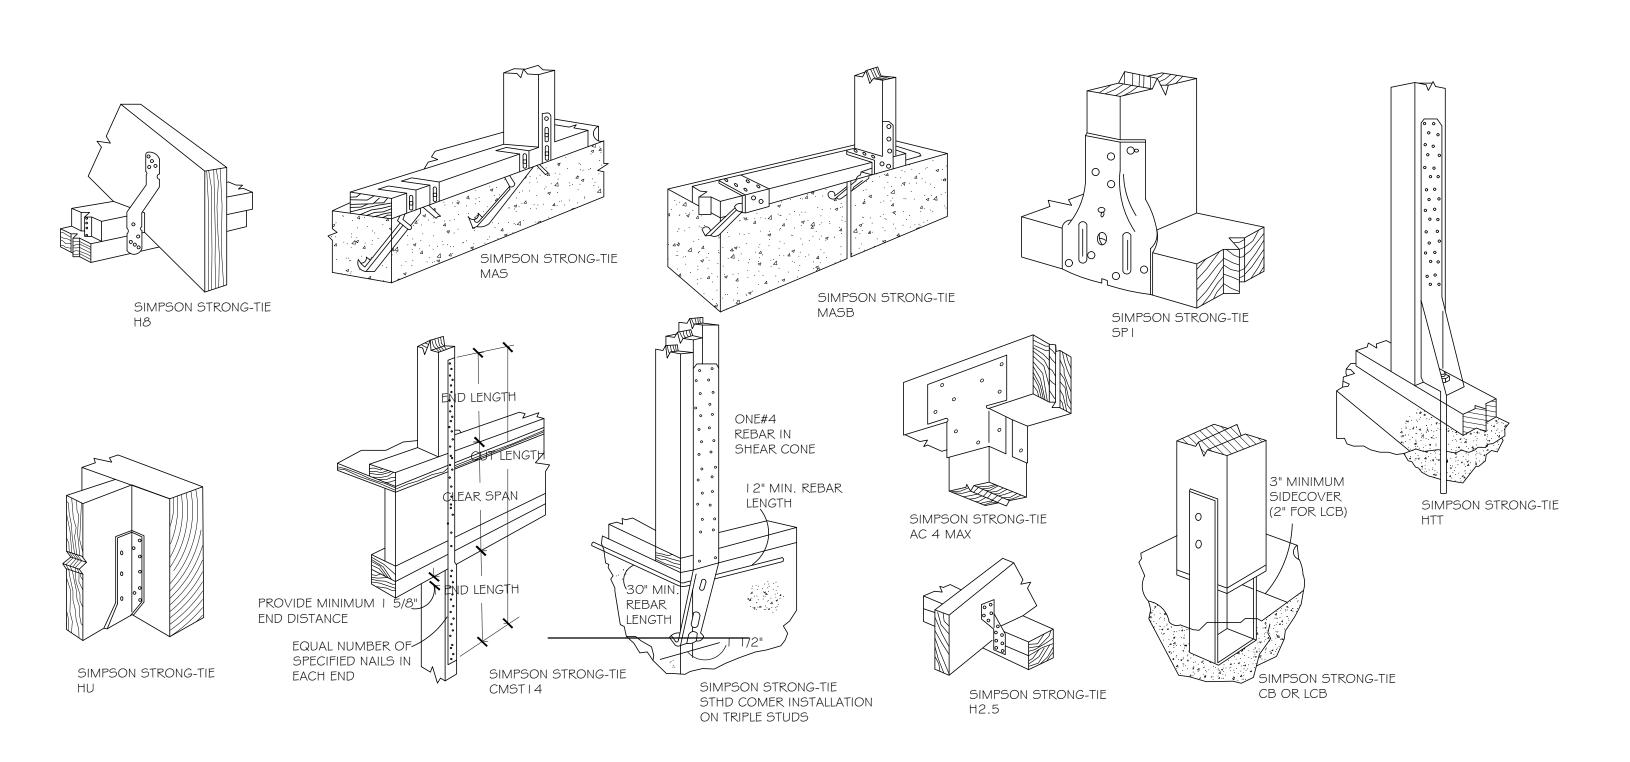

2 ANCHORAGE AND STRAPPING DETAILS SCALE: N.T.S.





INTERIOR REMODEL 7718 GLENBRAE STREET HOUSTON, TX 77061

	IS:	SUE LOG
	DATE	DESCRIPTION
PRE		
РМТ		
\triangle		
2		
3		

PROJECT NO:

CHECKED BY:

DATE OF ISSUE:

SHEET No.

DETAILS

SHEET No.

S1.0

STAR WINDOWS CORP

11738 Ashworth Houston TX 77050

Phone # 281-219-3434 Fax # 281-227-7117

starwindowscorp@yahoo.com

Date	Invoice #
8/5/2025	30017


Bill To	
ENRIQUE SANCHEZ	900

Ship To	No. of Lot,	272 Jan 1	39(2)(6)	

P.O. Number	Terms	Rep		YPE GLASS		CPU/DEL
OTY	ltem Code	ALUMINU DOUBLE I: LOWE / CI ARGON G. NO FINS	LR	0	Price Each	Amount
1 1 1 3 3 7	WINIOI WINIOI WINIOI WINIOI WINIOI WINIOI SCREEN SERVIOI	34 5/8 X 47 34 5/8 X 35 16 3/4 X 74	SINGLE HUNG 1/1 SINGLE HUNG 1/1 SINGLE HUNG 1/1 PICTURE WINDOW PICTURE WINDOW		188.00 212.00 188.00 241.00 241.00 12.00	188.007 212.007 188.007 241.007 723.007 36.000 70.600
				Subto	tal	\$1,658.00
				Sales	Tax (8.25%)	\$136,79
				Total		\$1,794,7
					ents/Credits te Due	-\$859.5



Historic Window Standard: New Construction & Replacement

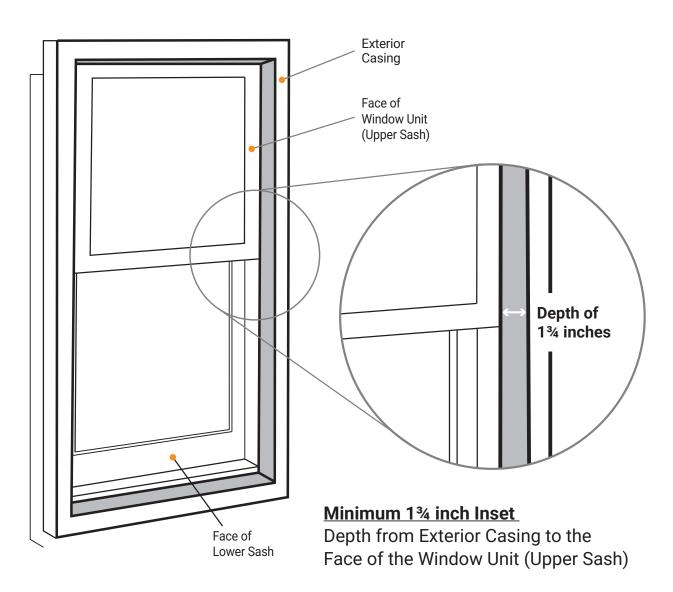

Windows must be 1-over-1 (equally horizontally divided)

1¾ inch minimum inset for Fixed Window

For more information contact:

Houston Office of Preservation 832-393-6556 historicpreservation@houstontx.gov